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## CITY OF GAINESVILLE NOTES

- THE METHOD AND MANNER OF PERFORMING THE WORK AND THE QUALITIES OF MATERIAL FOR CONSTRUCTION WITHIN THE ROW SHALL CONFORM TO THE REQUIREMENTS SPECIFIED BY THE PUBLIC WORKS DEPARTMENT.
- NO WORK SHALL BE DONE NOR MATERIALS USED IN THE ROW, WITHOUT INSPECTION BY THE PUBLIC WORKS DEPARTMENT (352-334-5070), AND THE CONTRACTOR/DEVELOPER SHALL FURNISH THE DEPARTMENT WITH EVERY REASONABLE FACILITY FOR ASCERTAINING WHETHER THE WORK PERFORMED AND MATERIALS USED ARE IN ACCORDANCE WITH THE REQUIREMENTS AND INTENT OF THE PLANS AND SPECIFICATIONS.
- THE PUBLIC WORKS DEPARTMENT RESERVES THE RIGHT TO MODIFY THE PROPOSED WORK WITHIN THE ROW TO ENSURE COMPATIBILITY WITH EXISTING IMPROVEMENTS. SUCH MODIFICATION COSTS SHALL BE BORNE BY THE DEVELOPER.
- EXACT LIMITS OF ROADWAY AND SIDEWALK TO BE REMOVED WILL BE DETERMINED BY CITY PUBLIC WORKS INSPECTION STAFF. ANY NON-COMPLIANT OR DAMAGED AREAS DUE TO CONSTRUCTION WITHIN THE RIGHT-OF-WAY SHALL BE REMOVED AND REPLACED PRIOR TO FINAL ACCEPTANCE.
- THE CONTRACTOR SHALL INSTALL ALL UNDERGROUND STORM WATER PIPING PER MANUFACTURER'S RECOMMENDATIONS.
- ALL REQUIRED BACKFILL WITHIN THE ROW SHALL BE DOCUMENTED WITHIN A FDOT TYPE DENSITY LOG BOOK, COMPILED AND MAINTAINED BY THE CONTRACTOR, AND SHALL BE AVAILABLE FOR REVIEW BY THE PUBLIC WORKS INSPECTOR AT ALL TIMES AND IMMEDIATELY UPON REQUEST. THE LOG BOOK WILL BE REVIEWED FOR COMPLIANCE TO SPECIFICATIONS BY CITY STAFF PRIOR TO ANY EARTHWORK STARTING. THE LOG BOOK SHALL CONTAIN PROCTORS, LBRS, SOIL CLASSIFICATIONS, ETC. AS REQUIRED BY SPECIFICATION. THE LOG BOOK SHALL BE SIGNED AND SEALED BY THE PROFESSIONAL ENGINEER RESPONSIBLE FOR MATERIALS TESTING AND PROVIDED TO THE PUBLIC WORKS DEPARTMENT FOR REVIEW AND TCO ACCEPTANCE AS PART OF THE CLOSEOUT DOCUMENTS.
- THE INSITU MATERIAL FOR ALL DRY RETENTION POUNDS WILL BE TESTED BY A GEOTECHNICAL ENGINEER USING APPROPRIATE METHODOLOGIES SUCH AS ONSITE TESTING WITH A DOUBLE-RING INFILTROMETER OR TRENCH TEST, OR COLLECTION OF AN UNDISTURBED SAMPLE FOR TESTING SUCH AS A SHELBY TUBE TO DEMONSTRATE THAT IT IS NOT LESS THAN THE DESIGN INFILTRATION TEST RESULTS SHALL BE SUBMITTED TO THE CITY FOR APPROVAL. THE COST SHALL BE BORNE BY THE CONTRACTOR.
- POST INSTALLATION VIDEO INSPECTIONS IN ACCORDANCE WITH FDOT SPECIFICATIONS SHALL BE REQUIRED FOR ALL PIPE IN THE CITY RIGHT-OF-WAY AND THE COST SHALL BE BORNE BY THE CONTRACTOR.
- THE CONTRACTOR SHALL PROVIDE THE CITY WITH AN INTERIM AS-BUILT SURVEY OF THE RETENTION/DETENTION BASIN(S) AND ASSOCIATED CONTROL STRUCTURES THAT MUST BE PREPARED BY A REGISTERED LAND SURVEYOR. THE SURVEY SHALL PROVIDE VERTICAL AND HORIZONTAL EXTENTS OF THE STORMWATER BASINS AND ELEVATION OF CONTROL STRUCTURES AND CONFIRM THE STORMWATER SYSTEM IS IN CONFORMANCE WITH APPROVED PLANS PRIOR TO PERMANENTLY COVERING OR BURYING THE BASINS. THE SURVEY SHALL BE IN ACCORDANCE WITH STANDARDS IDENTIFIED IN THE CURRENT CITY OF GAINESVILLE ENGINEERING AND DESIGN CONSTRUCTION MANUAL SECTION 7.4.
- ALL WORK WITHIN OR ON CITY OWNED AND MAINTAINED FACILITIES, ROW OR EASEMENTS, AS WELL AS ALL STORMWATER INFRASTRUCTURE, WHETHER ON PRIVATE OR PUBLIC PROPERTY, SHALL REQUIRE AS-BUILT PLANS. AS-BUILT SURVEYS MUST MEET THE CRITERIA PROVIDED IN SECTION 7.4 OF THE CURRENT CITY OF GAINESVILLE ENGINEERING DESIGN AND CONSTRUCTION MANUAL.
- PRIOR TO ANY WORK BEING PERFORMED WITH THE CITY ROW, INCLUDING A CONSTRUCTION ENTRANCE, A ROW OBSTRUCTION PERMIT IS REQUIRED. AT NO TIME ARE VEHICLES OR EQUIPMENT ALLOWED TO JUMP THE CITY CURB. EMAIL DG\_PW\_PERMITS@CITYOFGAINESVILLE.ORG FOR A ROW OBSTRUCTION PERMIT APPLICATION.

## GENERAL CONSTRUCTION NOTES

- THE CONTRACTOR AND SUBCONTRACTORS SHALL OBTAIN A COPY OF THE FLORIDA DEPARTMENT OF TRANSPORTATION "STANDARD SPECIFICATIONS FOR ROAD AND BRIDGE CONSTRUCTION" (LATEST EDITION) AND BECOME FAMILIAR WITH THE CONTENTS PRIOR TO COMMENCING WORK.
- THE CONTRACTOR SHALL BE RESPONSIBLE FOR FURNISHING ALL MATERIAL AND LABOR TO CONSTRUCT THE FACILITY AS SHOWN AND DESCRIBED IN THE CONSTRUCTION DOCUMENTS IN ACCORDANCE WITH THE APPROPRIATE APPROVING AUTHORITIES, SPECIFICATIONS AND REQUIREMENTS. CONTRACTOR SHALL CLEAR AND GRUB ALL AREAS UNLESS OTHERWISE INDICATED, REMOVING TREES, STUMPS, ROOTS, MUCK, EXISTING PAVEMENT AND ALL OTHER DELETERIOUS MATERIAL.
- EXISTING UTILITIES SHOWN ARE LOCATED ACCORDING TO THE INFORMATION AVAILABLE TO THE ENGINEER AT THE TIME OF THE TOPOGRAPHIC SURVEY AND HAVE NOT BEEN INDEPENDENTLY VERIFIED BY THE OWNER OR THE ENGINEER. GUARANTEE IS NOT MADE THAT ALL EXISTING UNDERGROUND UTILITIES ARE SHOWN OR THAT THE LOCATION OF THOSE SHOWN ARE ENTIRELY ACCURATE. FINDING THE ACTUAL LOCATION OF ANY EXISTING UTILITIES IS THE CONTRACTOR'S RESPONSIBILITY AND SHALL BE DONE BEFORE HE COMMENCES ANY WORK IN THE VICINITY. FURTHERMORE, THE CONTRACTOR SHALL BE FULLY RESPONSIBLE FOR ANY AND ALL DAMAGES DUE TO THE CONTRACTOR'S FAILURE TO EXACTLY LOCATE AND PRESERVE ANY AND ALL UNDERGROUND UTILITIES. THE OWNER OR ENGINEER WILL ASSUME NO LIABILITY FOR ANY DAMAGES SUSTAINED OR COST INCURRED BECAUSE OF THE OPERATIONS IN THE VICINITY OF EXISTING UTILITIES OR STRUCTURES, NOR FOR TEMPORARY BRACING AND SHORING OF SAME. IF IT IS NECESSARY TO SHORE, BRACE, SWING OR RELOCATE A UTILITY, THE UTILITY COMPANY OR DEPARTMENT AFFECTED SHALL BE CONTACTED AND THEIR PERMISSION OBTAINED REGARDING THE METHOD TO USE FOR SUCH WORK.
- IT IS THE CONTRACTOR'S RESPONSIBILITY TO CONTACT THE VARIOUS UTILITY COMPANIES WHICH MAY HAVE BURIED OR AERIAL UTILITIES WITHIN OR NEAR THE CONSTRUCTION AREA BEFORE COMMENCING WORK. THE CONTRACTOR SHALL PROVIDE 48 HOURS MINIMUM NOTICE TO ALL UTILITY COMPANIES PRIOR TO BEGINNING CONSTRUCTION. A LIST OF THE UTILITY COMPANIES WHICH THE CONTRACTOR MUST CALL BEFORE COMMENCING WORK IS PROVIDED ON THE COVER SHEET OF THESE CONSTRUCTION PLANS. THIS LIST SERVES AS A GUIDE ONLY AND IS NOT INTENDED TO LIMIT THE UTILITY COMPANIES WHICH THE CONTRACTOR MAY WISH TO NOTIFY.
- THE CONTRACTOR SHALL BE RESPONSIBLE FOR OBTAINING ALL REQUIRED CONSTRUCTION PERMITS AND BONDS IF REQUIRED PRIOR TO CONSTRUCTION.
- THE CONTRACTOR SHALL HAVE AVAILABLE AT THE JOB SITE AT ALL TIMES ONE COPY OF THE CONSTRUCTION DOCUMENTS INCLUDING PLANS, SPECIFICATIONS, AND SPECIAL CONDITIONS AND COPIES OF ANY REQUIRED CONSTRUCTION PERMITS.
- ANY DISCREPANCIES ON THE DRAWINGS SHALL BE IMMEDIATELY BROUGHT TO THE ATTENTION OF THE OWNER AND ENGINEER BEFORE COMMENCING WORK. NO FIELD CHANGES OR DEVIATIONS FROM DESIGN ARE TO BE MADE WITHOUT PRIOR APPROVAL OF THE OWNER AND NOTIFICATION TO THE ENGINEER.
- ALL COPIES OF COMPACTION, CONCRETE AND OTHER REQUIRED TEST RESULTS ARE TO BE SENT TO THE OWNER AND DESIGN ENGINEER OF RECORD DIRECTLY FROM THE TESTING AGENCY.
- THE CONTRACTOR SHALL BE RESPONSIBLE FOR SUBMITTING TO THE ENGINEER A CERTIFIED RECORD SURVEY SIGNED AND SEALED BY A PROFESSIONAL LAND SURVEYOR REGISTERED IN THE STATE OF FLORIDA DEPICTING THE ACTUAL FIELD LOCATION OF ALL CONSTRUCTED IMPROVEMENTS THAT ARE REQUIRED BY THE JURISDICTIONAL AGENCIES FOR THE CERTIFICATION PROCESS. ALL SURVEY COSTS WILL BE THE CONTRACTORS RESPONSIBILITY.
- THE PRESENCE OF GROUNDWATER SHOULD BE ANTICIPATED ON THIS PROJECT. CONTRACTOR'S BID SHALL INCLUDE CONSIDERATION FOR ADDRESSING THIS ISSUE.
- ANY WELLS DISCOVERED ON SITE THAT WILL HAVE NO USE MUST BE PLUGGED BY A LICENSED WELL DRILLING CONTRACTOR IN A MANNER APPROVED BY ALL JURISDICTIONAL AGENCIES. CONTRACTOR SHALL BE RESPONSIBLE FOR OBTAINING ANY WELL ABANDONMENT PERMITS REQUIRED.
- ANY WELL DISCOVERED DURING EARTH MOVING OR EXCAVATION SHALL BE REPORTED TO THE APPROPRIATE JURISDICTIONAL AGENCIES WITHIN 24 HOURS AFTER DISCOVERY IS MADE.
- THE CONTRACTOR SHALL BE RESPONSIBLE FOR VERIFYING THAT THE PROPOSED IMPROVEMENTS SHOWN ON THE PLANS DO NOT CONFLICT WITH ANY KNOWN EXISTING OR OTHER PROPOSED IMPROVEMENTS. IF ANY CONFLICTS ARE DISCOVERED, THE CONTRACTOR SHALL NOTIFY THE OWNER PRIOR TO INSTALLATION OF ANY PORTION OF THE SITE WORK THAT WOULD BE AFFECTED. FAILURE TO NOTIFY OWNER OF AN IDENTIFIABLE CONFLICT PRIOR TO PROCEEDING WITH INSTALLATION RELIEVES OWNER OF ANY OBLIGATION TO PAY FOR A RELATED CHANGE ORDER.
- PROVIDE TEMPORARY CONSTRUCTION FENCING TO FULLY ENCLOSE CONSTRUCTION AREA. WHERE POSSIBLE, EXISTING CHAIN-LINK FENCING TO REMAIN CAN BE UTILIZED AS CONSTRUCTION FENCING IF CONTINUOUS, IN GOOD CONDITION, AND IN APPROXIMATE LOCATIONS OF PROPOSED CONSTRUCTION FENCING AS SHOWN IN PLANS. TEMPORARY FENCING TO BE GALVANIZED STEEL CHAIN-LINK FENCING 6' HEIGHT AND WITH BASE STANDS AND SAND BAGS ON EACH FOR STABILITY. POST CONSTRUCTION AREA WITH ADA-COMPLIANT SIGNAGE INDICATING AREA AS AN ACTIVE CONSTRUCTION ZONE, NO TRESPASSING, AND OTHER WARNINGS AS REQUIRED BY THE CITY OR REGULATORY AGENCY(IES). CONTRACTOR RESPONSIBLE FOR MAINTENANCE OF FENCING FOR THE DURATION OF CONSTRUCTION
- FURNISH ALL NECESSARY MATERIALS, EQUIPMENT, MACHINERY, TOOLS, MEANS OF TRANSPORTATION AND LABOR NECESSARY TO COMPLETE THE WORK IN FULL AND COMPLETE ACCORDANCE WITH THE CONSTRUCTION DOCUMENTS AND JURISDICTIONAL AGENCY REQUIREMENTS. IN THE EVENT THE CONSTRUCTION DOCUMENTS AND THE JURISDICTIONAL AGENCY REQUIREMENTS ARE NOT IN AGREEMENT, THE MOST STRINGENT SHALL GOVERN.
- ALL DETAILS, SECTION, AND NOTES SHOWN ON DRAWINGS ARE INTENDED TO BE TYPICAL AND SHALL APPLY TO SIMILAR SITUATIONS ELSEWHERE UNLESS NOTED OR SHOWN OTHERWISE.
- MAINTAIN SITE IN NEAT AND ORDERLY CONDITION DAILY.
- GUARANTEE ALL WORK FOR A PERIOD OF ONE YEAR FOLLOWING FINAL ACCEPTANCE UNLESS OTHERWISE STIPULATED IN THE CONTRACT DOCUMENTS.
- COMPACTION TESTING IS REQUIRED. CONTRACTOR IS RESPONSIBLE FOR PROVIDING TESTING CONDUCTED BY THE GEOTECHNICAL ENGINEER OF RECORD AS INDICATED ON THE COVER SHEET.
- THE OVERALL SITE TOPOGRAPHIC AND BOUNDARY INFORMATION SHOWN HEREON WAS ORIGINALLY PREPARED BY 3002 SURVEYING, INC. DATED MARCH 2024.
- SURVEY DOCUMENTS REFERENCE VERTICAL DATUM NAVD 88. CONTRACTOR SHALL VERIFY VERTICAL DATUM OF SURVEY DOCUMENTS PRIOR TO CONSTRUCTION.

## PAVING, GRADING AND DRAINAGE NOTES

- ALL PAVING, CONSTRUCTION, MATERIALS, AND WORKMANSHIP WITHIN THE RIGHT-OF-WAY SHALL BE IN ACCORDANCE WITH LOCAL OR COUNTY SPECIFICATIONS AND STANDARDS (LATEST EDITION) OR FDOT SPECIFICATIONS AND STANDARDS (LATEST EDITION) IF NOT COVERED BY LOCAL OR COUNTY REGULATIONS.
- ALL UNPAVED AREAS IN EXISTING RIGHTS-OF-WAY DISTURBED BY CONSTRUCTION SHALL BE REGRADED AND SODDED.
- TRAFFIC CONTROL ON ALL FDOT, LOCAL AND COUNTY RIGHTS-OF-WAY SHALL MEET THE REQUIREMENTS OF THE MANUAL OF UNIFORM TRAFFIC CONTROL DEVICES (U.S. DOT/FHWA) AND THE REQUIREMENTS OF THE STATE AND ANY LOCAL AGENCY HAVING JURISDICTION. IN THE EVENT THAT THE CONTRACT DOCUMENTS AND THE JURISDICTIONAL AGENCY REQUIREMENTS ARE NOT IN AGREEMENT, THE MOST STRINGENT SHALL GOVERN.
- THE CONTRACTOR SHALL GRADE THE SITE TO THE ELEVATIONS INDICATED AND SHALL REGRADE WASHOUTS WHERE THEY OCCUR AFTER EVERY RAINFALL UNTIL A GRASS STAND IS WELL ESTABLISHED OR ADEQUATE STABILIZATION OCCURS.
- ALL AREAS INDICATED AS PAVEMENT SHALL BE CONSTRUCTED IN ACCORDANCE WITH THE TYPICAL PAVEMENT SECTIONS AS INDICATED ON THE DRAWINGS.
- WHERE EXISTING PAVEMENT IS INDICATED TO BE REMOVED AND REPLACED, THE CONTRACTOR SHALL SAW CUT A MINIMUM 2" DEEP FOR A SMOOTH AND STRAIGHT JOINT AND REPLACE THE PAVEMENT WITH THE SAME TYPE AND DEPTH OF MATERIAL AS EXISTING OR AS INDICATED.
- WHERE NEW PAVEMENT MEETS THE EXISTING PAVEMENT, THE CONTRACTOR SHALL SAW CUT THE EXISTING PAVEMENT FULL DEPTH FOR A SMOOTH AND STRAIGHT JOINT AND MATCH THE EXISTING PAVEMENT ELEVATION WITH THE PROPOSED PAVEMENT UNLESS OTHERWISE INDICATED.
- THE CONTRACTOR SHALL INSTALL FILTER FABRIC OVER ALL DRAINAGE STRUCTURES FOR THE DURATION OF CONSTRUCTION AND UNTIL ACCEPTANCE OF THE PROJECT BY THE OWNER. ALL DRAINAGE STRUCTURES SHALL BE CLEANE OF DEBRIS AS REQUIRED DURING AND AT THE END OF CONSTRUCTION TO PROVIDE POSITIVE DRAINAGE FLOWS.
- IF DEWATERING IS REQUIRED, THE CONTRACTOR SHALL OBTAIN ANY APPLICABLE REQUIRED PERMITS. THE CONTRACTOR IS TO COORDINATE WITH THE OWNER AND THE DESIGN ENGINEER PRIOR TO ANY EXCAVATION.
- STRIP TOPSOIL AND ORGANIC MATTER FROM ALL AREAS OF THE SITE AS REQUIRED. IN SOME CASES TOPSOIL MAY BE STOCKPILED ON SITE FOR PLACEMENT WITHIN LANDSCAPED AREAS BUT ONLY AS DIRECTED BY THE OWNER.
- FIELD DENSITY TESTS SHALL BE TAKEN AT INTERVALS IN ACCORDANCE WITH THE LOCAL JURISDICTIONAL AGENCY OR TO FDOT STANDARDS. IN THE EVENT THAT THE CONTRACT DOCUMENTS AND THE JURISDICTIONAL AGENCY REQUIREMENTS ARE NOT IN AGREEMENT, THE MOST STRINGENT SHALL GOVERN.
- ALL SLOPES AND AREAS DISTURBED BY CONSTRUCTION SHALL BE GRADED AS PER PLANS. THE AREAS SHALL THEN BE SODDED OR SEEDED AS SPECIFIED IN THE PLANS, ANY AREAS DISTURBED FOR ANY REASON PRIOR TO FINAL ACCEPTANCE OF THE JOB SHALL BE CORRECTED BY THE CONTRACTOR AT NO ADDITIONAL COST TO THE OWNER. ALL EARTHEN AREAS WILL BE SODDED OR SEEDED AND MULCHED AS SHOWN ON THE LANDSCAPING PLAN, SOD, WHERE CALLED FOR, MUST BE INSTALLED AND MAINTAINED ON EXPOSED SLOPES WITHIN 48 HOURS OF COMPLETING FINAL GRADING, AND AT ANY OTHER TIME AS NECESSARY, TO PREVENT EROSION, SEDIMENTATION OR TURBID DISCHARGES.
- ALL CUT OR FILL SLOPES SHALL BE 4 (HORIZONTAL):1 (VERTICAL) OR FLATTER UNLESS OTHERWISE SHOWN.
- THE CONTRACTOR SHALL BE RESPONSIBLE FOR THE CONTROL OF DUST AND DIRT RISING AND SCATTERING IN THE AIR DURING CONSTRUCTION AND SHALL PROVIDE WATER SPRINKLING OR OTHER SUITABLE METHODS OF CONTROL. THE CONTRACTOR SHALL COMPLY WITH ALL GOVERNING REGULATIONS PERTAINING TO ENVIRONMENTAL PROTECTION.
- THE CONTRACTOR SHALL TAKE ALL REQUIRED MEASURES TO CONTROL TURBIDITY, INCLUDING BUT NOT LIMITED TO THE INSTALLATION OF TURBIDITY BARRIERS AT ALL LOCATIONS WHERE THE POSSIBILITY OF TRANSFERRING SUSPENDED SOLIDS INTO THE RECEIVING WATER BODY EXISTS DUE TO THE PROPOSED WORK. TURBIDITY BARRIERS MUST BE MAINTAINED IN EFFECTIVE CONDITION AT ALL LOCATIONS UNTIL CONSTRUCTION IS COMPLETED AND DISTURBED SOIL AREAS ARE STABILIZED. THEREAFTER, THE CONTRACTOR MUST REMOVE THE BARRIERS. AT NO TIME SHALL THERE BE ANY OFF-SITE DISCHARGE WHICH VIOLATES THE WATER QUALITY STANDARDS IN CHAPTER 17-302, FLORIDA ADMINISTRATIVE CODE.
- THE CONTRACTOR MUST REVIEW AND MAINTAIN A COPY OF THE ENVIRONMENTAL RESOURCE PERMIT COMPLETE WITH ALL CONDITIONS, ATTACHMENTS, EXHIBITS, AND PERMIT MODIFICATIONS IN GOOD CONDITION AT THE CONSTRUCTION SITE. THE COMPLETE PERMIT MUST BE AVAILABLE FOR REVIEW UPON REQUEST BY PLANT MANAGEMENT DISTRICT REPRESENTATIVES.
- THE CONTRACTOR SHALL ENSURE THAT ISLAND PLANTING AREAS AND OTHER PLANTING AREAS ARE NOT COMPACTED AND DO NOT CONTAIN ROAD BASE MATERIALS. THE CONTRACTOR SHALL ALSO EXCAVATE AND REMOVE ALL UNDESIRABLE MATERIAL FROM ALL AREAS ON THE SITE TO BE PLANTED AND PROPERLY DISPOSED OF IN A LEGAL MANNER.
- THE CONTRACTOR SHALL INSTALL ALL UNDERGROUND STORM WATER PIPING PER MANUFACTURER'S RECOMMENDATIONS.

## MAINTENANCE OF TRAFFIC (MOT) NOTES

- PREPARE A MAINTENANCE OF TRAFFIC (MOT) PLAN FOR CONSTRUCTION ACTIVITY THAT OCCURS WITHIN THE CITY RIGHT-OF-WAY, INCLUDING BUT NOT LIMITED TO SIDEWALK WORK AND ACTIVITIES. THE MOT PLAN MUST BE CREATED BY AN INDIVIDUAL WHO IS CERTIFIED TO DO SO BY THE FDOT MOT CERTIFICATION TRAINING. THE MOT PLAN MUST ALSO BE IN ACCORDANCE WITH FDOT DESIGN STANDARDS, FDOT STANDARD SPECIFICATIONS, AND CITY PUBLIC WORKS REQUIREMENTS AND MUST BE REVIEWED AND APPROVED BY THE CITY OF GAINESVILLE PUBLIC WORKS DEPARTMENT. ALL WORK SHALL BE PERFORMED OUTSIDE OF THE RIGHT-OF-WAY WITH NO DRIVE AISLE OR PARKING CLOSURES. THE MOT PLAN MUST ALSO BE REVIEWED AND APPROVED BY FDOT.
- THE CONTRACTOR SHALL PROVIDE A DETAILED MAINTENANCE OF TRAFFIC PLAN PRIOR TO THE START OF CONSTRUCTION FOR APPROVAL BY CITY OF GAINESVILLE PUBLIC WORKS DEPARTMENT PRIOR TO CONSTRUCTION.

## WATER AND SEWER UTILITY NOTES

- THE CONTRACTOR SHALL CONSTRUCT GRAVITY SEWER LATERALS, MANHOLES, GRAVITY SEWER LINES AND DOMESTIC WATER AND FIRE PROTECTION SYSTEM AS SHOWN ON THESE PLANS. THE CONTRACTOR SHALL FURNISH ALL NECESSARY MATERIALS, EQUIPMENT, MACHINERY, TOOLS, MEANS OF TRANSPORTATION AND LABOR NECESSARY TO COMPLETE THE WORK IN FULL AND COMPLETE ACCORDANCE WITH THE SHOWN, DESCRIBED AND REASONABLY INTENDED REQUIREMENTS OF THE CONTRACT DOCUMENTS AND JURISDICTIONAL AGENCY REQUIREMENTS. IN THE EVENT THAT THE CONTRACT DOCUMENTS AND THE JURISDICTIONAL AGENCY REQUIREMENTS ARE NOT IN AGREEMENT, THE MOST STRINGENT SHALL GOVERN.
- THE CONTRACTOR SHALL RESTORE ALL DISTURBED AREAS TO EITHER SOD OR NEW PLANTINGS, DEPENDING ON EXISTING CONDITIONS. CONFIRM WITH OWNER'S REPRESENTATION PRIOR TO DISTURBANCE IF AREA IS NOT ADDRESSED IN LANDSCAPE PLANS.
- DEFLECTION OF PIPE JOINTS AND CURVATURE OF PIPE SHALL NOT EXCEED THE MANUFACTURER'S SPECIFICATIONS. SECURELY CLOSE ALL OPEN ENDS OF PIPE AND FITTINGS WITH A WATERTIGHT PLUG WHEN WORK IS NOT IN PROGRESS. THE INTERIOR OF ALL PIPES SHALL BE CLEAN AND JOINT SURFACES WIPED CLEAN AND DRY AFTER THE PIPE HAS BEEN LOWERED INTO THE TRENCH. VALVES SHALL BE PLUMB AND LOCATED ACCORDING TO THE PLANS.
- ALL PHASES OF INSTALLATION, INCLUDING UNLOADING, TRENCHING, LAYING AND BACK FILLING, SHALL BE DONE IN A FIRST CLASS WORKMANLIKE MANNER. ALL PIPE AND FITTINGS SHALL BE CAREFULLY STORED FOLLOWING MANUFACTURER'S RECOMMENDATIONS. CARE SHALL BE TAKEN TO AVOID DAMAGE TO THE COATING OR LINING IN ANY D.I. PIPE FITTINGS. ANY PIPE OR FITTING WHICH IS DAMAGED OR WHICH HAS PLAINS OR IMPERFECTIONS WHICH, IN THE OPINION OF THE ENGINEER OR OWNER, RENDERS IT UNFIT FOR USE, SHALL NOT BE USED. ANY PIPE NOT SATISFACTORY FOR USE SHALL BE CLEARLY MARKED AND IMMEDIATELY REMOVED FROM THE JOB SITE, AND SHALL BE REPLACED AT THE CONTRACTOR'S EXPENSE.
- WATER FOR FIRE FIGHTING SHALL BE AVAILABLE FOR USE PRIOR TO COMBUSTIBLES BEING BROUGHT ON SITE.
- ALL UTILITY AND STORM DRAIN TRENCHES LOCATED UNDER AREAS TO RECEIVE PAVING SHALL BE COMPLETELY BACK FILLED IN ACCORDANCE WITH THE GOVERNING JURISDICTIONAL AGENCY'S SPECIFICATIONS. IN THE EVENT THAT THE CONTRACT DOCUMENTS AND THE JURISDICTIONAL AGENCY REQUIREMENTS ARE NOT IN AGREEMENT, THE MOST STRINGENT SHALL GOVERN.
- UNDERGROUND LINES SHALL BE SURVEYED BY A PROFESSIONAL LAND SURVEYOR BEFORE BACK FILLING.
- CONTRACTOR SHALL PERFORM, AT HIS OWN EXPENSE, ANY AND ALL TESTS REQUIRED BY THE SPECIFICATIONS AND/OR ANY AGENCY HAVING JURISDICTION. THESE TESTS MAY INCLUDE, BUT MAY NOT BE LIMITED TO, INFILTRATION AND EXFILTRATION, TELEVISION INSPECTION AND A MANDEREL TEST ON GRAVITY SEWER. A COPY OF THE TEST RESULTS SHALL BE PROVIDED TO THE UTILITY PROVIDER, OWNER AND JURISDICTIONAL AGENCY AS REQUIRED.

## EROSION CONTROL NOTES

- THE STORM WATER POLLUTION PREVENTION PLAN ("SWPPP") IS COMPRISED OF THE EROSION CONTROL PLAN, THE STANDARD DETAILS, THE PLAN NARRATIVE, ATTACHMENTS INCLUDED IN SPECIFICATIONS OF THE SWPPP, PLUS THE PERMIT AND ALL SUBSEQUENT REPORTS AND RELATED DOCUMENTS.
- ALL CONTRACTORS AND SUBCONTRACTORS INVOLVED WITH STORM WATER POLLUTION PREVENTION SHALL OBTAIN A COPY OF THE STORM WATER POLLUTION PREVENTION PLAN AND THE STATE OF FLORIDA NATIONAL POLLUTANT DISCHARGE ELIMINATION SYSTEM GENERAL PERMIT (NPDES PERMIT) AND BECOME FAMILIAR WITH THEIR CONTENTS.
- THE CONTRACTOR SHALL IMPLEMENT BEST MANAGEMENT PRACTICES AS REQUIRED BY THE SWPPP. ADDITIONAL BEST MANAGEMENT PRACTICES SHALL BE IMPLEMENTED AS DICTATED BY CONDITIONS AT NO ADDITIONAL COST TO THE OWNER THROUGHOUT ALL PHASES OF CONSTRUCTION.
- BEST MANAGEMENT PRACTICES (BMP'S) AND CONTROLS SHALL CONFORM TO FEDERAL, STATE, OR LOCAL REQUIREMENTS OR MANUAL OF PRACTICE, AS APPLICABLE. THE CONTRACTOR SHALL IMPLEMENT ADDITIONAL CONTROLS AS DIRECTED BY THE PERMITTING AGENCY OR OWNER.
- EROSION CONTROL PLAN MUST CLEARLY DELINEATE ALL STATE WATERS. PERMITS FOR ANY CONSTRUCTION ACTIVITY IMPACTING STATE WATERS OR REGULATED WETLANDS MUST BE MAINTAINED ON SITE AT ALL TIMES.
- THE CONTRACTOR SHALL MINIMIZE CLEARING TO THE MAXIMUM EXTENT PRACTICAL OR AS REQUIRED BY THE GENERAL PERMIT.
- CONTRACTOR SHALL DENOTE ON PLAN THE TEMPORARY PARKING AND STORAGE AREA WHICH SHALL ALSO BE USED AS THE EQUIPMENT MAINTENANCE AND CLEANING AREA, EMPLOYEE PARKING AREA, AND AREA FOR LOCATING PORTABLE FACILITIES, OFFICE TRAILERS, AND TOILET FACILITIES.
- ALL WASH WATER (CONCRETE TRUCKS, VEHICLE CLEANING, EQUIPMENT CLEANING, ETC.) SHALL BE DETAINED AND PROPERLY TREATED OR DISPOSED.
- SUFFICIENT OIL AND GREASE ABSORBING MATERIALS AND FLOTATION BOOMS SHALL BE MAINTAINED ON SITE OR READILY AVAILABLE TO CONTAIN AND CLEAN-UP FUEL OR CHEMICAL SPILLS AND LEAKS.
- RUBBISH, TRASH, GARBAGE, LITTER, OR OTHER SUCH MATERIALS SHALL BE DEPOSITED INTO SEALED CONTAINERS. MATERIALS SHALL BE PREVENTED FROM LEAVING THE PREMISES THROUGH THE ACTION OF WIND OR STORM WATER DISCHARGE INTO DRAINAGE DITCHES OR WATERS OF THE STATE.
- ALL STORM WATER POLLUTION PREVENTION MEASURES PRESENTED ON THE PLAN, SHALL BE INITIATED AS SOON AS PRACTICABLE.
- STABILIZATION PRACTICES SHOULD BE INITIATED AS SOON AS PRACTICAL, BUT IN NO CASE MORE THAN 7 DAYS WHERE CONSTRUCTION HAS TEMPORARILY CEASED.
- IF THE ACTION OF VEHICLES TRAVELING OVER THE GRAVEL CONSTRUCTION ENTRANCES IS NOT SUFFICIENT TO REMOVE THE MAJORITY OF DIRT OR MUD, THEN THE TIRES MUST BE WASHED BEFORE THE VEHICLES ENTER A PUBLIC ROAD. IF WASHING IS USED, PROVISIONS MUST BE MADE TO INTERCEPT THE WASH WATER AND TRAP THE SEDIMENT BEFORE IT IS CARRIED OFF THE SITE.
- ALL MATERIALS SPILLED, DROPPED, WASHED, OR TRACKED FROM VEHICLES ONTO ROADWAYS OR INTO STORM DRAINS MUST BE REMOVED AS SOON AS POSSIBLE.
- ALL MATERIALS SPILLED, DROPPED, WASHED, OR TRACKED FROM VEHICLES ONTO ROADWAYS OR INTO STORM DRAINS MUST BE REMOVED AS SOON AS POSSIBLE.
- THE CONTRACTOR SHALL BE RESPONSIBLE FOR REMOVING SEDIMENT IN THE DETENTION POND AND ANY SEDIMENT THAT MAY HAVE COLLECTED IN THE STORM SEWER DRAINAGE SYSTEMS IN CONJUNCTION WITH THE STABILIZATION OF THE SITE.
- ON-SITE & OFF SITE SOIL STOCKPILE AND BORROW AREAS SHALL BE PROTECTED FROM EROSION AND SEDIMENTATION THROUGH IMPLEMENTATION OF BEST MANAGEMENT PRACTICES. STOCKPILE AND BORROW SHALL BE PERMITTED IN ACCORDANCE WITH GENERAL PERMIT REQUIREMENTS.
- SLOPES SHALL BE LEFT IN A ROUGHENED CONDITION DURING THE GRADING PHASE TO REDUCE RUNOFF VELOCITIES AND EROSION.
- DUE TO GRADE CHANGES DURING THE DEVELOPMENT OF THE PROJECT, THE CONTRACTOR SHALL BE RESPONSIBLE FOR ADJUSTING THE EROSION CONTROL MEASURES (SILT FENCES, ETC.) TO PREVENT EROSION.
- ALL CONSTRUCTION SHALL BE STABILIZED AT THE END OF EACH WORKING DAY. THIS INCLUDES BACK FILLING OF TRENCHES FOR UTILITY CONSTRUCTION AND PLACEMENT OF GRAVEL OR BITUMINOUS PAVING FOR ROAD CONSTRUCTION.

## MAINTENANCE

- ALL MEASURES STATED ON THE EROSION AND SEDIMENT CONTROL PLAN, AND IN THE STORM WATER POLLUTION PREVENTION PLAN, SHALL BE MAINTAINED IN FULLY FUNCTIONAL CONDITION UNTIL NO LONGER REQUIRED FOR A COMPLETED PHASE OF WORK OR FINAL STABILIZATION OF THE SITE. ALL EROSION AND SEDIMENTATION CONTROL MEASURES SHALL BE CHECKED BY A QUALIFIED PERSON AT LEAST ONCE EVERY SEVEN CALENDAR DAYS AND WITHIN 24 HOURS OF THE END OF A 0.5" RAINFALL EVENT, AND CLEANED AND REPAIRED IN ACCORDANCE WITH THE FOLLOWING:
- INLET PROTECTION DEVICES AND BARRIERS SHALL BE REPAIRED OR REPLACED IF THEY SHOW SIGNS OF UNDERMINING, OR DETERIORATION.
  - ALL SEEDED AREAS SHALL BE CHECKED REGULARLY TO SEE THAT A GOOD STAND IS MAINTAINED. AREAS SHOULD BE FERTILIZED, WATERED AND RESEEDED AS NEEDED. FOR MAINTENANCE REQUIREMENTS REFER TO SECTION 981 OF THE STANDARD SPECIFICATIONS.
  - SILT FENCES SHALL BE REPAIRED TO THEIR ORIGINAL CONDITIONS IF DAMAGED. SEDIMENT SHALL BE REMOVED FROM THE SILT FENCES WHEN IT REACHES ONE-HALF THE HEIGHT OF THE SILT FENCE.
  - THE CONSTRUCTION ENTRANCES SHALL BE MAINTAINED IN A CONDITION WHICH WILL PREVENT TRACKING OR FLOW OF MUD ONTO PUBLIC RIGHTS-OF-WAY. THIS MAY REQUIRE PERIODIC TOP DRESSING OF THE CONSTRUCTION ENTRANCES AS CONDITIONS DEMAND.
  - THE TEMPORARY PARKING AND STORAGE AREA SHALL BE KEPT IN GOOD CONDITION (SUITABLE FOR PARKING AND STORAGE). THIS MAY REQUIRE PERIODIC TOP DRESSING OF THE TEMPORARY PARKING AS CONDITIONS DEMAND.
  - OUTLET STRUCTURES IN THE SEDIMENTATION BASINS SHALL BE MAINTAINED IN OPERATIONAL CONDITIONS AT ALL TIMES. SEDIMENT SHALL BE REMOVED FROM SEDIMENT BASINS OR TRAPS WHEN THE DESIGN CAPACITY HAS BEEN REDUCED BY 55 CUBIC YARDS / ACRE.
  - ALL MAINTENANCE OPERATIONS SHALL BE DONE IN A TIMELY MANNER BUT IN NO CASE LATER THAN 2 CALENDAR DAYS FOLLOWING THE INSPECTION.

## AS-BUILT NOTES

- SUBMITTAL OF AS-BUILT SITE SURVEY, INCLUDING BENCHMARKS, IS REQUIRED PRIOR TO SCHEDULING A FINAL INSPECTION FOR THE CITY, GRU, AND THE WATER MANAGEMENT DISTRICT.
- AS-BUILT DRAWINGS SHALL BE PREPARED IN AUTOCAD FORMAT BY A FLORIDA REGISTERED LAND SURVEYOR. AN ELECTRONIC FILE OF THE PROJECT SHALL BE SUBMITTED TO THE ENGINEER FOR REVIEW AND APPROVAL. SIGNED AND SEALED PRINTS SHALL BE PROVIDED TO THE ENGINEER AS REQUESTED. PROVIDE LOCATION, ELEVATION AND DESCRIPTION OF BENCHMARK(S).
- PROVIDE BUILDING LOCATIONS, FINISH FLOOR ELEVATIONS, PAVEMENT GRADES AND ALL UNDERGROUND FACILITIES FENCING, SHADE STRUCTURES, AND SITE FURNISHINGS INCLUDED AS PART OF THE CONSTRUCTION DOCUMENTS.
- PROVIDE PERIMETER DIMENSIONS.
- PROVIDE SPECIAL DETAIL DRAWINGS WHERE INSTALLATIONS WERE NOT AS SHOWN ON CONSTRUCTION DRAWINGS DUE TO FIELD CONDITIONS OR WHERE REQUIRED FOR CLARITY.
- LOCATE ALL PIPES AND PROVIDE SIZE, ELEVATION, INVERT ELEVATIONS, LENGTH AND TYPE.
- AN AS-BUILT IRRIGATION PLAN IS ALSO REQUIRED - SEE IRRIGATION PLANS FOR FURTHER REQUIREMENTS.

DESIGN DEVELOPMENT SUBMITTAL	05-21-24	-
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SITE DEVELOPMENT REVIEW	09-06-24	-
SITE DEVELOPMENT REVIEW & BID ADDENDUM NO. 1	12-20-24	-
NOT FOR CONSTRUCTION	01-21-25	-
REVISIONS	-	BY
No.	DATE	

DATE: 02/13/25  
LD24-000087  
Intermediate - Tom Petty Park Pickleball

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2025.01.22 17:04:45-05:00  
DAVID C. SOWELL, P.E.  
STATE OF FLORIDA  
PROFESSIONAL ENGINEER  
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**GAINESVILLE**  
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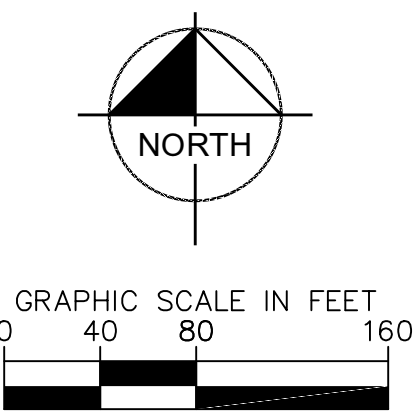
SW25-000012 - SITE WORK  
Tom Petty Park (LD24-000087)

02/28/25

## GENERAL NOTES

TOM PETTY PARK  
PICKLEBALL IMPROVEMENTS  
PREPARED FOR  
CITY OF GAINESVILLE  
WILD SPACES & PUBLIC PLACES  
FLORIDA

SHEET NUMBER  
**C1.0**



1. THE CONTRACTOR IS RESPONSIBLE FOR SCHEDULING A PRE-DEMOLITION INSPECTION WITH THE DEPARTMENT OF PUBLIC WORKS PRIOR TO ANY CONSTRUCTION BEGINNING.
2. PRIOR TO ANY DEMOLITION ACTIVITIES, CONTACT THE URBAN FORESTRY DEPARTMENT AT (852) 334-5922 FOR REVIEW AND APPROVAL REGARDING DEMOLITION METHODOLOGY, THE DRIP-LINE OF EXISTING HERITAGE (OVER 20" DBH) LIVE OAKS, HAND-EXCAVATION OR AIR-SPADING IS REQUIRED UNDER THE DRIP-LINES OF THESE TREES FOR THOSE AREAS OF PROPOSED GRADE CHANGES OR REMOVAL OF EXISTING STRUCTURES. THE CONTRACTOR SHALL PROTECT THEIR EXISTING ROOT STRUCTURE AND GAIN APPROVAL FROM THE URBAN FORESTRY INSPECTOR REGARDING ACCEPTABLE METHODS OF ADDRESSING EXISTING ROOTS OVER ANY PARAMETER THAT IS IN CONFLICT WITH PROPOSED CONSTRUCTION ACTIVITIES.

No.	REVISIONS	DATE	BY
	DESIGN DEVELOPMENT SUBMITTAL	05-21-24	
	90% CONSTRUCTION DOCUMENTS	07-02-24	
	SITE DEVELOPMENT REVIEW	09-06-24	
	SITE DEVELOPMENT REVIEW	12-20-24	
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**TOM PETTY PARK  
PICKLEBALL IMPROVEMENTS  
PREPARED FOR  
CITY OF GAINESVILLE  
WILD SPACES & PUBLIC PLACES**

SHEET NUMBER  
**C2.0**







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PLOT: Addplot=142107025.ctb PlotDevice=gt; Release=142107025 Layout=142107025 DwgName=C3.1  
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**TIMING OF SEDIMENT - CONTROL PRACTICES:**

SEDIMENT CONTROL PRACTICES SHALL BE FUNCTIONAL THROUGHOUT EARTH- DISTURBING ACTIVITY.

SETTLING FACILITIES, PERIMETER CONTROLS, AND OTHER PRACTICES INTENDED TO TRAP SEDIMENT SHALL BE IMPLEMENTED AS THE FIRST STEP OF GRADING AND WITHIN SEVEN DAYS FROM THE START OF GRUBBING. THEY SHALL CONTINUE TO FUNCTION UNTIL THE UPSLOPE DEVELOPMENT AREA IS RE-STABILIZED.

**STABILIZATION OF NON STRUCTURAL PRACTICES:**

CONTROL PRACTICES SHALL PRESERVE EXISTING VEGETATION WHERE ATTAINABLE AND DISTURBED AREAS SHALL BE RE-VEGETATED AS SOON AS PRACTICAL AFTER GRADING OR CONSTRUCTION.

DENUDED AREAS SHALL HAVE SOIL STABILIZATION APPLIED WITHIN FOURTEEN DAYS IF THEY ARE TO REMAIN DORMANT FOR MORE THAN FORTY-FIVE DAYS. PERMANENT OR TEMPORARY SOIL STABILIZATION SHALL BE APPLIED TO DENUDED AREAS WITHIN FOURTEEN DAYS AFTER FINAL GRADE IS REACHED ON ANY PORTION OF THE SITE, AND SHALL ALSO BE APPLIED WITHIN SEVEN DAYS TO DENUDED AREAS WHICH MAY NOT BE AT FINAL GRADE, BUT WILL REMAIN DORMANT (UNDISTURBED) FOR LONGER THAN FORTY-FIVE DAYS.

**SEDIMENT BARRIERS:**

SHEET FLOW RUNOFF FROM DENUDED AREAS SHALL BE INTERCEPTED BY SEDIMENT BARRIERS.

SEDIMENT BARRIERS SUCH AS SEDIMENT FENCE OR DIVERSIONS TO SETTLING FACILITIES SHALL PROTECT ADJACENT PROPERTIES AND WATER RESOURCES FROM SEDIMENT TRANSPORTED BY SHEET FLOW.

**INLET PROTECTION:**

ALL STORM SEWER INLETS WHICH ACCEPT WATER RUNOFF FROM THE DEVELOPMENT AREA SHALL BE PROTECTED SO THAT SEDIMENT-LADEN WATER WILL NOT ENTER THE STORM SYSTEM WITHOUT FIRST BEING PONDED AND FILTERED.

**MAINTENANCE:**

TEMPORARY EROSION CONTROL FEATURES SHALL BE ACCEPTABLY MAINTAINED AND SHALL BE REMOVED OR REPLACED WHEN DIRECTED BY THE ENGINEER AT NO COST TO THE OWNER. ALL WORK SHALL BE PERFORMED IN ACCORDANCE WITH THE SPECIFICATIONS.

**STOCKPILES:**

ALL SOIL STOCKPILES SHALL BE PROTECTED FROM EROSION BY PERIMETER CONTROL DEVICES SUCH AS STRAW BALE DIKES OR FILTER FABRIC FENCES. AND THESE PERIMETER CONTROL DEVICES SHALL BE MAINTAINED THROUGHOUT THE LIFE OF THE PROJECT.

**PERMANENT VEGETATION:**

PERMANENT VEGETATION SHALL NOT BE CONSIDERED ESTABLISHED UNTIL GROUND COVER IS ACHIEVED WHICH, IN THE OPINION OF THE ENGINEER, PROVIDES ADEQUATE COVER AND IS MATURE ENOUGH TO CONTROL SOIL EROSION SATISFACTORILY AND TO SURVIVE ADVERSE WEATHER CONDITIONS.

**CONSTRUCTION ACCESS ROUTES:**

MEASURES SHALL BE TAKEN TO PREVENT SOIL TRANSPORT ONTO SURFACES OR PUBLIC ROADS WHERE RUNOFF IS NOT CHECKED.

**INSPECTION SCHEDULE:**

- DIVERSION SWALE AND STRUCTURAL PROTECTION - INSPECT EVERY 7 DAYS OR AFTER EACH RAINSTORM PRODUCING RUNOFF. REPAIR AS REQUIRED.
- INLET PROTECTION - INSPECT FOR SEDIMENT ACCUMULATION AFTER EACH RAINFALL AND DAILY DURING CONTINUED RAINFALL. REPAIR OR REPLACE WHEN WATER FLOW IS RESTRICTED BY SEDIMENT.
- VEGETATIVE PLANTING - INSPECT AFTER SPROUTING OCCURS AND REPLANT BARE AREAS. INSPECT ESTABLISHED COVER EVERY 15 DAYS FOR DAMAGE; REPLANT AS REQUIRED. MAINTAIN ESTABLISHED COVER AT MAXIMUM 6" HEIGHT. IRRIGATE AS REQUIRED DURING DRY PERIODS TO MAINTAIN LIVE VEGETATION.

**CONSTRUCTION SEQUENCE:**

- INSTALL SEDIMENT CONTROL MEASURES
- PERFORM DEMOLITION ACTIVITIES.
- STABILIZE SITE WITH TEMPORARY VEGETATION AS NEEDED.
- PERFORM IRRIGATION AND UNDERGROUND UTILITY CONSTRUCTION ACTIVITIES.
- CONSTRUCT NEW TRAILS AND INSTALL LANDSCAPING.
- PERFORM FINAL GRADING.
- INSTALL PERMANENT VEGETATION.
- PERFORM CONTINUING MAINTENANCE THROUGHOUT ALL CONSTRUCTION OPERATIONS.

NOTE: THE SEQUENCE OF CONSTRUCTION SHOWN ABOVE IS A GENERAL OVERVIEW AND IS INTENDED TO CONVEY THE GENERAL CONCEPTS OF THE EROSION CONTROL DESIGN AND SHOULD NOT BE RELIED UPON FOR CONSTRUCTION PURPOSES. THE CONTRACTOR IS SOLELY RESPONSIBLE FOR DETAILED PHASING AND CONSTRUCTION SEQUENCING NECESSARY TO CONSTRUCT THE PROPOSED IMPROVEMENTS INCLUDED IN THESE PLANS. THE CONTRACTOR SHALL NOTIFY ENGINEER IN WRITING IMMEDIATELY, PRIOR TO AND/OR DURING CONSTRUCTION IF ANY ADDITIONAL INFORMATION ON THE CONSTRUCTION SEQUENCE IS NECESSARY. CONTRACTOR IS SOLELY RESPONSIBLE FOR COMPLYING WITH THE REQUIREMENTS OF THE AUTHORITY HAVING JURISDICTION AND ALL OTHER APPLICABLE LAWS.

**DITCH BARRIERS:**

BALES SHALL BE PLACED IN A SINGLE ROW, LENGTHWISE, ORIENTED PERPENDICULAR TO THE CONTOUR, WITH ENDS OF ADJACENT BALES TIGHTLY ABUTTING ONE ANOTHER.

THE REMAINING STEPS FOR INSTALLING A STRAW BALE BARRIER FOR SHEET FLOW APPLICATIONS APPLY HERE, WITH THE FOLLOWING ADDITION. THE STRAW BALES SHALL BE INSTALLED SUCH THAT UNDERCUTTING BENEATH THE BALES IS MINIMIZED BY THE USE OF ROCK CHECK DAMS PLACED ADJACENT TO THE STRAW BALES.

THE BARRIER SHALL BE EXTENDED TO SUCH A LENGTH THAT THE BOTTOMS OF THE END BALES ARE HIGHER IN ELEVATION THAN THE TOP OF THE LOWEST MIDDLE BALE TO ASSURE THAT SEDIMENT-LADEN RUNOFF WILL FLOW EITHER THROUGH OR OVER THE BARRIER BUT NOT AROUND IT.

**MAINTENANCE:**

STRAW BALES SHALL BE INSPECTED IMMEDIATELY AFTER EACH RAINFALL AND AT LEAST DAILY DURING PROLONGED RAINFALL.

CLOSE ATTENTION SHALL BE PAID TO THE REPAIR OF DAMAGED BALES, END RUNS AND UNDERCUTTING BENEATH BALES.

NECESSARY REPAIRS TO BARRIERS OR REPLACEMENT OF BALES SHALL BE ACCOMPLISHED PROMPTLY.

SEDIMENT DEPOSITS SHOULD BE REMOVED AFTER EACH RAINFALL. THEY MUST BE REMOVED WHEN THE LEVEL OF DEPOSITION REACHES APPROXIMATELY ONE-HALF THE HEIGHT OF THE BARRIER.

ANY SEDIMENT DEPOSITS REMAINING IN PLACE AFTER THE STRAW BALE BARRIER IS NO LONGER REQUIRED SHALL BE DRESSED TO CONFORM TO THE EXISTING GRADE, PREPARED AND SEEDED.

**SEDIMENT FENCE:**

THIS SEDIMENT BARRIER UTILIZES STANDARD STRENGTH OR EXTRA STRENGTH SYNTHETIC FILTER FABRICS. IT IS DESIGNED FOR SITUATIONS IN WHICH ONLY SHEET OR OVERLAND FLOWS ARE EXPECTED.

- THE HEIGHT OF A SEDIMENT FENCE SHALL NOT EXCEED 36-INCHES (HIGHER FENCES MAY IMPOUND VOLUMES OF WATER SUFFICIENT TO CAUSE FAILURE OF THE STRUCTURE).
- THE FILTER FABRIC SHALL BE PURCHASED IN A CONTINUOUS ROLL CUT TO THE LENGTH OF THE BARRIER TO AVOID THE USE OF JOINTS. WHEN JOINTS ARE NECESSARY, FILTER CLOTH SHALL BE SPLICED TOGETHER ONLY AT A SUPPORT POST, WITH A MINIMUM 6-INCH OVERLAP, AND SECURELY SEALED.
- POSTS SHALL BE SPACED A MAXIMUM OF 10 FEET APART AT THE BARRIER LOCATION AND DRIVEN SECURELY INTO THE GROUND (MINIMUM OF 12 INCHES). WHEN EXTRA STRENGTH FABRIC IS USED WITHOUT THE WIRE SUPPORT FENCE, POST SPACING SHALL NOT EXCEED 6 FEET.
- A TRENCH SHALL BE EXCAVATED APPROXIMATELY 4 INCHES WIDE AND 4 INCHES DEEP ALONG THE LINE OF POSTS AND UPSLOPE FROM THE BARRIER.
- WHEN STANDARD STRENGTH FILTER FABRIC IS USED, A WIRE MESH SUPPORT FENCE SHALL BE FASTENED SECURELY TO THE UPSLOPE SIDE OF THE POSTS USING HEAVY DUTY WIRE STAPLES AT LEAST 1-INCH LONG, TIE WIRES OR HOG RINGS. THE WIRE SHALL EXTEND INTO THE TRENCH A MINIMUM OF 2 INCHES AND SHALL NOT EXTEND MORE THAN 36 INCHES ABOVE THE ORIGINAL GROUND SURFACE.
- THE STANDARD STRENGTH FILTER FABRIC SHALL BE STAPLED OR WIRED TO THE FENCE, AND 8-INCHES OF THE FABRIC SHALL BE EXTENDED INTO THE TRENCH. THE FABRIC SHALL NOT EXTEND MORE THAN 36 INCHES ABOVE THE ORIGINAL GROUND SURFACE. FILTER FABRIC SHALL NOT BE STAPLED TO EXISTING TREES.
- WHEN EXTRA STRENGTH FILTER FABRIC AND CLOSURE POST SPACING ARE USED, THE WIRE MESH SUPPORT FENCE MAY BE ELIMINATED IN SUCH A CASE, THE FILTER FABRIC IS STAPLED OR WIRED DIRECTLY TO THE POSTS WITH ALL OTHER PROVISIONS OF ITEM NO. 6 APPLYING.
- THE TRENCH SHALL BE BACKFILLED AND SOIL COMPACTED OVER THE FILTER FABRIC.
- SEDIMENT FENCES SHALL BE REMOVED WHEN THEY HAVE SERVED THEIR USEFUL PURPOSE, BUT NOT BEFORE THE UPSLOPE AREA HAS BEEN PERMANENTLY STABILIZED.

**MAINTENANCE**

SEDIMENT FENCES AND FILTER BARRIERS SHALL BE INSPECTED IMMEDIATELY AFTER EACH RAINFALL AND AT LEAST DAILY DURING PROLONGED RAINFALL. ANY REQUIRED REPAIRS SHALL BE MADE IMMEDIATELY.

SHOULD THE FABRIC ON A SEDIMENT FENCE OR FILTER BARRIER DECOMPOSE OR BECOME INEFFECTIVE PRIOR TO THE END OF THE EXPECTED USABLE LIFE AND THE BARRIER IS STILL NECESSARY, THE FABRIC SHALL BE REPLACED PROMPTLY.

SEDIMENT DEPOSITS SHOULD BE REMOVED AFTER EACH STORM EVENT. THEY MUST BE REMOVED WHEN DEPOSITS REACH APPROXIMATELY ONE-THIRD THE HEIGHT OF THE BARRIER.

ANY SEDIMENT DEPOSITS REMAINING IN PLACE AFTER THE SEDIMENT FENCE OR FILTER BARRIER IS NO LONGER REQUIRED SHALL BE DRESSED TO CONFORM WITH THE EXISTING GRADE, PREPARED, AND SEEDED.

**ADDITIONAL MEASURES:**

THIS PLAN AND NARRATIVE REPRESENTS THE MINIMUM AMOUNT OF EROSION AND SEDIMENT CONTROL MEASURES, IN THE OPINION OF THE ENGINEER, THAT MAY BE NECESSARY UNDER FAVORABLE WEATHER CONDITIONS. THE CONTRACTOR IS RESPONSIBLE FOR ANY ADDITIONAL MEASURES OR PRACTICES THAT MAY BE NECESSARY TO CONTROL EROSION, TURBID DISCHARGE, FUGITIVE PARTICULATES, ETC. TO FULLY COMPLY WITH ALL GOVERNMENTAL RULES AND/OR PERMIT REQUIREMENTS.

**EROSION AND SEDIMENT CONTROL NARRATIVE**

PLAN DESIGNER: KIMLEY-HORN AND ASSOCIATES INC.  
800 SW 2ND AVENUE, SUITE 100  
GAINESVILLE, FLORIDA 32601  
PHONE: (352) 374-3274

OWNER/  
DEVELOPER: WILD SPACES & PUBLIC PLACES (CITY OF GAINESVILLE)  
306 NE 6TH AVENUE  
GAINESVILLE, FL 32609

ADJACENT  
AREAS: NORTH: NE 16TH AVENUE RIGHT OF WAY  
SOUTH: SINGLE-FAMILY RESIDENTIAL & NE 13TH AVENUE RIGHT OF WAY  
EAST: SINGLE-FAMILY RESIDENTIAL  
WEST: SINGLE-FAMILY RESIDENTIAL & URBAN MIXED USE

EROSION  
CONTROL  
MEASURE: EROSION AND SITE RUNOFF WILL BE CONTROLLED BY THE USE OF  
SEDIMENT FENCE AND STABILIZED VEGETATION WHERE NEEDED.

SITE CONTACT: WILD SPACES & PUBLIC PLACES (CITY OF GAINESVILLE)  
306 NE 6TH AVENUE  
GAINESVILLE, FL 32609

**POLLUTION PREVENTION:**

THE NATIONAL POLLUTANT DISCHARGE ELIMINATION SYSTEM (NPDES) PROGRAM IS REGULATED THROUGH THE FLORIDA DEPARTMENT OF ENVIRONMENTAL PROTECTION (FDEP). IF YOUR CONSTRUCTION ACTIVITY MEETS THE FOLLOWING CRITERIA:

- CONTRIBUTES STORM WATER DISCHARGE TO SURFACE WATERS OF THE STATE OR INTO A MUNICIPAL SEPARATE STORM SEWER SYSTEM (MS4); AND/OR
- DISTURBS ONE OR MORE ACRES OF LAND INCLUDING LESS THAN ONE ACRE IF ACTIVITY IS PART OF A LARGE COMMON PLAN OF DEVELOPMENT OR SALE THAT WILL MEET OR EXCEED A ONE ACRE THRESHOLD. DISTURBANCE INCLUDES CLEARING, GRADING AND EXCAVATING. THEN YOU WILL BE REQUIRED TO SUBMIT A NOTICE OF INTENT (NOI) AND PREPARE A STORM WATER POLLUTION PREVENTION PLAN (SWPPP). FOR MORE INFORMATION PLEASE VISIT FDEP'S WEBSITE AT WWW.DEP.STATE.FL.US/WATER/STORMWATER/NPDES.



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**DAVID C. SOWELL, P.E.**  
STATE OF FLORIDA  
PROFESSIONAL ENGINEER  
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Tom Petty Park (LD24-000087)

02/28/25

KHA PROJECT  
142107025

DATE  
JANUARY 2025

SCALE  
AS SHOWN

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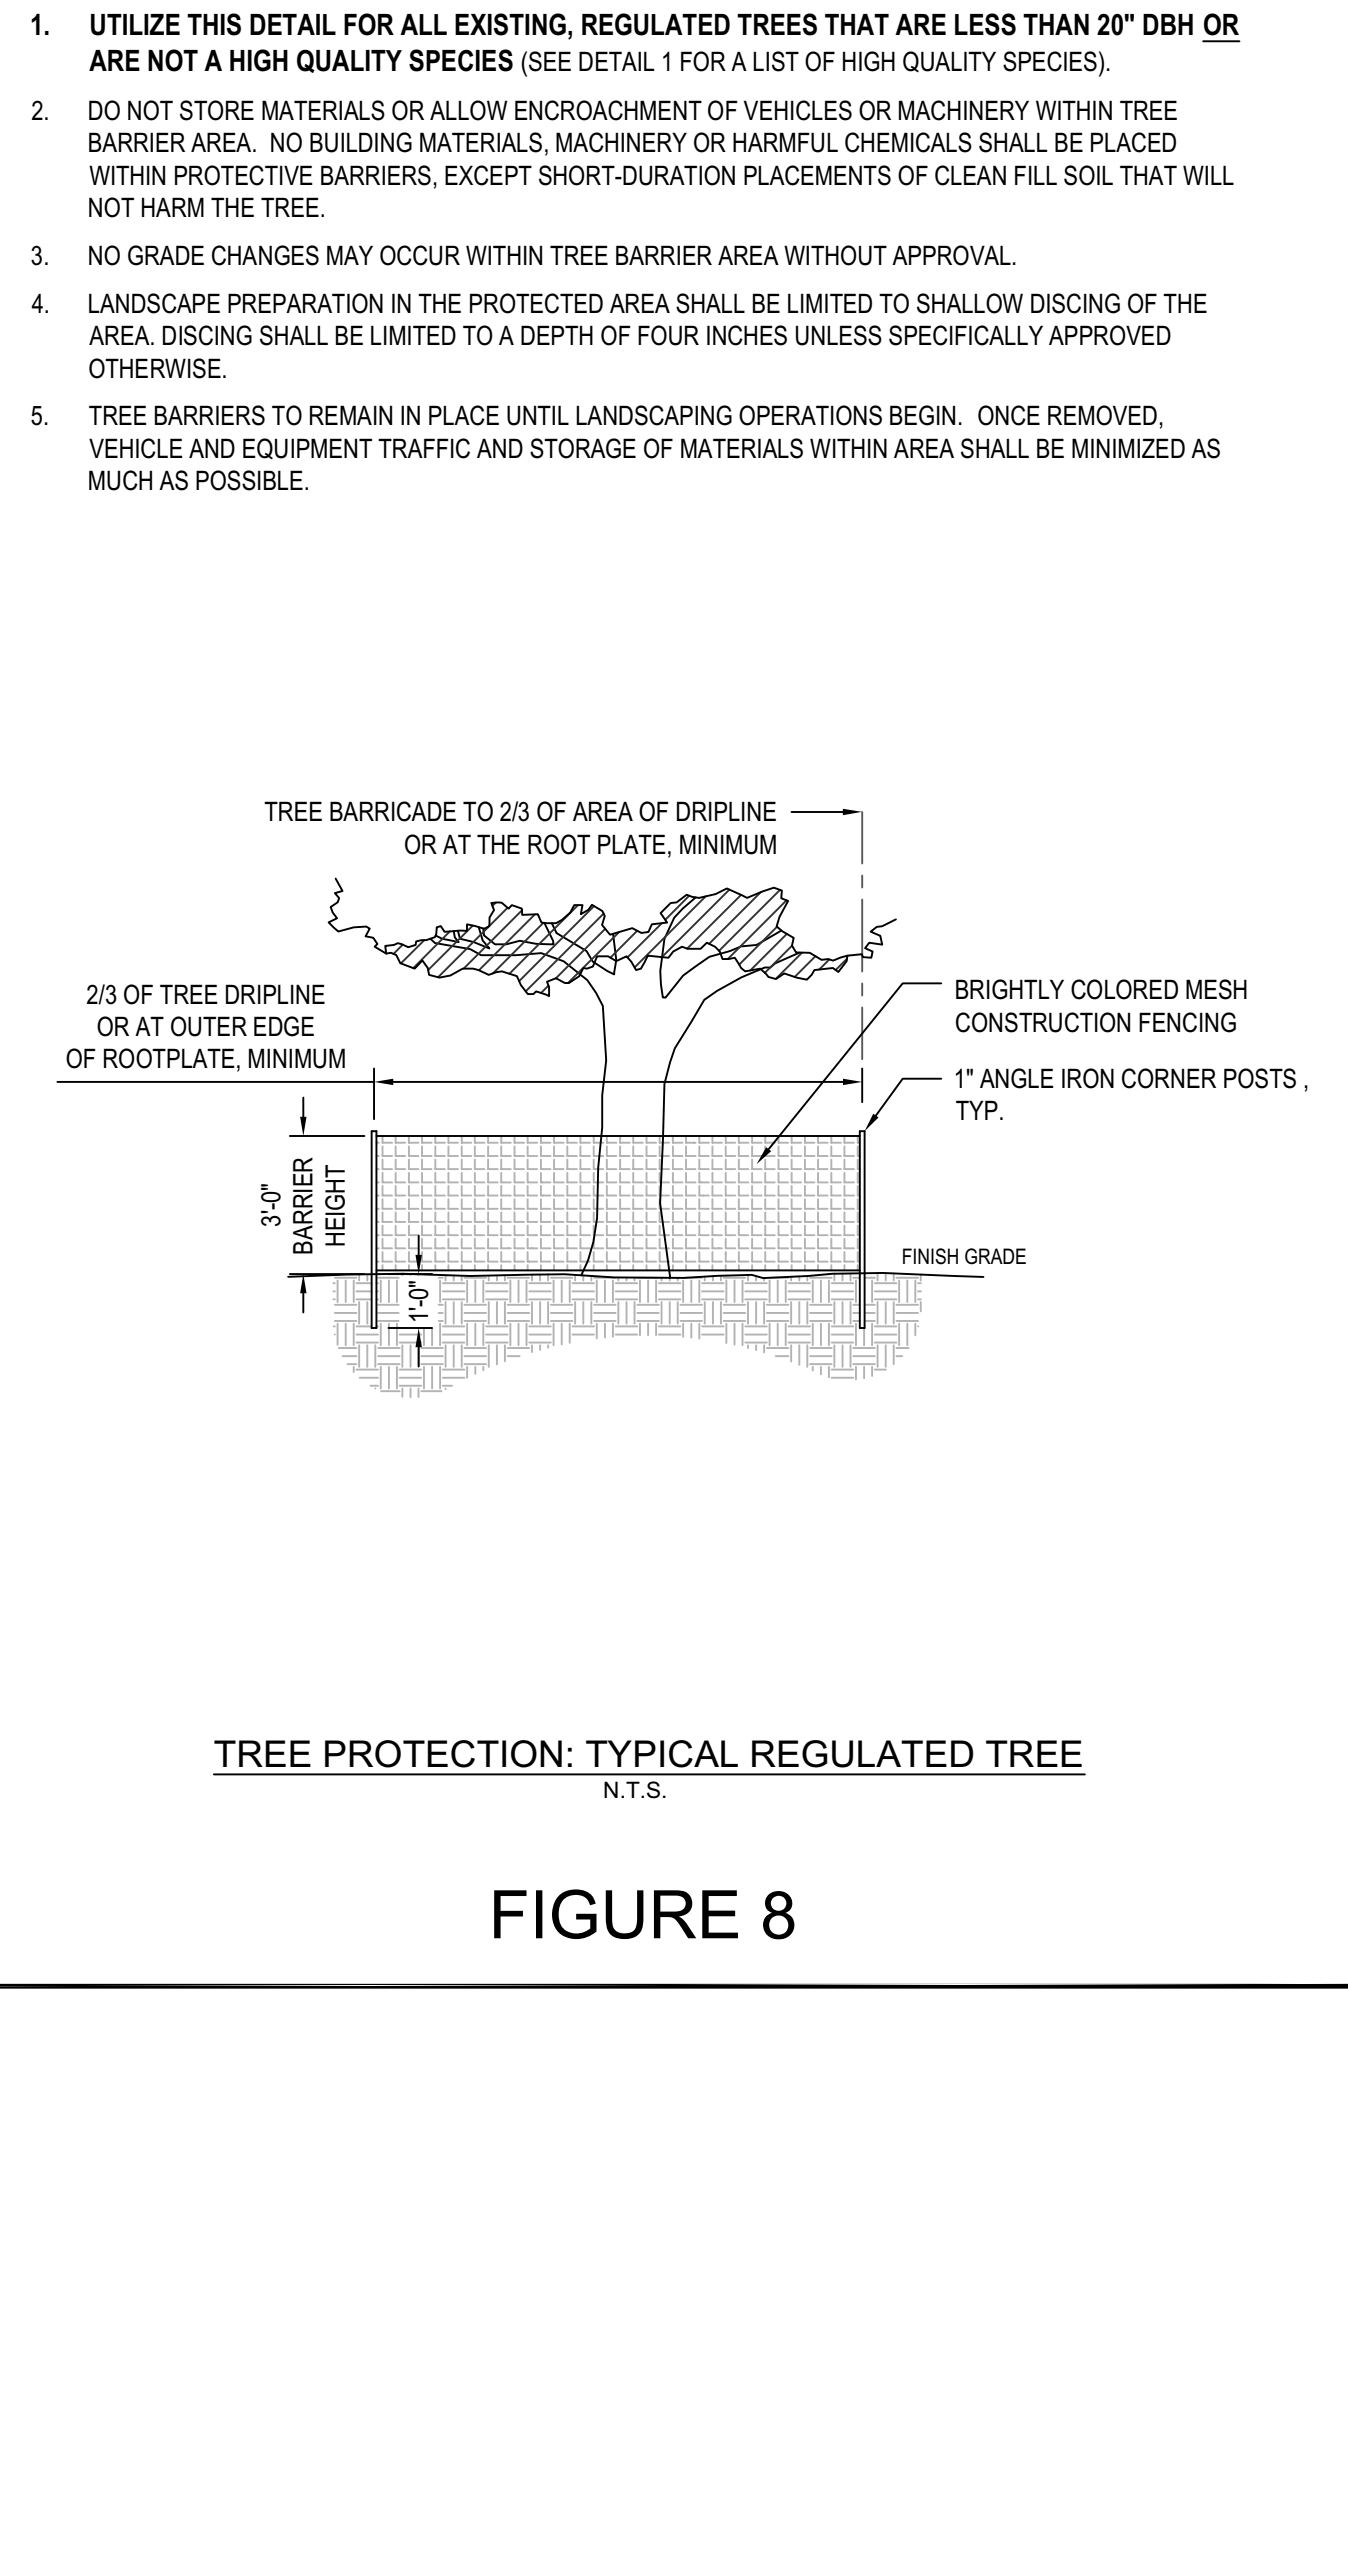
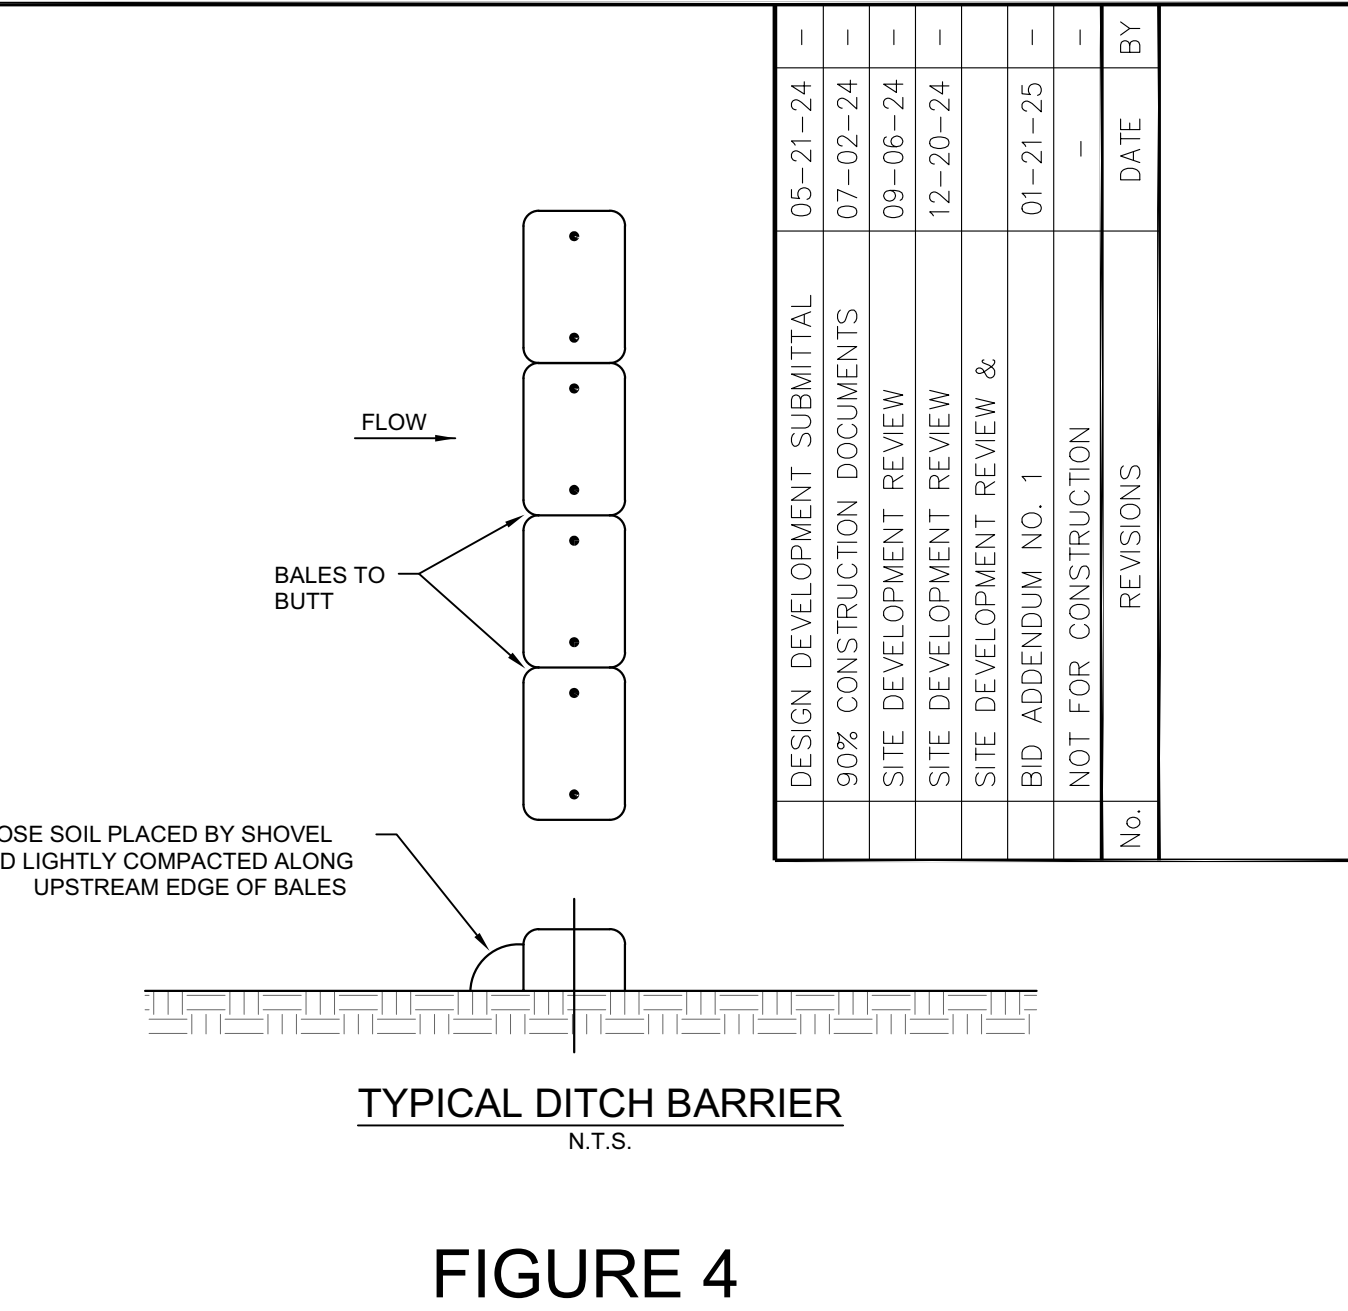
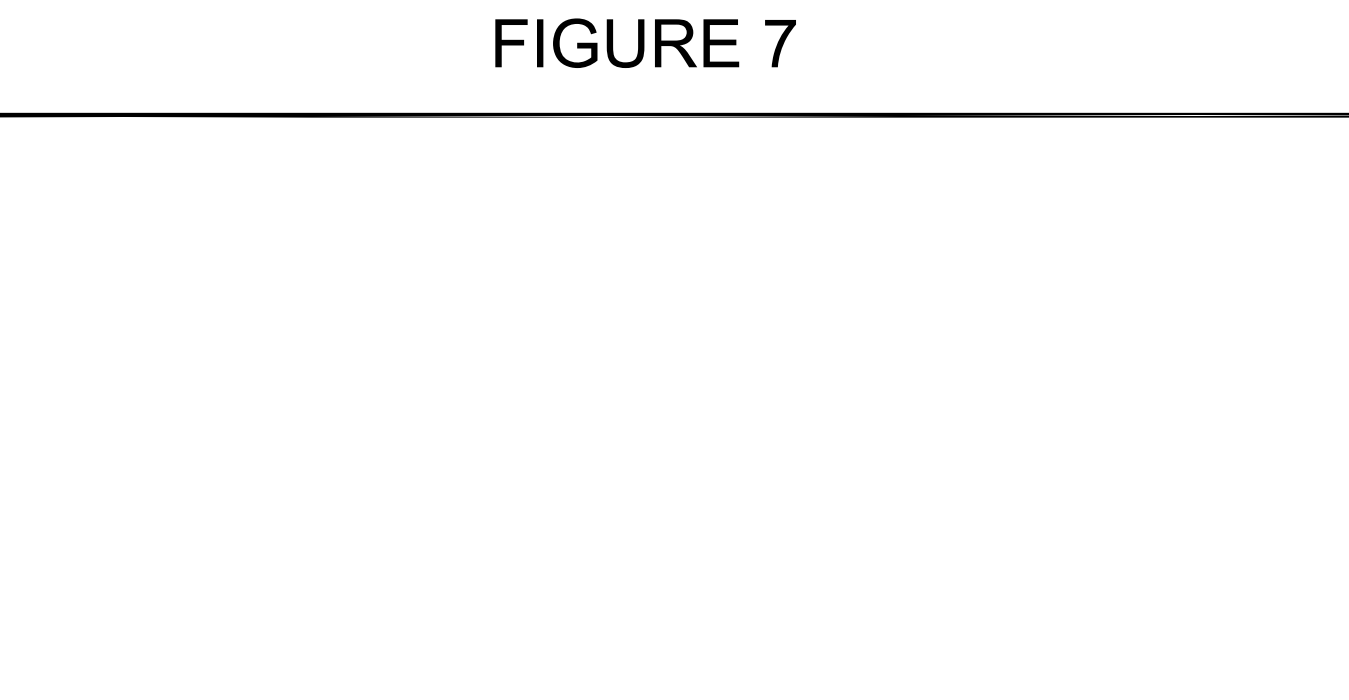
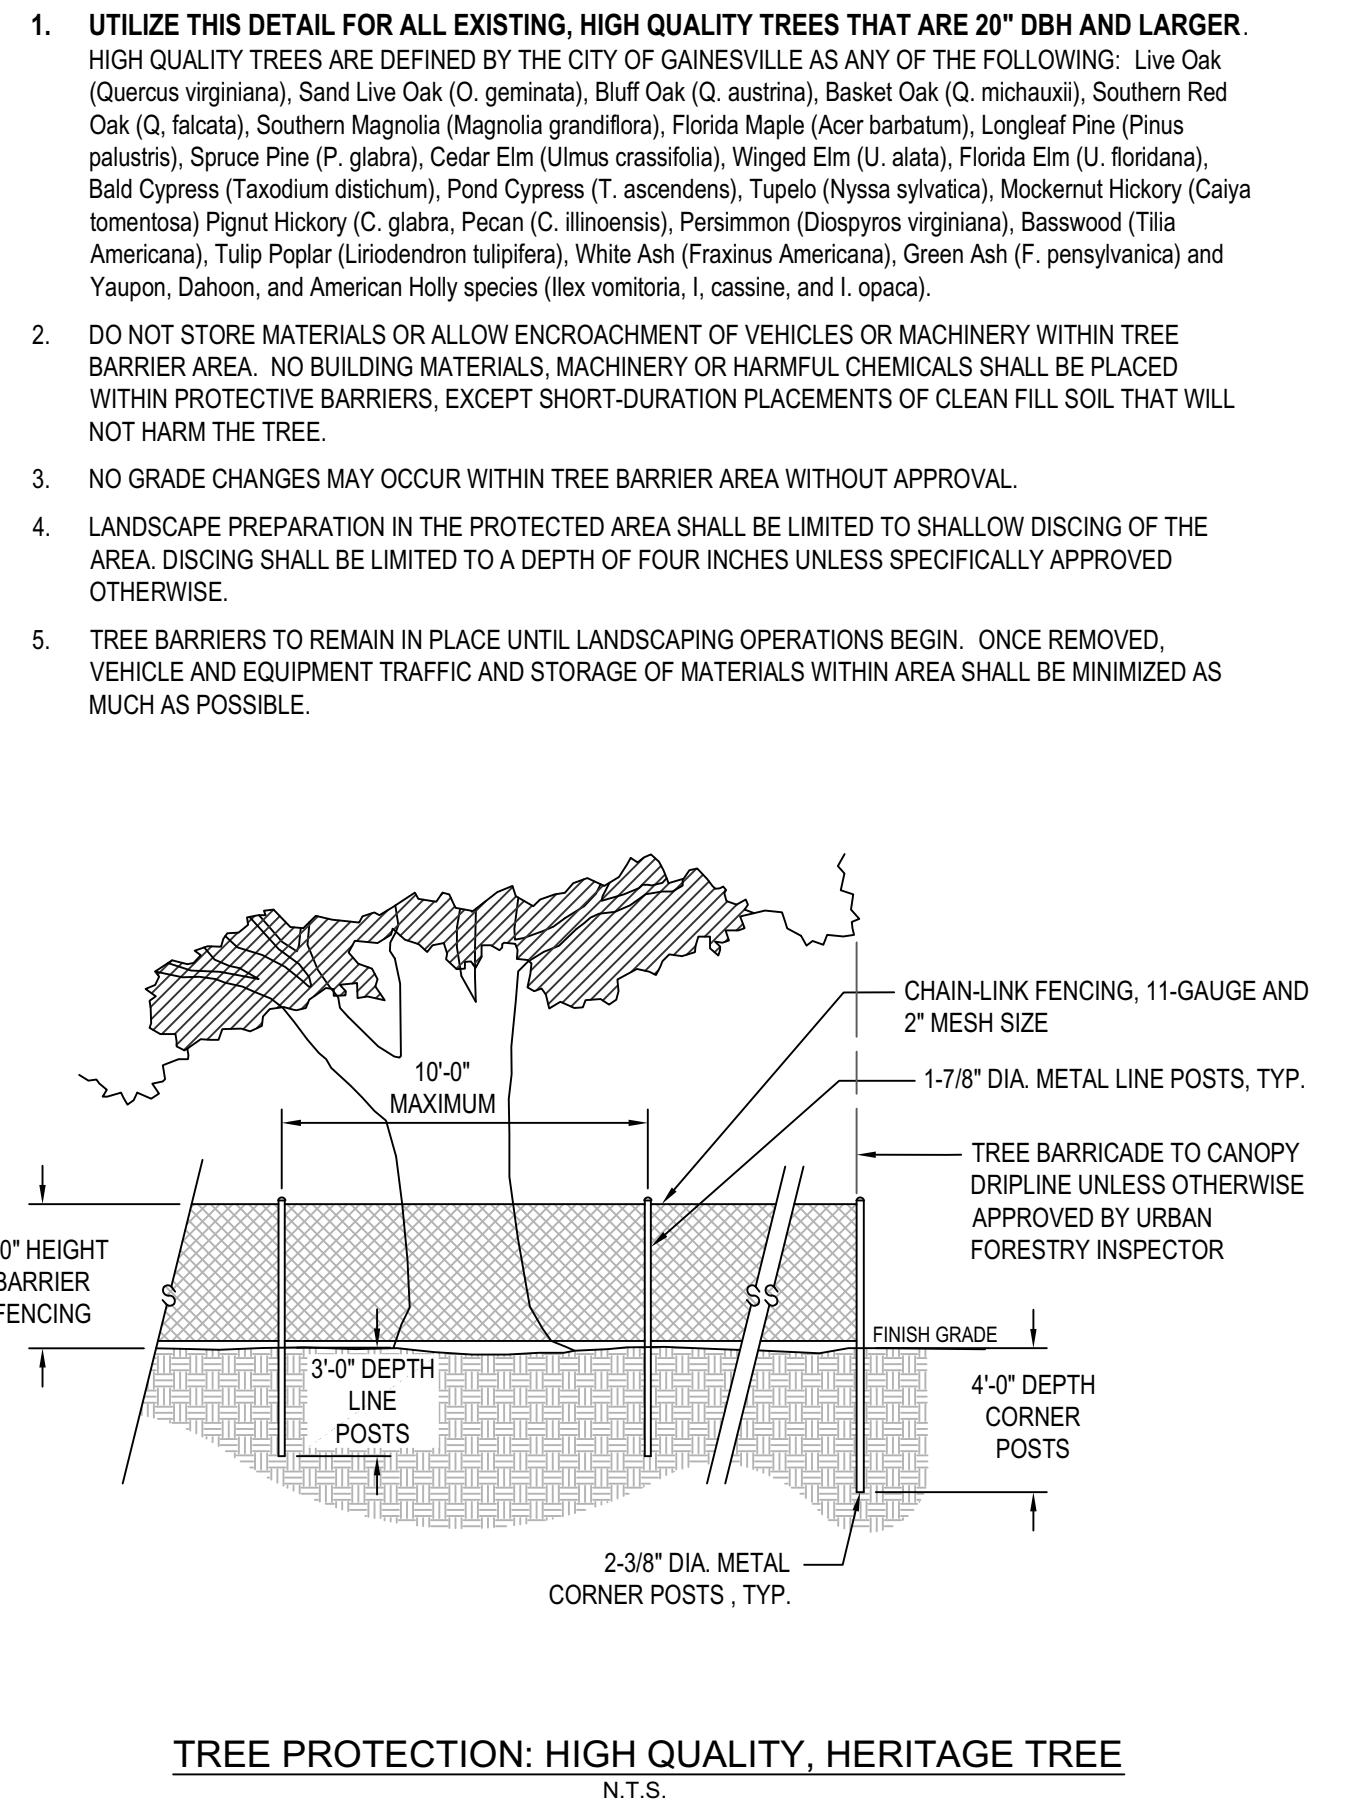
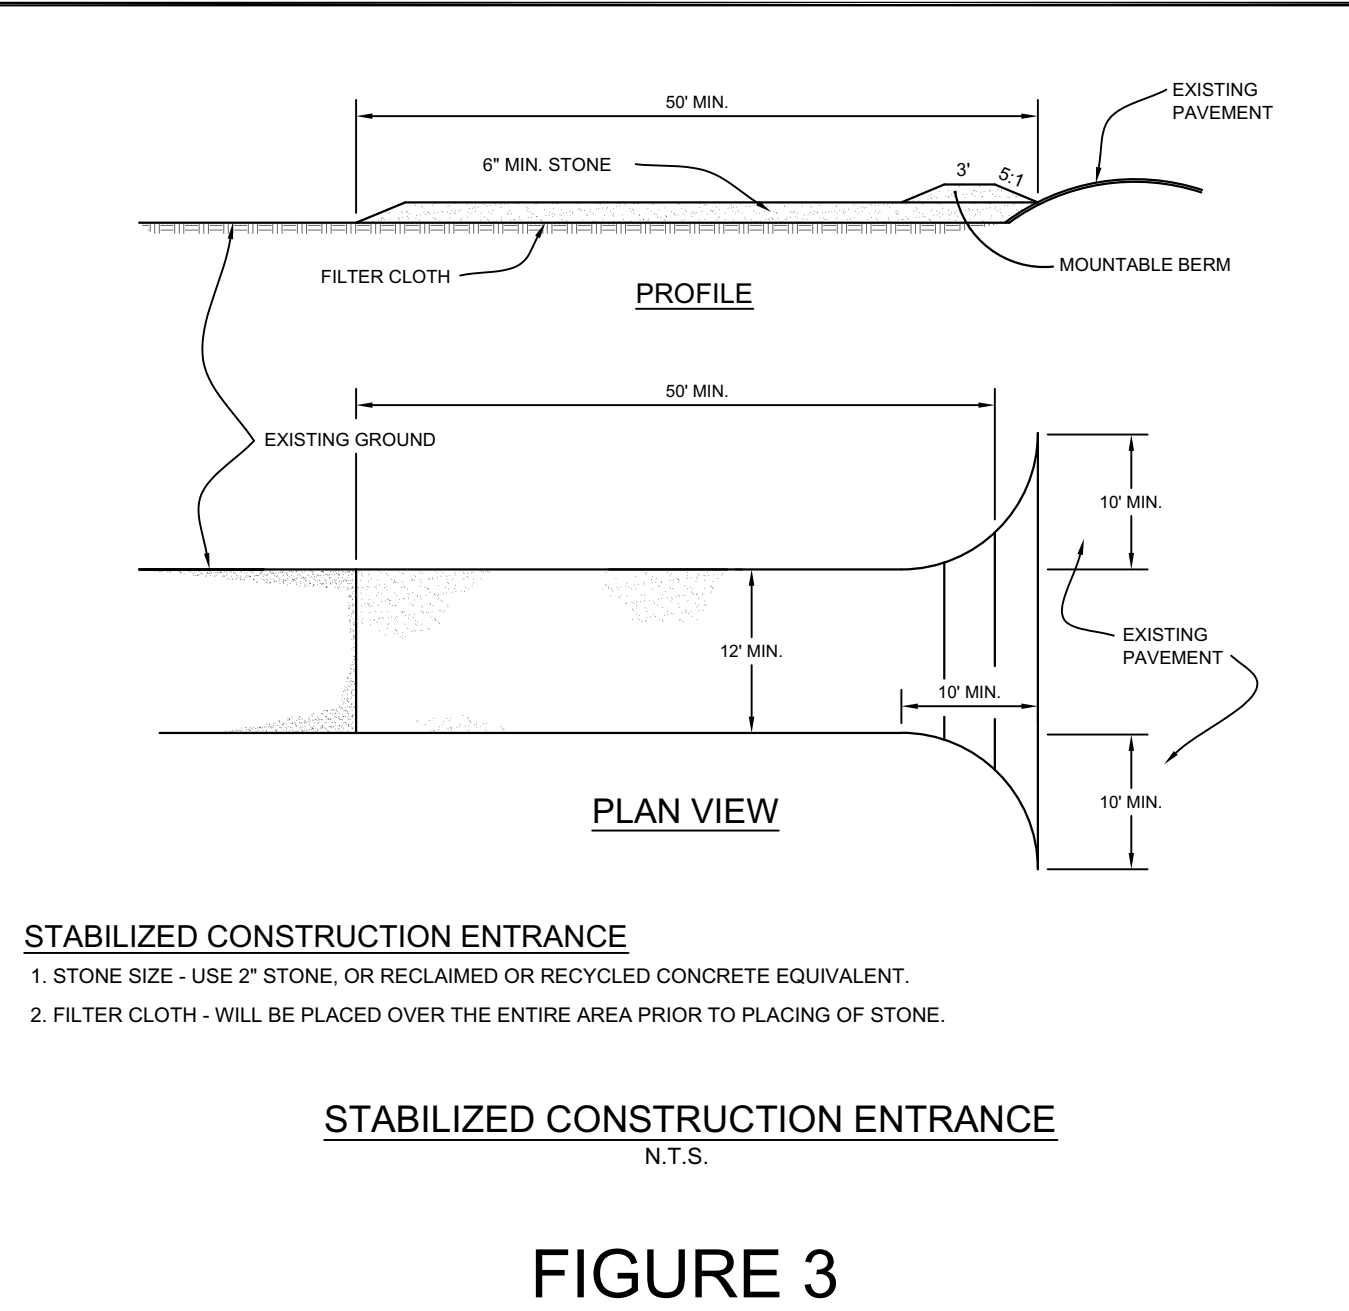
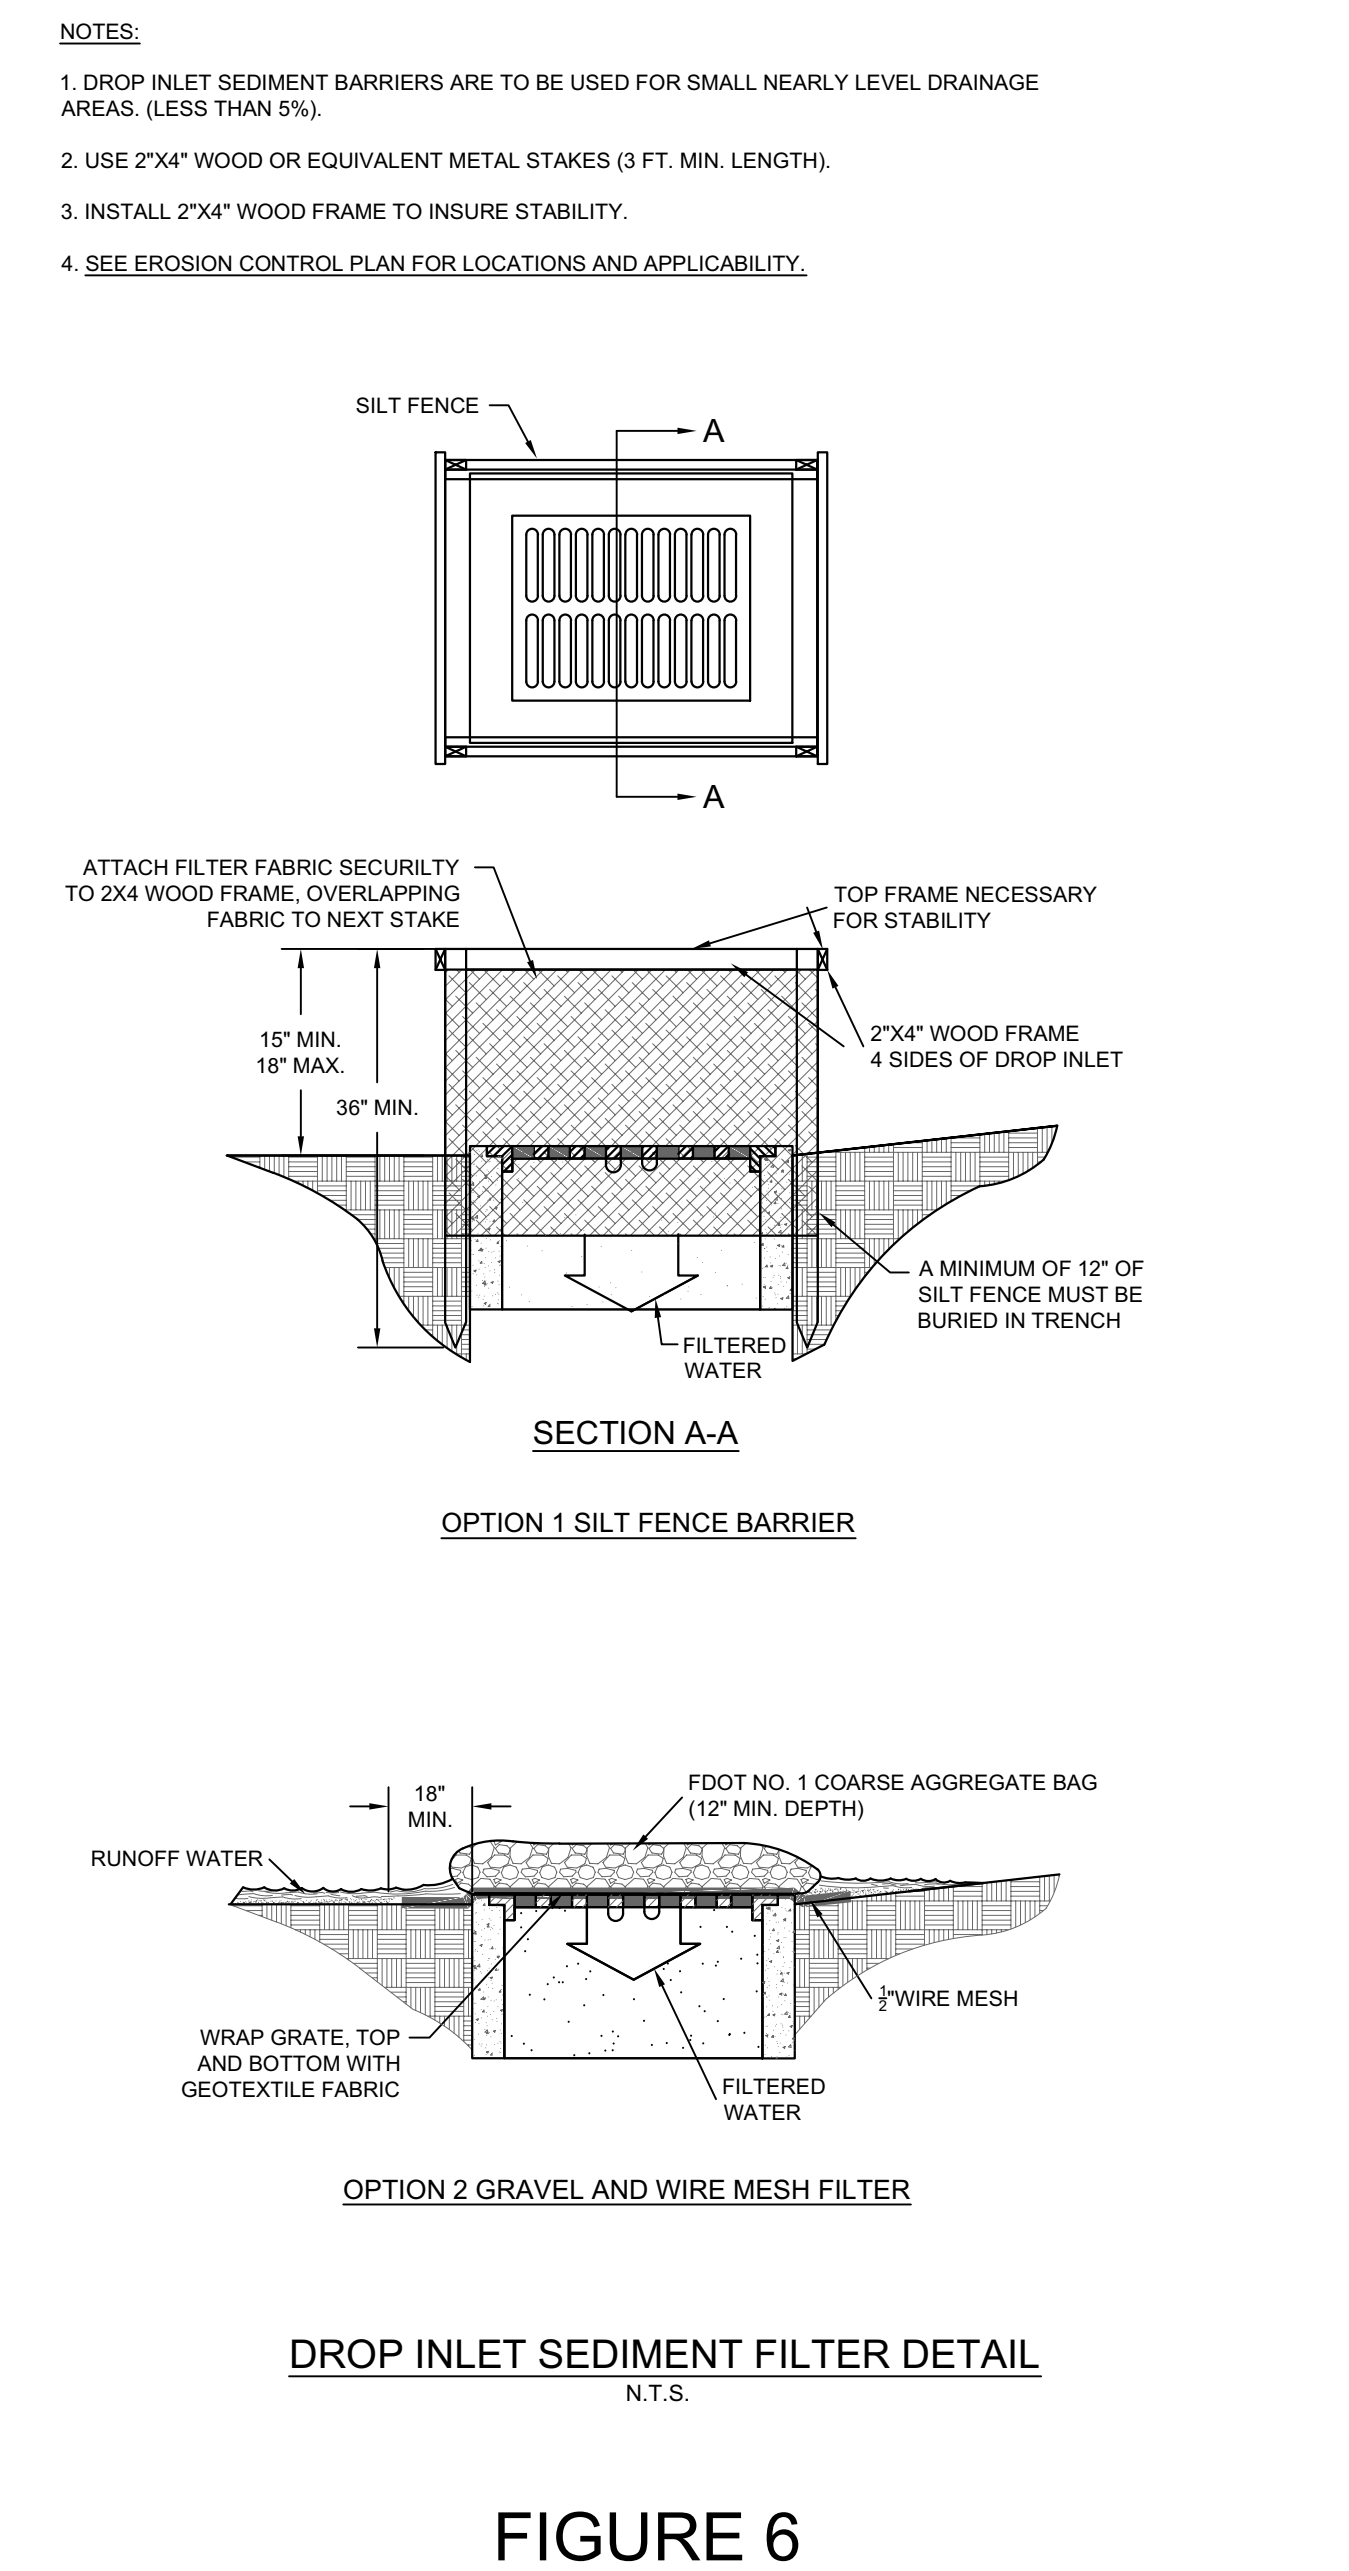
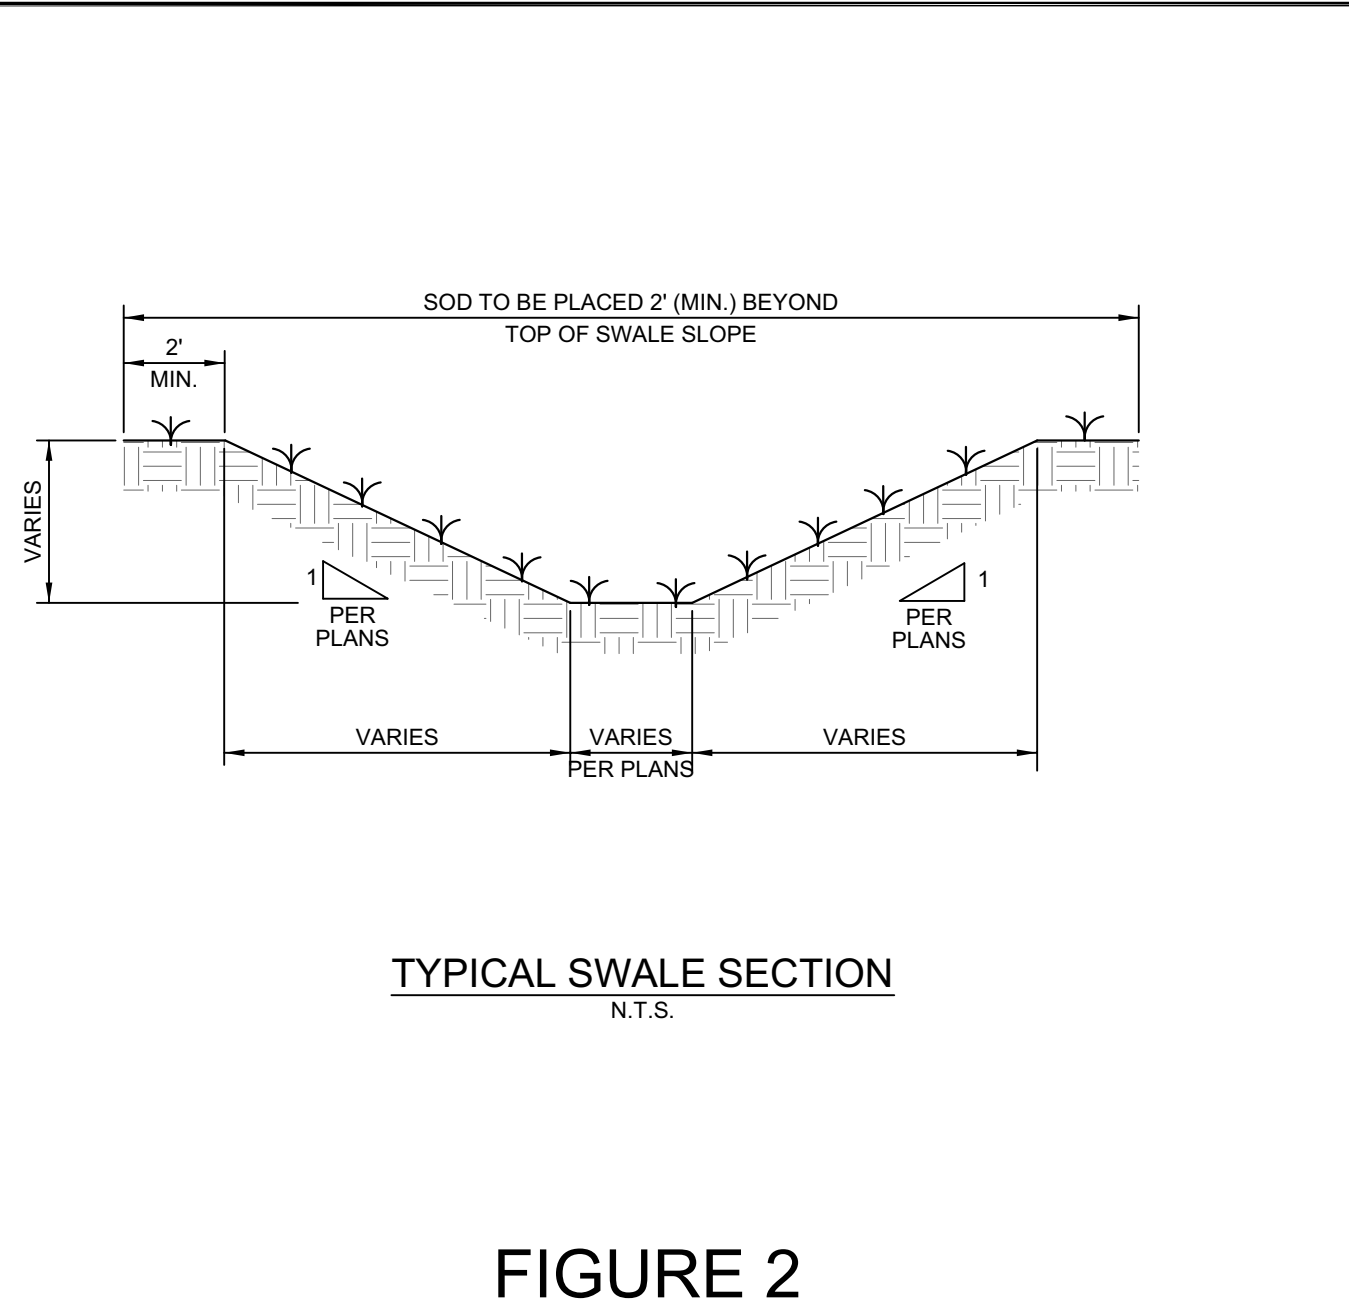
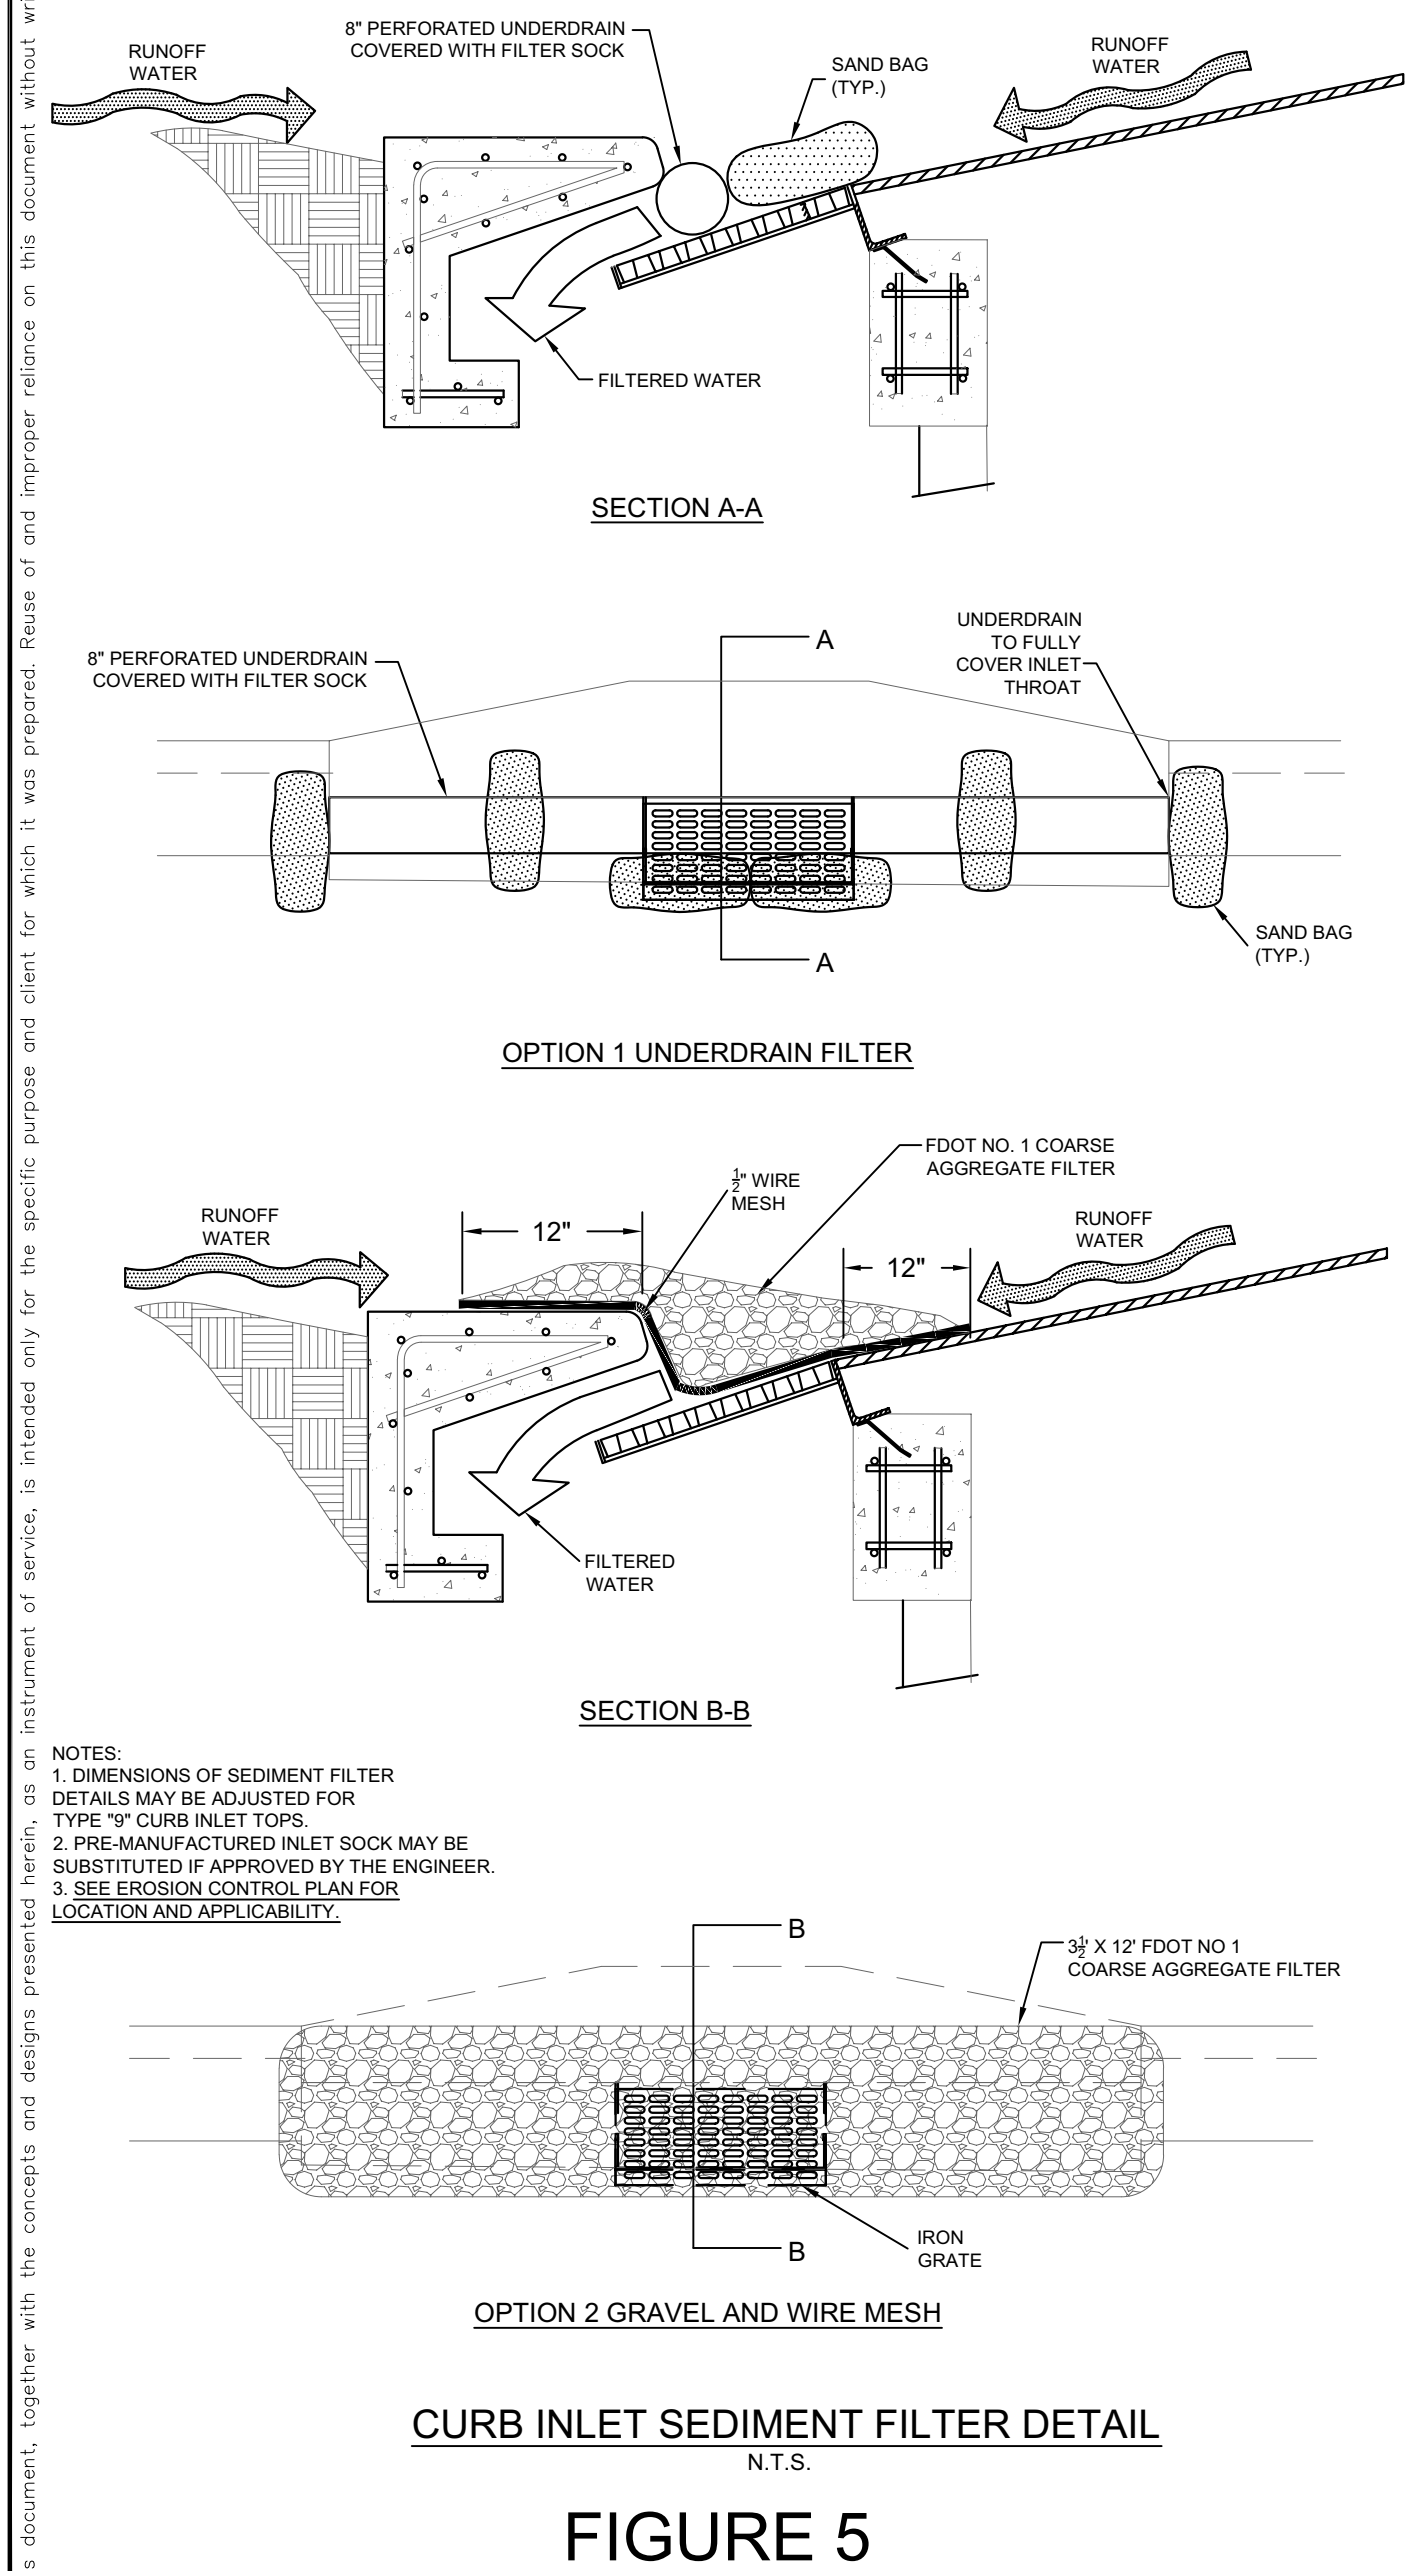
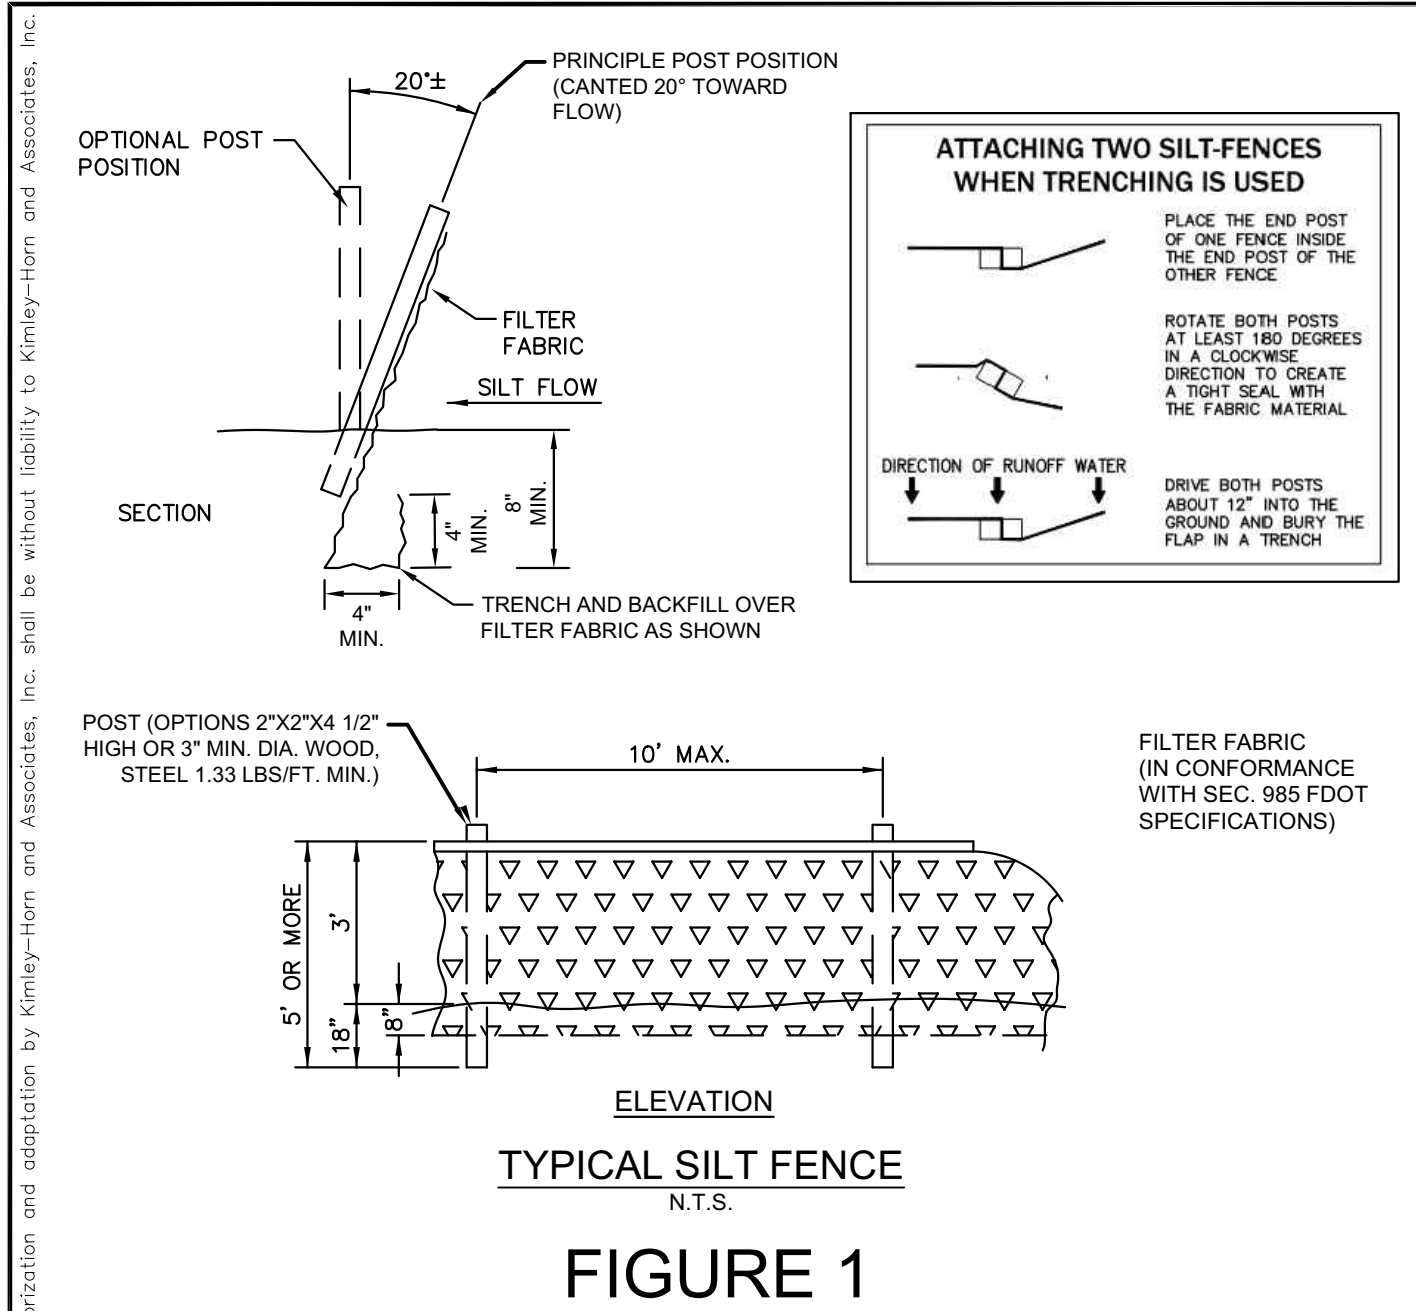
**STORMWATER POLLUTION  
PREVENTION NOTES**

**TOM PETTY PARK  
PICKLEBALL IMPROVEMENTS  
PREPARED FOR  
CITY OF GAINESVILLE  
WILD SPACES & PUBLIC PLACES**  
FLORIDA  
GAINESVILLE

SHEET NUMBER

**C3.1**

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DATE: 02/13/25  
LD24-000087  
Intermediate - Tom Petty Park Pickleball

DESIGN	05-21-24	-
DEVELOPMENT	07-02-24	-
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REVIEW	-	-
BID ADDENDUM NO. 1	-	-
NOT FOR CONSTRUCTION	-	-
REVISIONS	DATE	BY
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PROFESSIONAL ENGINEER  
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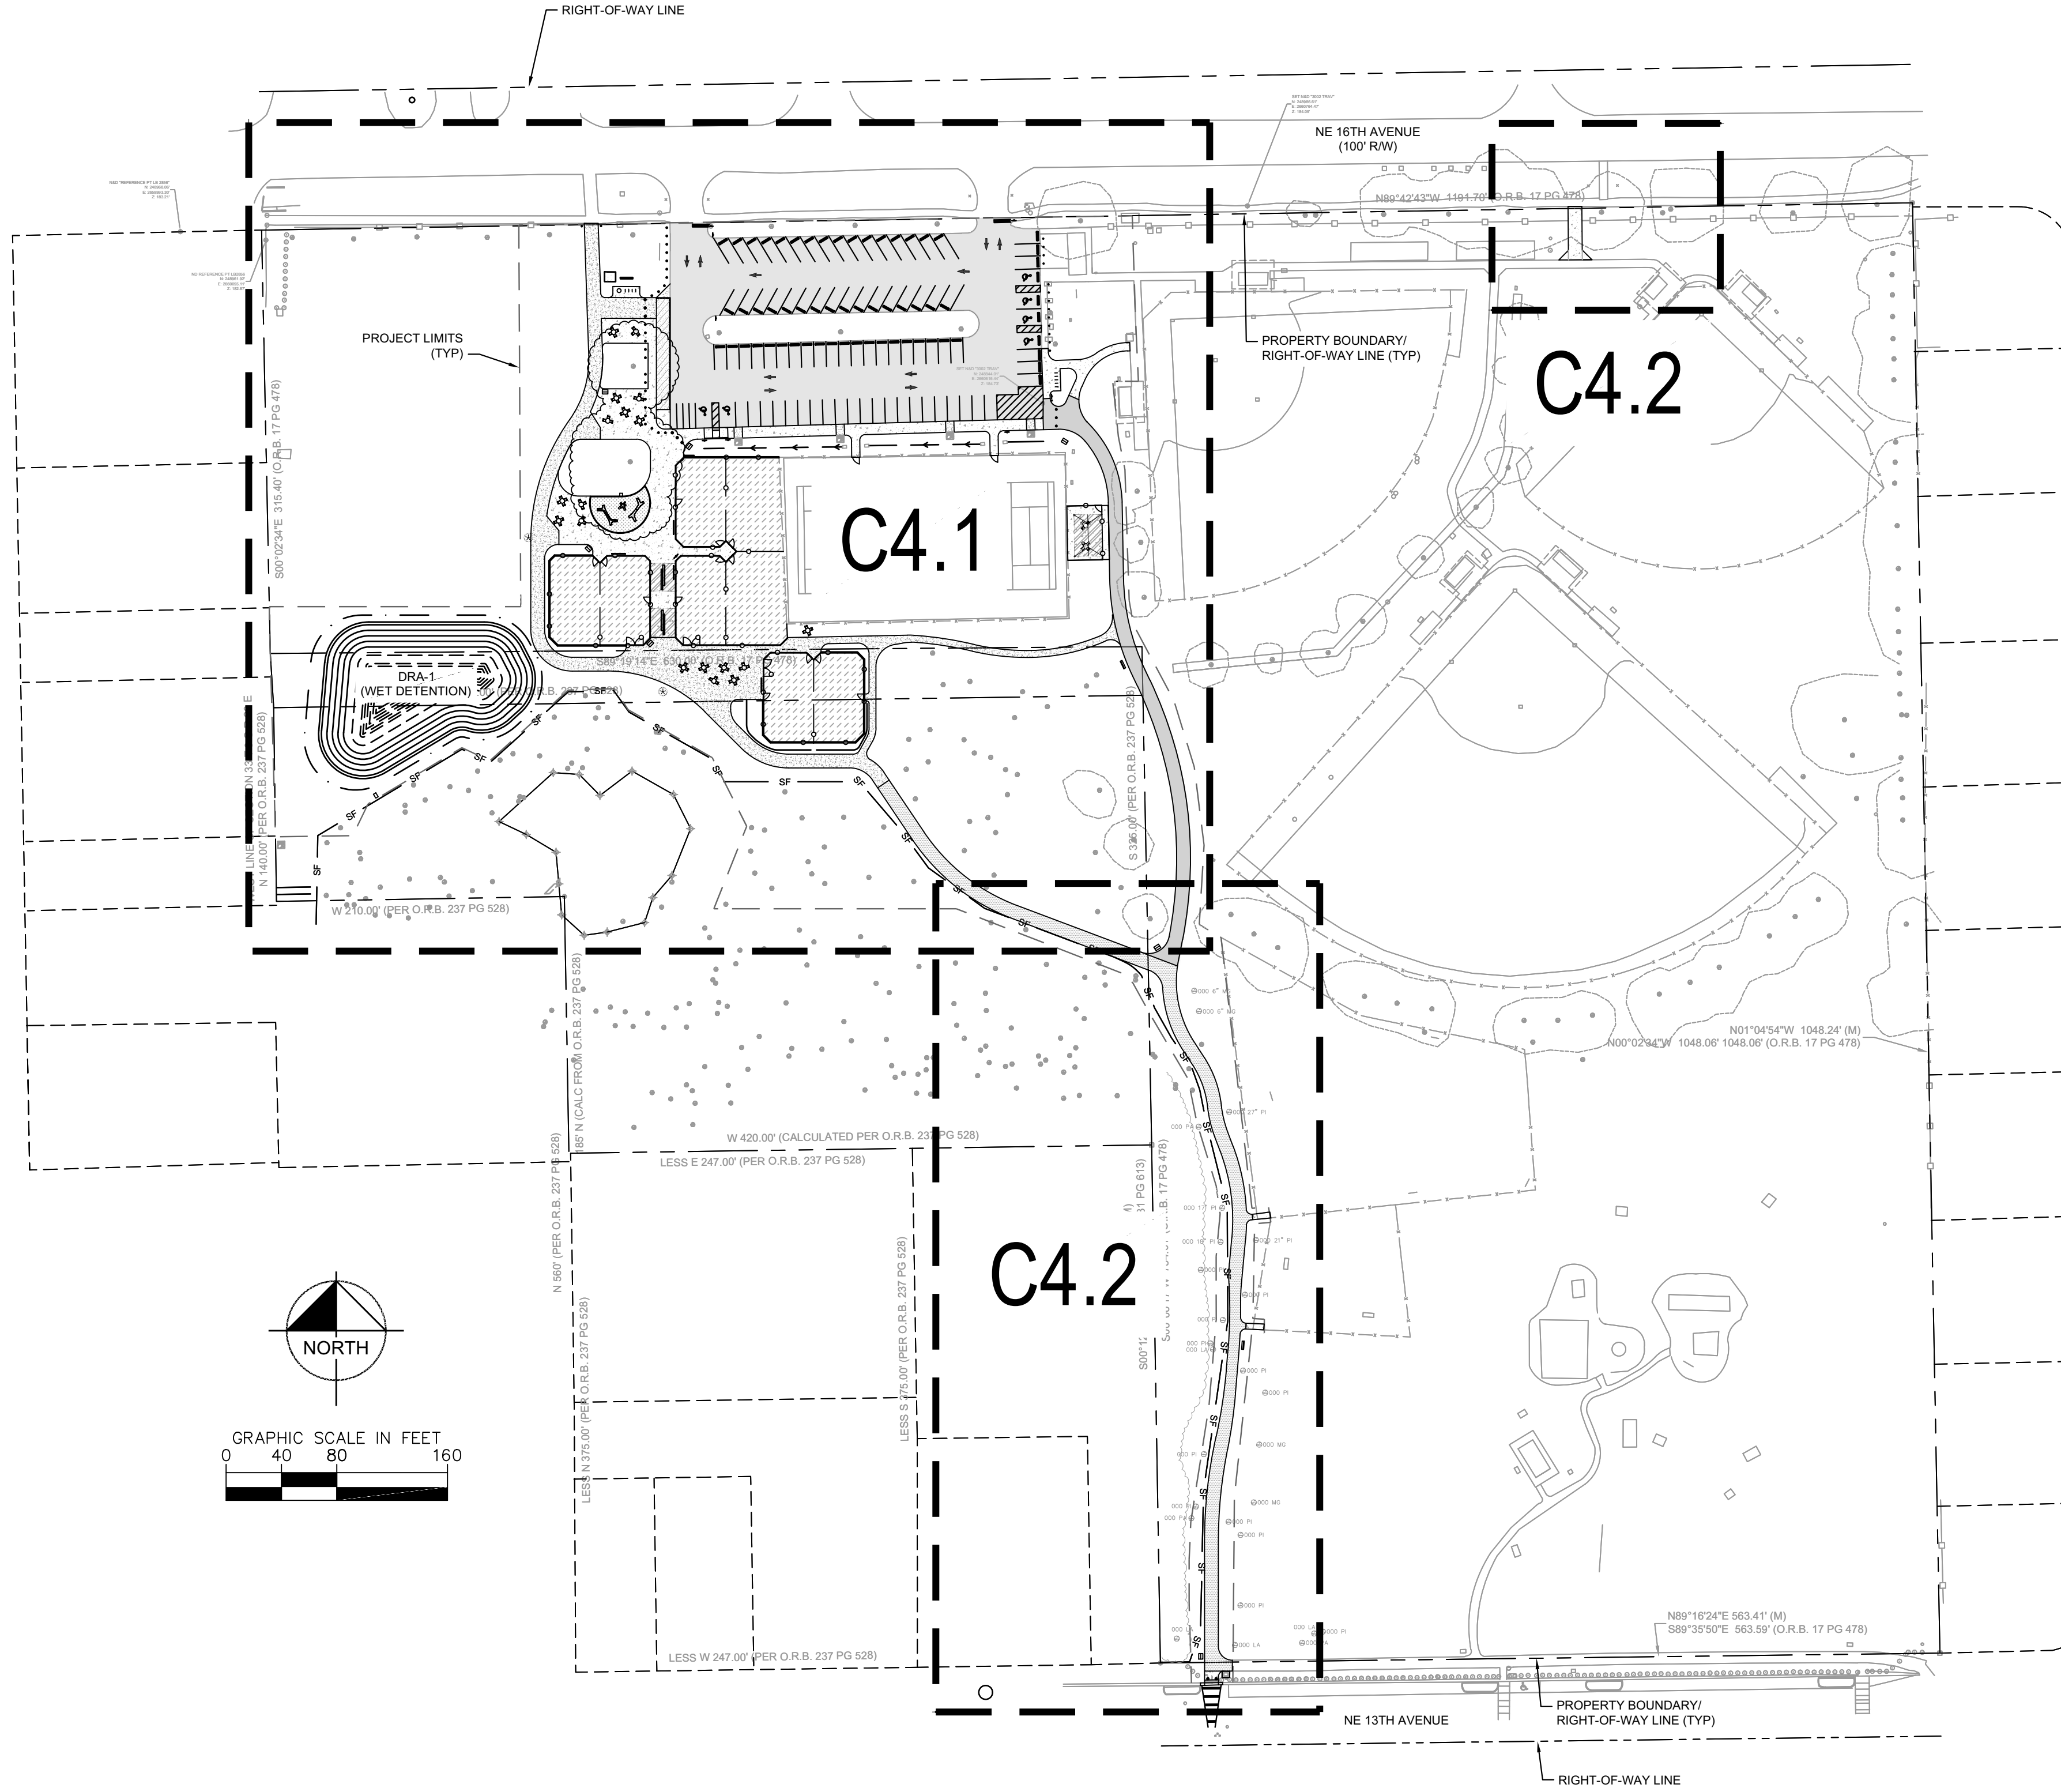
STORMWATER POLLUTION  
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TOM PETTY PARK  
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FLORIDA  
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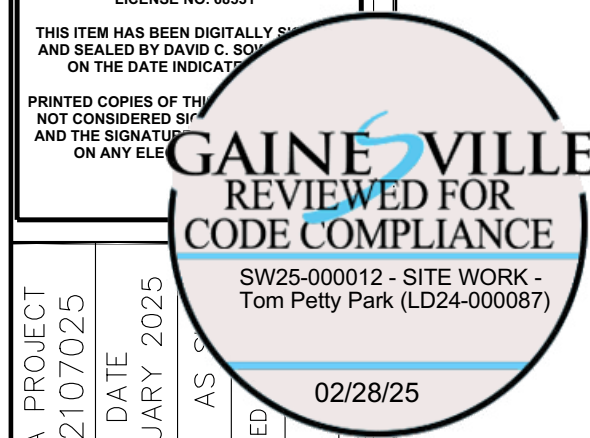


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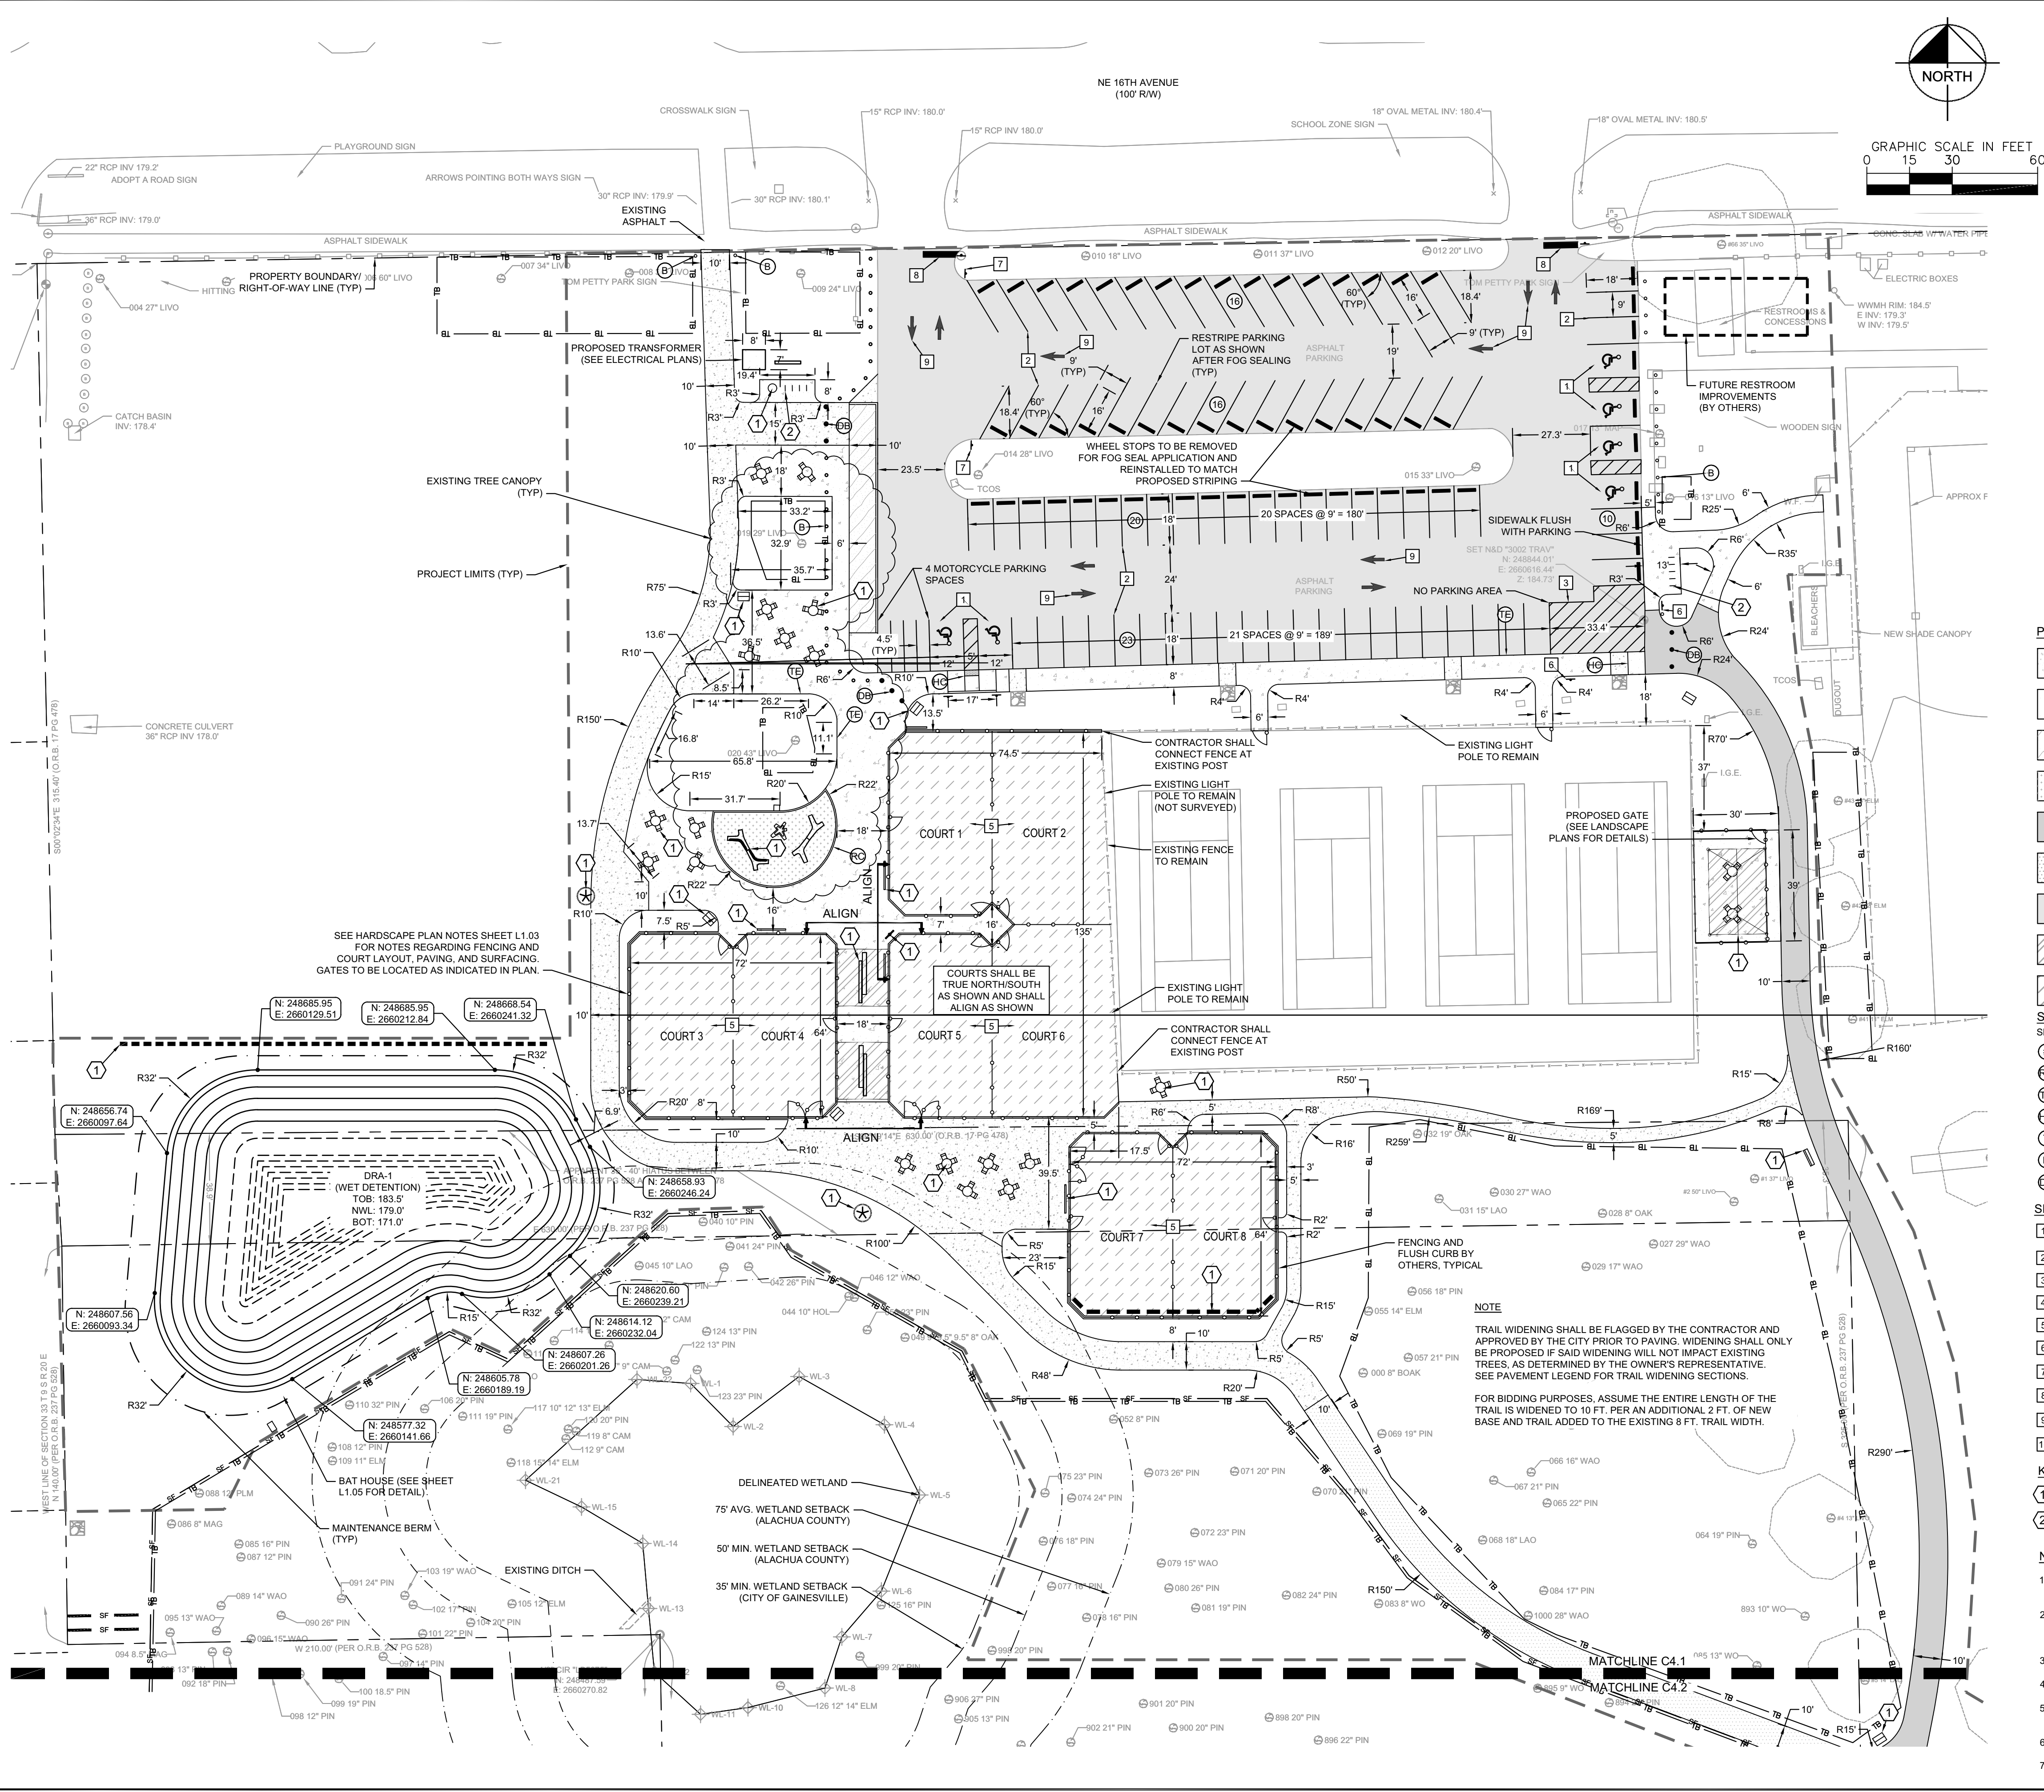
**OVERALL SITE GEOMETRY  
AND MARKING PLAN**

**TOM PETTY PARK  
PICKLEBALL IMPROVEMENTS  
PREPARED FOR  
CITY OF GAINESVILLE  
WILD SPACES & PUBLIC PLACES**  
FLORIDA

SHEET NUMBER  
**C4.0**

K:\SOL\_L\142107025 - Tom Petty Construction Docs\CA\WORKING FILES\CA\Drawings\CA\4.0 SITE GEOMETRY AND MARKING PLAN.dwg, LogSheet.C4.1 SITE GEOMETRY AND MARKING PLAN, Jan 22, 2025, deaneysmarkom

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#### PAVEMENT LEGEND

- 6" CONCRETE SIDEWALK (SEE DETAIL SHEET C7.0)
- 4" CONCRETE SIDEWALK (SEE DETAIL SHEET C7.0)
- #57 GRAVEL (SEE DETAIL SHEET C7.0)
- SYNTHETIC TURF (SEE DETAIL SHEET C7.0)
- ASPHALT PAVEMENT (SEE DETAIL SHEET C7.0)
- WIDENED ASPHALT PAVEMENT (SEE DETAIL SHEET C7.0)
- FOG SEALED ASPHALT PAVEMENT
- SHADE STRUCTURE (SEE LANDSCAPE PLANS FOR DETAILS)
- PICKLEBALL COURT (SEE LANDSCAPE PLANS FOR DETAILS)

#### SITE LEGEND

- SEE SHEET C7.0 FOR DETAILS
- PARKING STALLS
  - 6" RIBBON CURB (TYP)
  - THICKENED EDGE SIDEWALK (TYP)
  - ACCESSIBLE CURB RAMP (PER FDOT INDEX NO. 522-002)
  - 3" CURB TRANSITION (TYP)
  - BOLLARD (TYP) (SEE HARDSCAPE PLANS FOR DETAILS)
  - RETRACTABLE BOLLARD (TYP) (SEE HARDSCAPE PLANS FOR DETAILS)

#### SIGN AND PAVEMENT MARKING LEGEND

- HANDICAP SPACES PER FLORIDA'S ACCESSIBILITY CODE WITH SIGNS (SEE SHEET C7.0 FOR DETAILS)
- 4" WHITE STRIPE (TYP)
- 4" YELLOW STRIPE (TYP)
- RELOCATED NO MOTOR VEHICLES/DOGS ON LEASH SIGN
- PICKLEBALL COURT STRIPING (SEE LANDSCAPE PLANS FOR DETAILS)
- NO PARKING ALLOWED SIGN
- DO NOT ENTER SIGN (R5-1)
- 36" STOP SIGN (R1-1) AND 24" WHITE STOP BAR, MIN. 4" FROM CROSSWALK
- WHITE DIRECTIONAL ARROW PER FDOT INDEX 711-001
- SPECIAL EMPHASIS CROSSWALK PER FDOT INDEX 711-001


#### KEYNOTE LEGEND

- SITE FURNISHINGS OR NETTING (SEE HARDSCAPE PLANS FOR DETAILS)
- BIKE RACK (SEE HARDSCAPE PLANS FOR DETAILS)

#### NOTES:

- ALL WORK AND MATERIALS SHALL COMPLY WITH ALL CITY REGULATIONS AND CODES AND O.S.H.A. STANDARDS.
- PRIOR TO CONSTRUCTION WITHIN ANY EXISTING PUBLIC RIGHT-OF-WAY, THE CONTRACTOR SHALL OBTAIN ALL NECESSARY PERMITS FROM THE AUTHORITY HAVING JURISDICTION.
- MAXIMUM RUNNING SLOPE ON SIDEWALKS SHALL NOT EXCEED 5.00% (1:20).
- MAXIMUM CROSS SLOPE ON SIDEWALKS SHALL NOT EXCEED 2.00% (1:50).
- MAXIMUM SLOPE IN ACCESSIBLE PARKING AREAS SHALL NOT EXCEED 2.00% (1:50) IN ANY DIRECTION.
- SEE HARDSCAPE PLANS FOR SITE FURNISHING SPECIFICATIONS AND LAYOUT.
- EXPANSION JOINT LAYOUT TO MATCH EXISTING WALK INTERSECTION TO THE WEST.

DESIGN DEVELOPMENT SUBMITTAL	05-21-24	BY
90% CONSTRUCTION DOCUMENTS	07-02-24	
SITE DEVELOPMENT REVIEW	09-06-24	
SITE DEVELOPMENT REVIEW	12-20-24	
SITE DEVELOPMENT REVIEW & BID ADDENDUM NO. 1	01-21-25	
NOT FOR CONSTRUCTION		
REVISIONS	DATE	BY
No.		

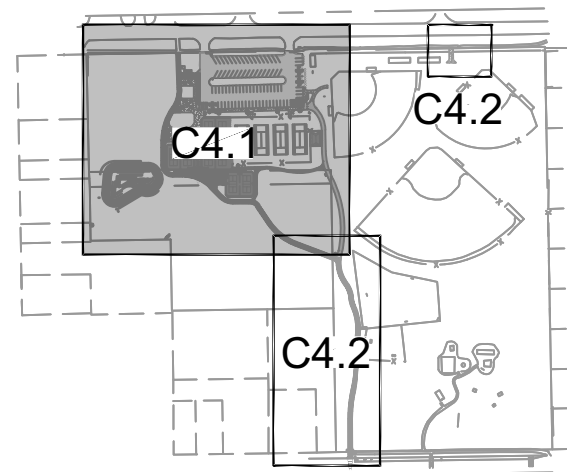

#### KEY MAP

SCALE: 1" = 500'

GAINEVILLE  
APPROVED

DATE: 02/13/25  
LD24-000087  
Intermediate - Tom Petty Park Pickleball

Kimley»Horn

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800 SW 2ND AVENUE, SUITE 100, GAINESVILLE, FL 32601  
PHONE: 352-374-3274  
WWW.KIMLEY-HORN.COM REGISTRY NO. 35106

2025.01.22 17:04:49:05:00  
DAVID C. SOWELL, P.E.  
STATE OF FLORIDA  
PROFESSIONAL ENGINEER  
LICENSE NO. 68631

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GAINEVILLE  
REVIEWED FOR  
CODE COMPLIANCE

SW25-000012 - SITE WORK  
Tom Petty Park (LD24-000087)




02/28/25

SITE GEOMETRY AND  
MARKING PLAN

TOM PETTY PARK  
PICKLEBALL IMPROVEMENTS  
PREPARED FOR  
CITY OF GAINESVILLE  
WILD SPACES & PUBLIC PLACES  
FLORIDA

SHEET NUMBER  
C4.1

K:\SOL\_LA\142107025 - Tom Petty Construction Docs\04-WORKING FILES\CA0\PlanSheet\CA0.C4.0 SITE GEOMETRY AND MARKING PLAN.dwg, LogSheet.C4.2 SITE GEOMETRY AND MARKING PLAN Jun 22, 2025 dseanymarkham  
PLOT: Addplot=142107025.ctb Plotter=HP DesignJet 4000-600 Plot Style=HP DesignJet 4000-600.ctb Plot Date=06/22/2025 Plot Time=10:02:25 Plot User=dseanymarkham  
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SEE SHEET C7.0 FOR DETAILS
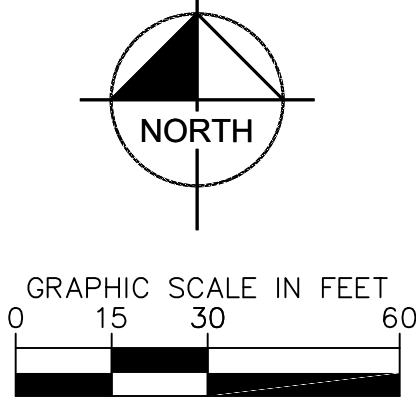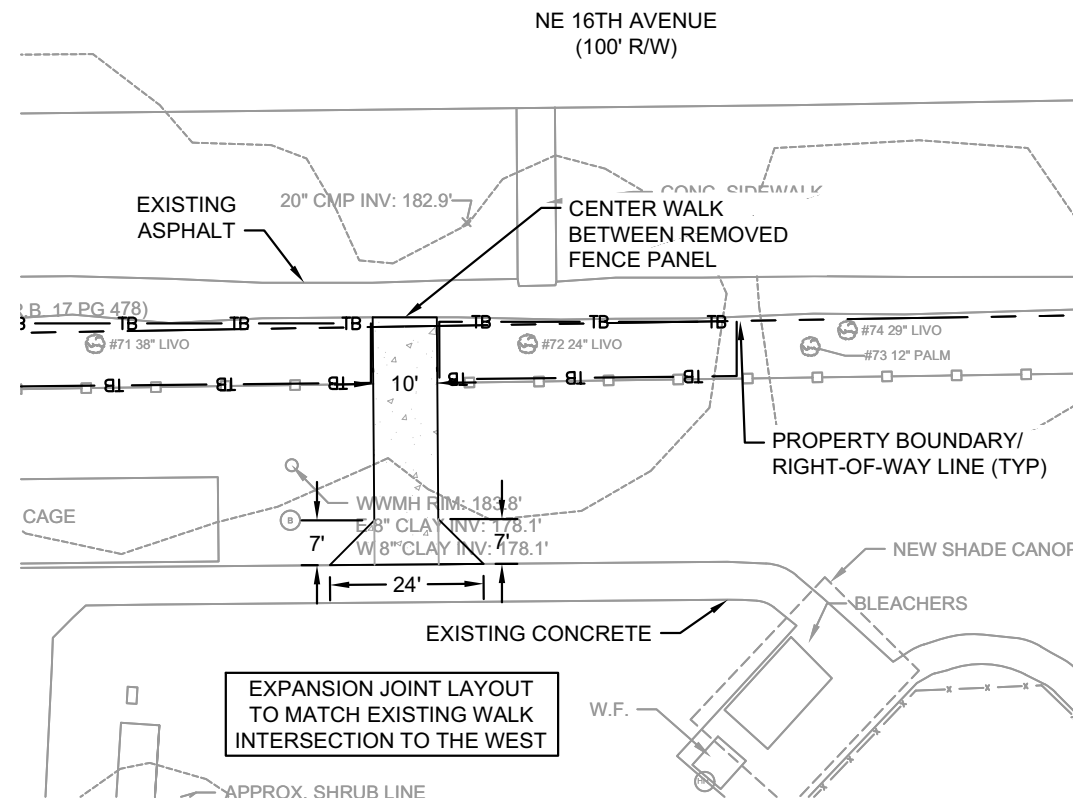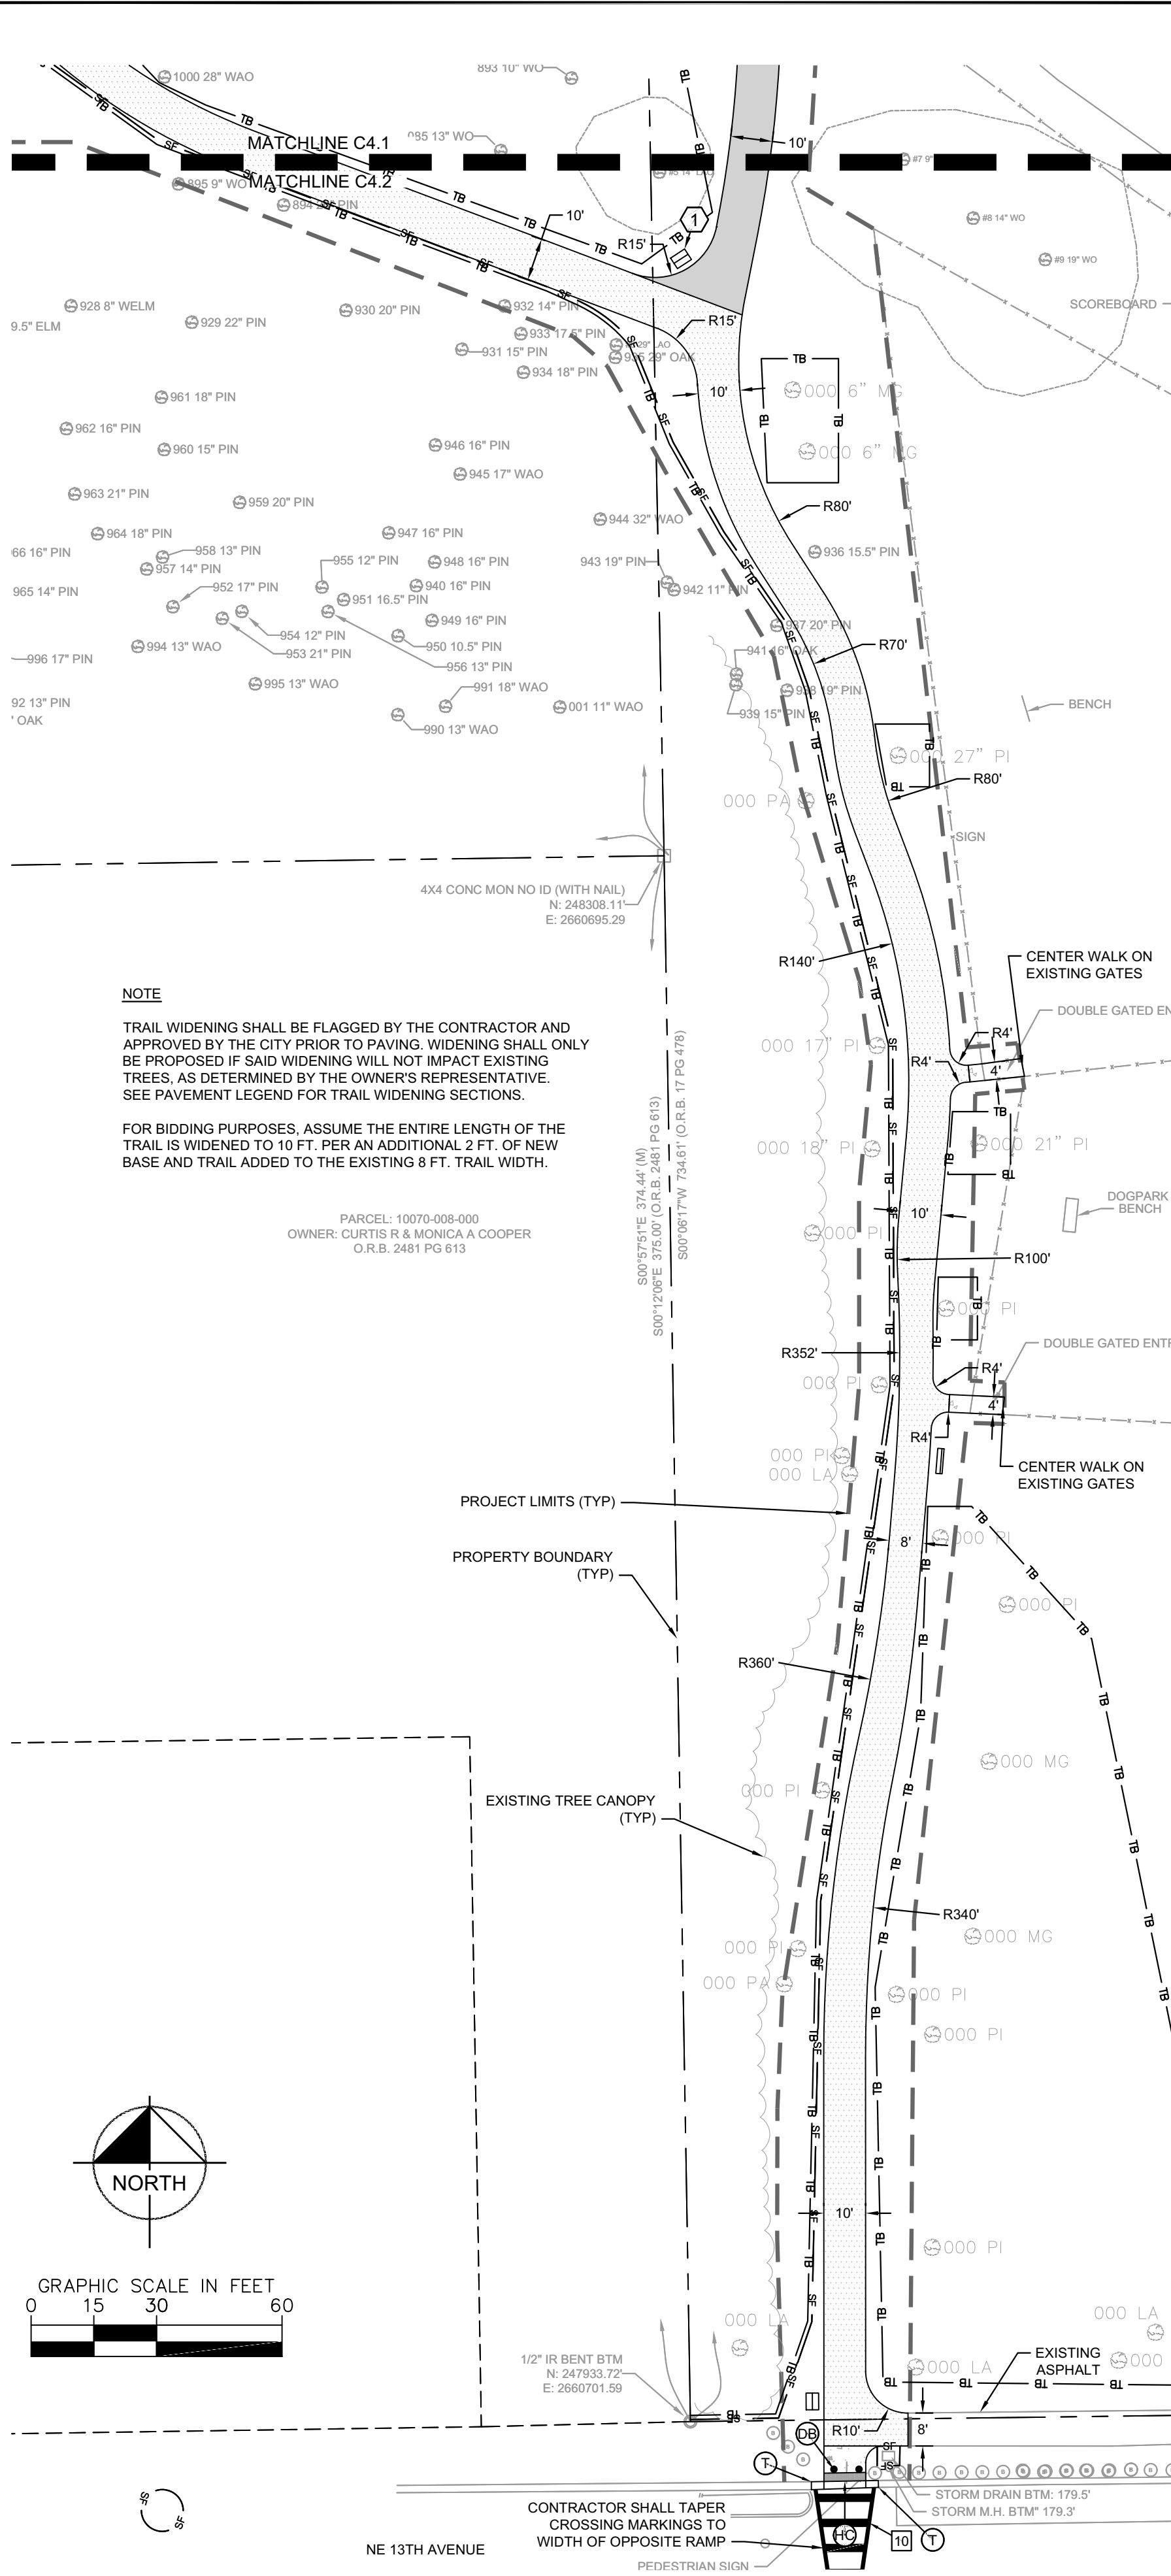
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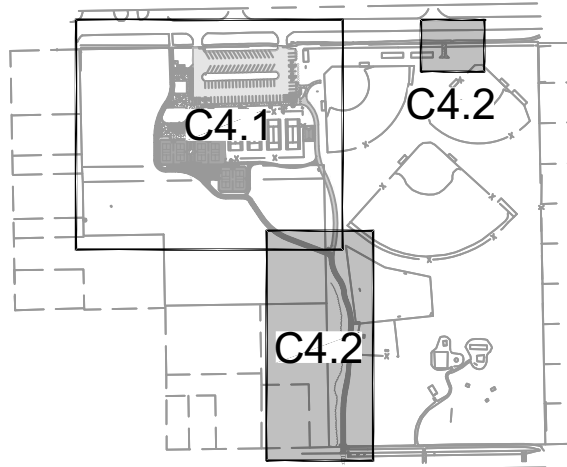
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#### KEYNOTE LEGEND

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DESIGN DEVELOPMENT SUBMITTAL	05-21-24	07-02-24	09-06-24	12-20-24	01-21-25	DATE	BY
90% CONSTRUCTION DOCUMENTS	-	-	-	-	-		
SITE DEVELOPMENT REVIEW	-	-	-	-	-		
SITE DEVELOPMENT REVIEW & BID ADDENDUM NO. 1	-	-	-	-	-		
NOT FOR CONSTRUCTION	-	-	-	-	-		
No.							



KEY MAP  
SCALE: 1" = 500'

GAINEVILLE APPROVED

DATE: 02/13/25  
LD24-000087  
Intermediate - Tom Petty Park Pickleball

Kimley»Horn

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PHONE: 352-374-3274  
WWW.KIMLEY-HORN.COM REGISTRY NO. 35106

2025.01.22 17:04:49-05:00  
DAVID C. SOWELL, P.E.  
STATE OF FLORIDA  
PROFESSIONAL ENGINEER  
LICENSE NO. 66831

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GAINEVILLE REVIEWED FOR CODE COMPLIANCE


SW25-000012 - SITE WORK  
Tom Petty Park (LD24-000087)

02/28/25

SITE GEOMETRY AND MARKING PLAN

TOM PETTY PARK  
PICKLEBALL IMPROVEMENTS  
PREPARED FOR  
CITY OF GAINESVILLE  
WILD SPACES & PUBLIC PLACES  
FLORIDA

SHEET NUMBER  
C4.2

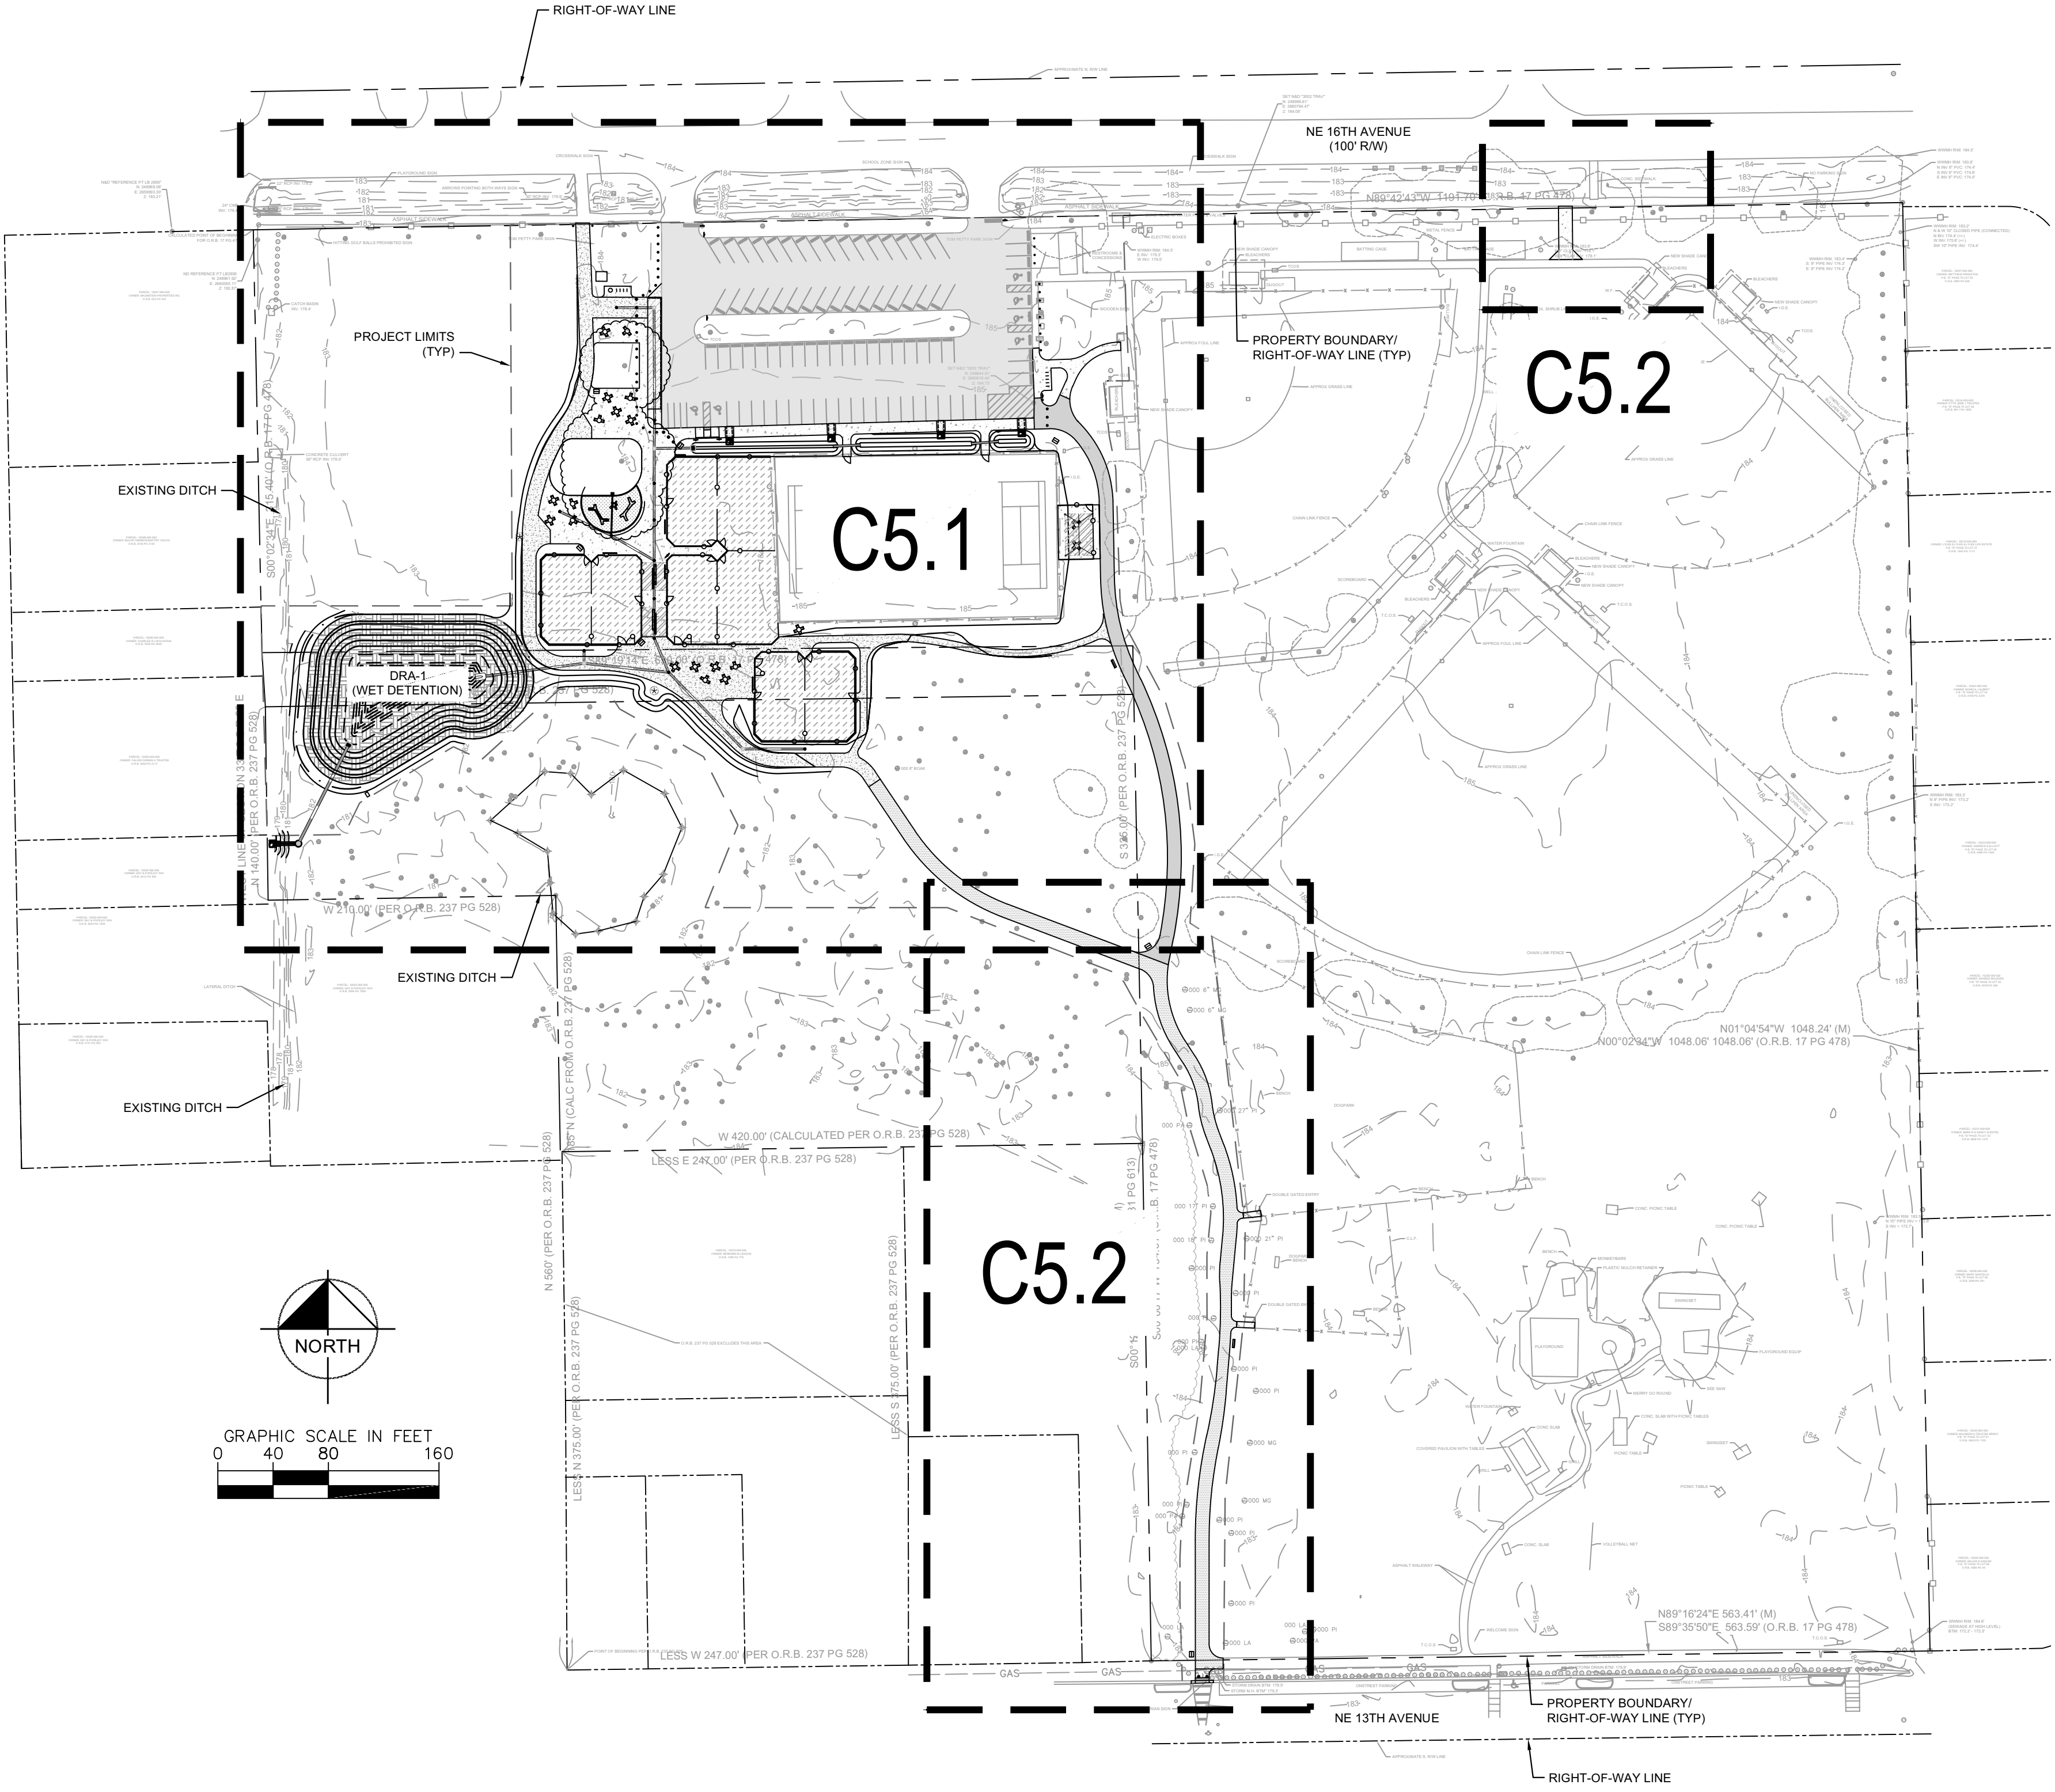

1. CONTRACTOR SHALL LOCATE, PROTECT, AND MAINTAIN 36" MIN. COVER OVER EXISTING GRU GAS MAIN AND GAS SERVICE DURING ALL PHASES OF DEMOLITION/CONSTRUCTION.
2. CONTRACTOR SHALL CONTACT GRU GAS OPERATIONS SUPERVISOR WESLEY LESTER AT (352) 538-2570 SEVEN (7) DAYS PRIOR TO THE START OF DEMOLITION.

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[illegible]

DATE: 02/13/25  
LD24-000087 -  
Intermediate - Tom  
Petty Park Pickleball

**Kimley»»Horn**

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DAVID C. SOWELL, P.E.

STATE OF FLORIDA,  
PROFESSIONAL ENGINEER,  
LICENSE NO. 68531

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**REVIEW**

**GAINEVILLE**  
REVIEWED FOR  
CODE COMPLIANCE

SW25-000012 - SITE WORK -  
Tom Petty Park (LD24-000087)

02/28/25

KHA PROJECT  
142107025

DATE  
JANUARY 2025

DESIGNED

02/28/

25

ORK -  
(00087)

# OVERALL PAVING GRADING AND DRAINAGE PLAN

**TOM PETTY PARK  
PICKLEBALL IMPROVEMENTS  
PREPARED FOR  
CITY OF GAINESVILLE  
WILD SPACES & PUBLIC PLACES**

GAINESVILLE  
FLORIDA

SHEET NUMBER

## C5.0

DESIGN DEVELOPMENT SUBMITTAL	05-21-24	BY
90% CONSTRUCTION DOCUMENTS	07-02-24	
SITE DEVELOPMENT REVIEW	09-06-24	
SITE DEVELOPMENT REVIEW	12-20-24	
SITE DEVELOPMENT REVIEW & BID ADDENDUM NO. 1	01-21-25	
NOT FOR CONSTRUCTION	-	
REVISIONS	DATE	BY
No.		

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DAVID C. SOWELL, P.E.  
STATE OF FLORIDA  
PROFESSIONAL ENGINEER  
LICENSE NO. 66631

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REVIEWED FOR  
CODE COMPLIANCE

SW25-000012 - SITE WORK  
Tom Petty Park (LD24-000087)

02/28/25




PAVING, GRADING, AND  
DRAINAGE PLAN

TOM PETTY PARK  
PICKLEBALL IMPROVEMENTS  
PREPARED FOR  
CITY OF GAINESVILLE  
WILD SPACES & PUBLIC PLACES  
FLORIDA

SHEET NUMBER  
**C5.1**

# URBAN FORESTRY NOTES:

- CONTACT THE URBAN FORESTRY INSPECTOR AT (352) 334-5023 FOR REVIEW AND APPROVAL REGARDING CONSTRUCTION METHODS AND PRIOR TO ANY SITEWORK ACTIVITIES WITHIN THE DRIPLINE OF THE TWO LARGE EXISTING LIVE OAKS NEAR THE SW CORNER OF THE EXISTING PARKING LOT. HAND EXCAVATION OR AIR-SPADING IS REQUIRED FOR CONSTRUCTION ACTIVITIES THAT OCCUR UNDER THE DRIPLINE OF THESE TWO LIVE OAKS. ADDITIONALLY, IF TREE OR ROOT PRUNING IS REQUIRED, THESE ACTIVITIES SHALL BE PERFORMED BY AN ARBORIST CERTIFIED BY THE INTERNATIONAL SOCIETY OF ARBORICULTURE (ISA). PRUNING SHALL BE DONE IN ACCORDANCE WITH THE MOST CURRENT VERSION OF THE AMERICAN NATIONAL STANDARD FOR TREE CARE OPERATIONS "TREE, SHRUB AND OTHER WOODY PLANT MAINTENANCE" (ANSI A300) AND "PRUNING, TRIMMING, REPAIRING, MAINTAINING, AND REMOVING TREES - SAFETY REQUIREMENTS" (ANSI Z133). TREE AND/OR ROOT PRUNING ACTIVITIES FOR HIGH QUALITY HERITAGE TREES SHALL BE OVERSEEN DIRECTLY, ON SITE, BY AN ISA-CERTIFIED ARBORIST. MINIMIZE IMPACTS ON EXISTING TREE ROOTS AS MUCH AS POSSIBLE. AVOID TREE ROOT PLATE AREAS AS DEFINED BY PERMITTING AGENCIES. ALL ROOTS OF TREES TO REMAIN THAT ARE ADJACENT TO EXTENSIVE EXCAVATION AND ARE 1" DIAMETER OR OVER SHALL BE HAND CUT, EXPOSE ROOTS BY HAND DIGGING, HAND CUT OR SAW CLEANLY, AND IMMEDIATELY COVER WITH SOIL. DO NOT ALLOW CUT ROOTS TO DRY OUT. SUPPLEMENTAL IRRIGATION IS REQUIRED FOR TREES THAT HAVE UNDERGONE ROOT PRUNING AND SHALL BE PROVIDED IMMEDIATELY FOLLOWING ROOT TRIMMING ACTIVITIES.

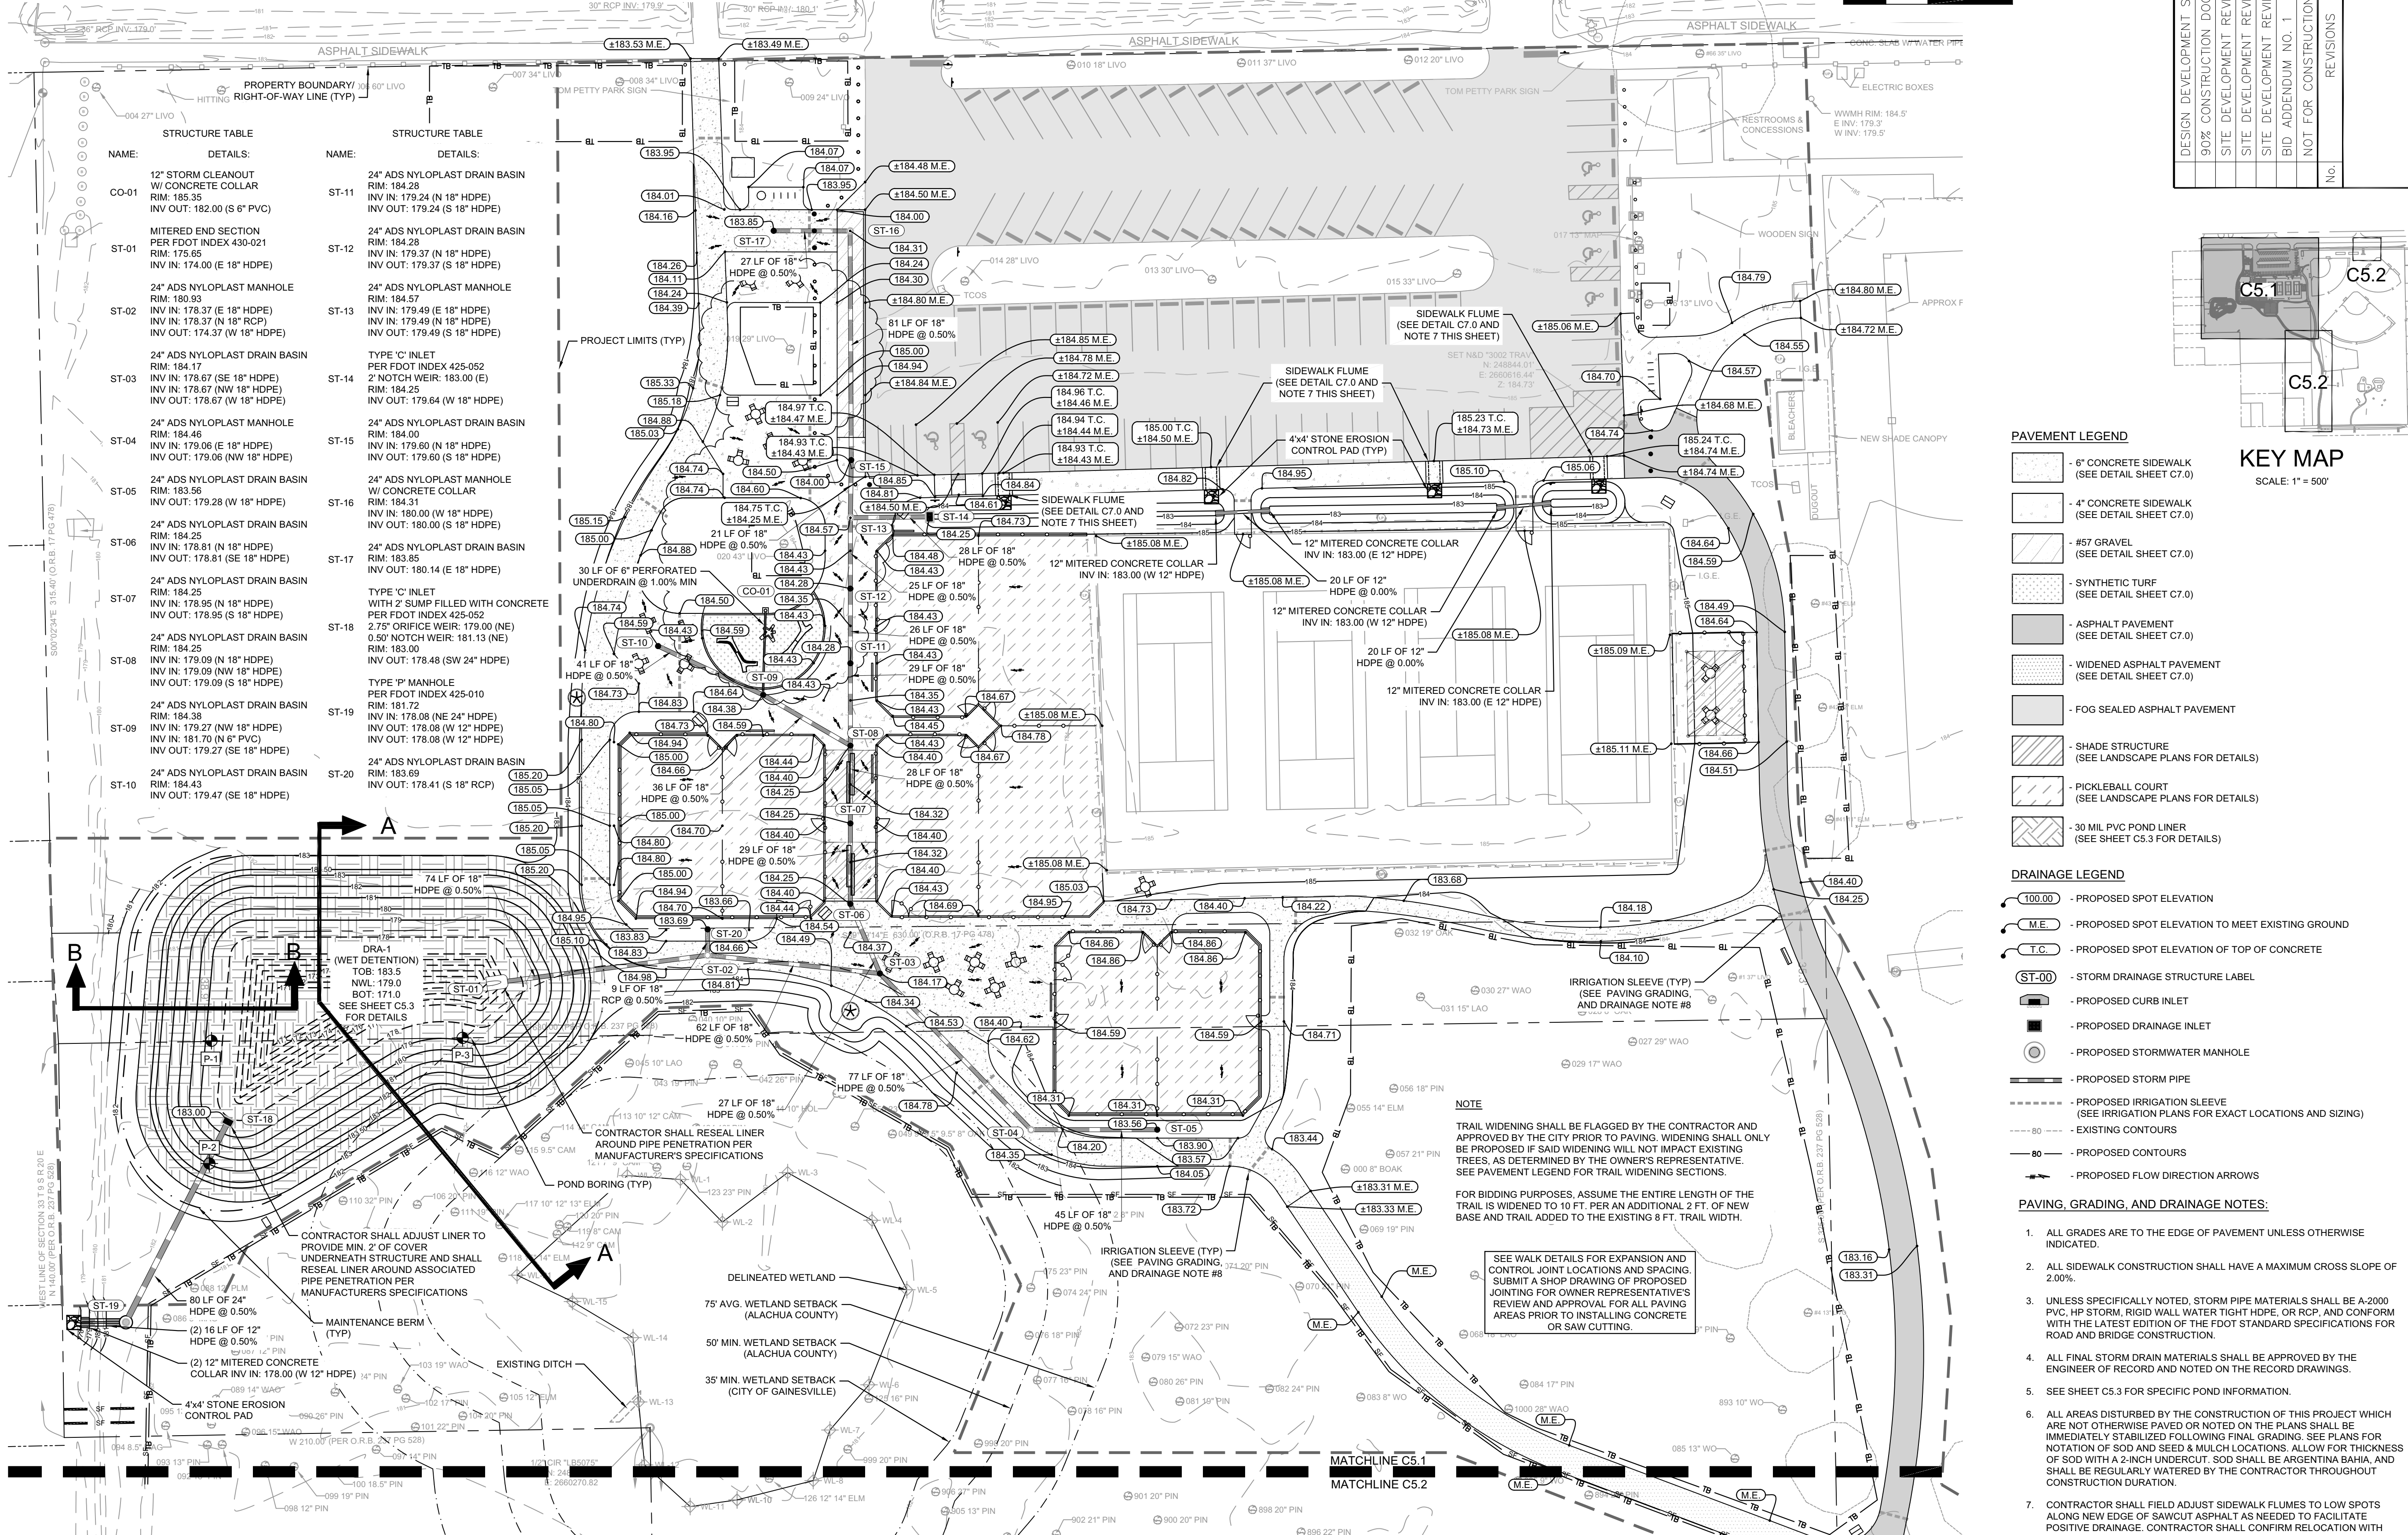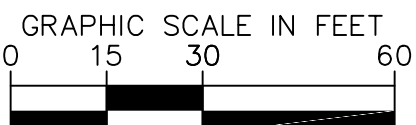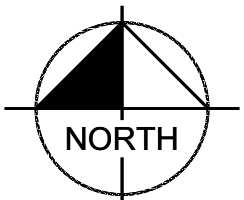

## PAVEMENT LEGEND

- 6" CONCRETE SIDEWALK (SEE DETAIL SHEET C7.0)
- 4" CONCRETE SIDEWALK (SEE DETAIL SHEET C7.0)
- #57 GRAVEL (SEE DETAIL SHEET C7.0)
- SYNTHETIC TURF (SEE DETAIL SHEET C7.0)
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- WIDENED ASPHALT PAVEMENT (SEE DETAIL SHEET C7.0)
- FOG SEALED ASPHALT PAVEMENT
- SHADE STRUCTURE (SEE LANDSCAPE PLANS FOR DETAILS)
- PICKLEBALL COURT (SEE LANDSCAPE PLANS FOR DETAILS)
- 30 MIL PVC POND LINER (SEE SHEET C5.3 FOR DETAILS)


## DRAINAGE LEGEND

- 100.00 - PROPOSED SPOT ELEVATION
- M.E. - PROPOSED SPOT ELEVATION TO MEET EXISTING GROUND
- T.C. - PROPOSED SPOT ELEVATION OF TOP OF CONCRETE
- ST-00 - STORM DRAINAGE STRUCTURE LABEL
- PROPOSED CURB INLET
- PROPOSED DRAINAGE INLET
- PROPOSED STORMWATER MANHOLE
- PROPOSED STORM PIPE
- PROPOSED IRRIGATION SLEEVE (SEE IRRIGATION PLANS FOR EXACT LOCATIONS AND SIZING)
- EXISTING CONTOURS
- PROPOSED CONTOURS
- PROPOSED FLOW DIRECTION ARROWS

## PAVING, GRADING, AND DRAINAGE NOTES:

- ALL GRADES ARE TO THE EDGE OF PAVEMENT UNLESS OTHERWISE INDICATED.
- ALL SIDEWALK CONSTRUCTION SHALL HAVE A MAXIMUM CROSS SLOPE OF 2.00%.
- UNLESS SPECIFICALLY NOTED, STORM PIPE MATERIALS SHALL BE A-2000 PVC, HP, STORM, RIGID WALL, WATER TIGHT HDPE, OR RCP, AND CONFORM WITH THE LATEST EDITION OF THE FDOT STANDARD SPECIFICATIONS FOR ROAD AND BRIDGE CONSTRUCTION.
- ALL FINAL STORM DRAIN MATERIALS SHALL BE APPROVED BY THE ENGINEER OF RECORD AND NOTED ON THE RECORD DRAWINGS.
- SEE SHEET C5.3 FOR SPECIFIC POND INFORMATION.
- ALL AREAS DISTURBED BY THE CONSTRUCTION OF THIS PROJECT WHICH ARE NOT OTHERWISE PAVED OR NOTED ON THE PLANS SHALL BE IMMEDIATELY STABILIZED FOLLOWING FINAL GRADING. SEE PLANS FOR NOTATION OF SOD AND SEED & MULCH LOCATIONS. ALLOW FOR THICKNESS OF SOD WITH A 2-INCH UNDERCUT. SOD SHALL BE ARGENTINA BAHIA, AND SHALL BE REGULARLY WATERED BY THE CONTRACTOR THROUGHOUT CONSTRUCTION DURATION.
- CONTRACTOR SHALL FIELD ADJUST SIDEWALK FLUMES TO LOW SPOTS ALONG NEW EDGE OF SAWCUT ASPHALT AS NEEDED TO FACILITATE POSITIVE DRAINAGE. CONTRACTOR SHALL CONFIRM RELOCATION WITH ENGINEER OF RECORD PRIOR TO CONSTRUCTING.
- SEE IRRIGATION PLANS FOR EXACT LOCATIONS AND SIZING OF PROPOSED IRRIGATION SLEEVES.

DESIGN DEVELOPMENT SUBMITTAL	05-21-24	-
90% CONSTRUCTION DOCUMENTS	07-02-24	-
SITE DEVELOPMENT REVIEW	09-06-24	-
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SITE DEVELOPMENT REVIEW &		
BID ADDENDUM NO. 1	01-21-25	-
NOT FOR CONSTRUCTION	-	-
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

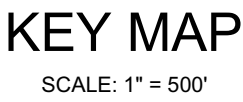



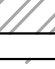
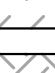
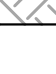
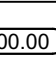
SW25-000012 - SITE WORK -  
Tom Petty Park (LD24-000087)

02/28/25

**TOM PETTY PARK  
PICKLEBALL IMPROVEMENTS  
PREPARED FOR  
CITY OF GAINESVILLE  
WILD SPACES & PUBLIC PLACES  
GAINESVILLE, FLORIDA**

SHEET NUMBER

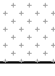
## C5.2

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(SEE DETAIL SHEET C7.0)
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-  - 30 MIL PVC POND LINER  
(SEE SHEET C5.3 FOR DETAILS)



	- PROPOSED SPOT ELEVATION
	- PROPOSED SPOT ELEVATION TO MEET EXISTING GROUND
	- PROPOSED SPOT ELEVATION OF TOP OF CONCRETE
	- STORM DRAINAGE STRUCTURE LABEL
	- PROPOSED CURB INLET
	- PROPOSED DRAINAGE INLET
	- PROPOSED STORMWATER MANHOLE
	- PROPOSED STORM PIPE
	- PROPOSED IRRIGATION SLEEVE (SEE IRRIGATION PLANS FOR EXACT LOCATIONS AND SIZING)
	- EXISTING CONTOURS
	- PROPOSED CONTOURS
	- PROPOSED FLOW DIRECTION ARROWS

1. CONTRACTOR SHALL LOCATE, PROTECT, AND MAINTAIN 36" MIN. COVER OVER EXISTING GRU GAS MAIN AND GAS SERVICE DURING ALL PHASES OF DEMOLITION/CONSTRUCTION.
2. CONTRACTOR SHALL CONTACT GRU GAS OPERATIONS SUPERVISOR WESLEY LESTER AT (352) 538-2570 SEVEN (7) DAYS PRIOR TO THE START OF DEMOLITION.

Case 1:23-cv-01272-UNA Document 1-1 Filed 06/20/23 Page 1 of 1

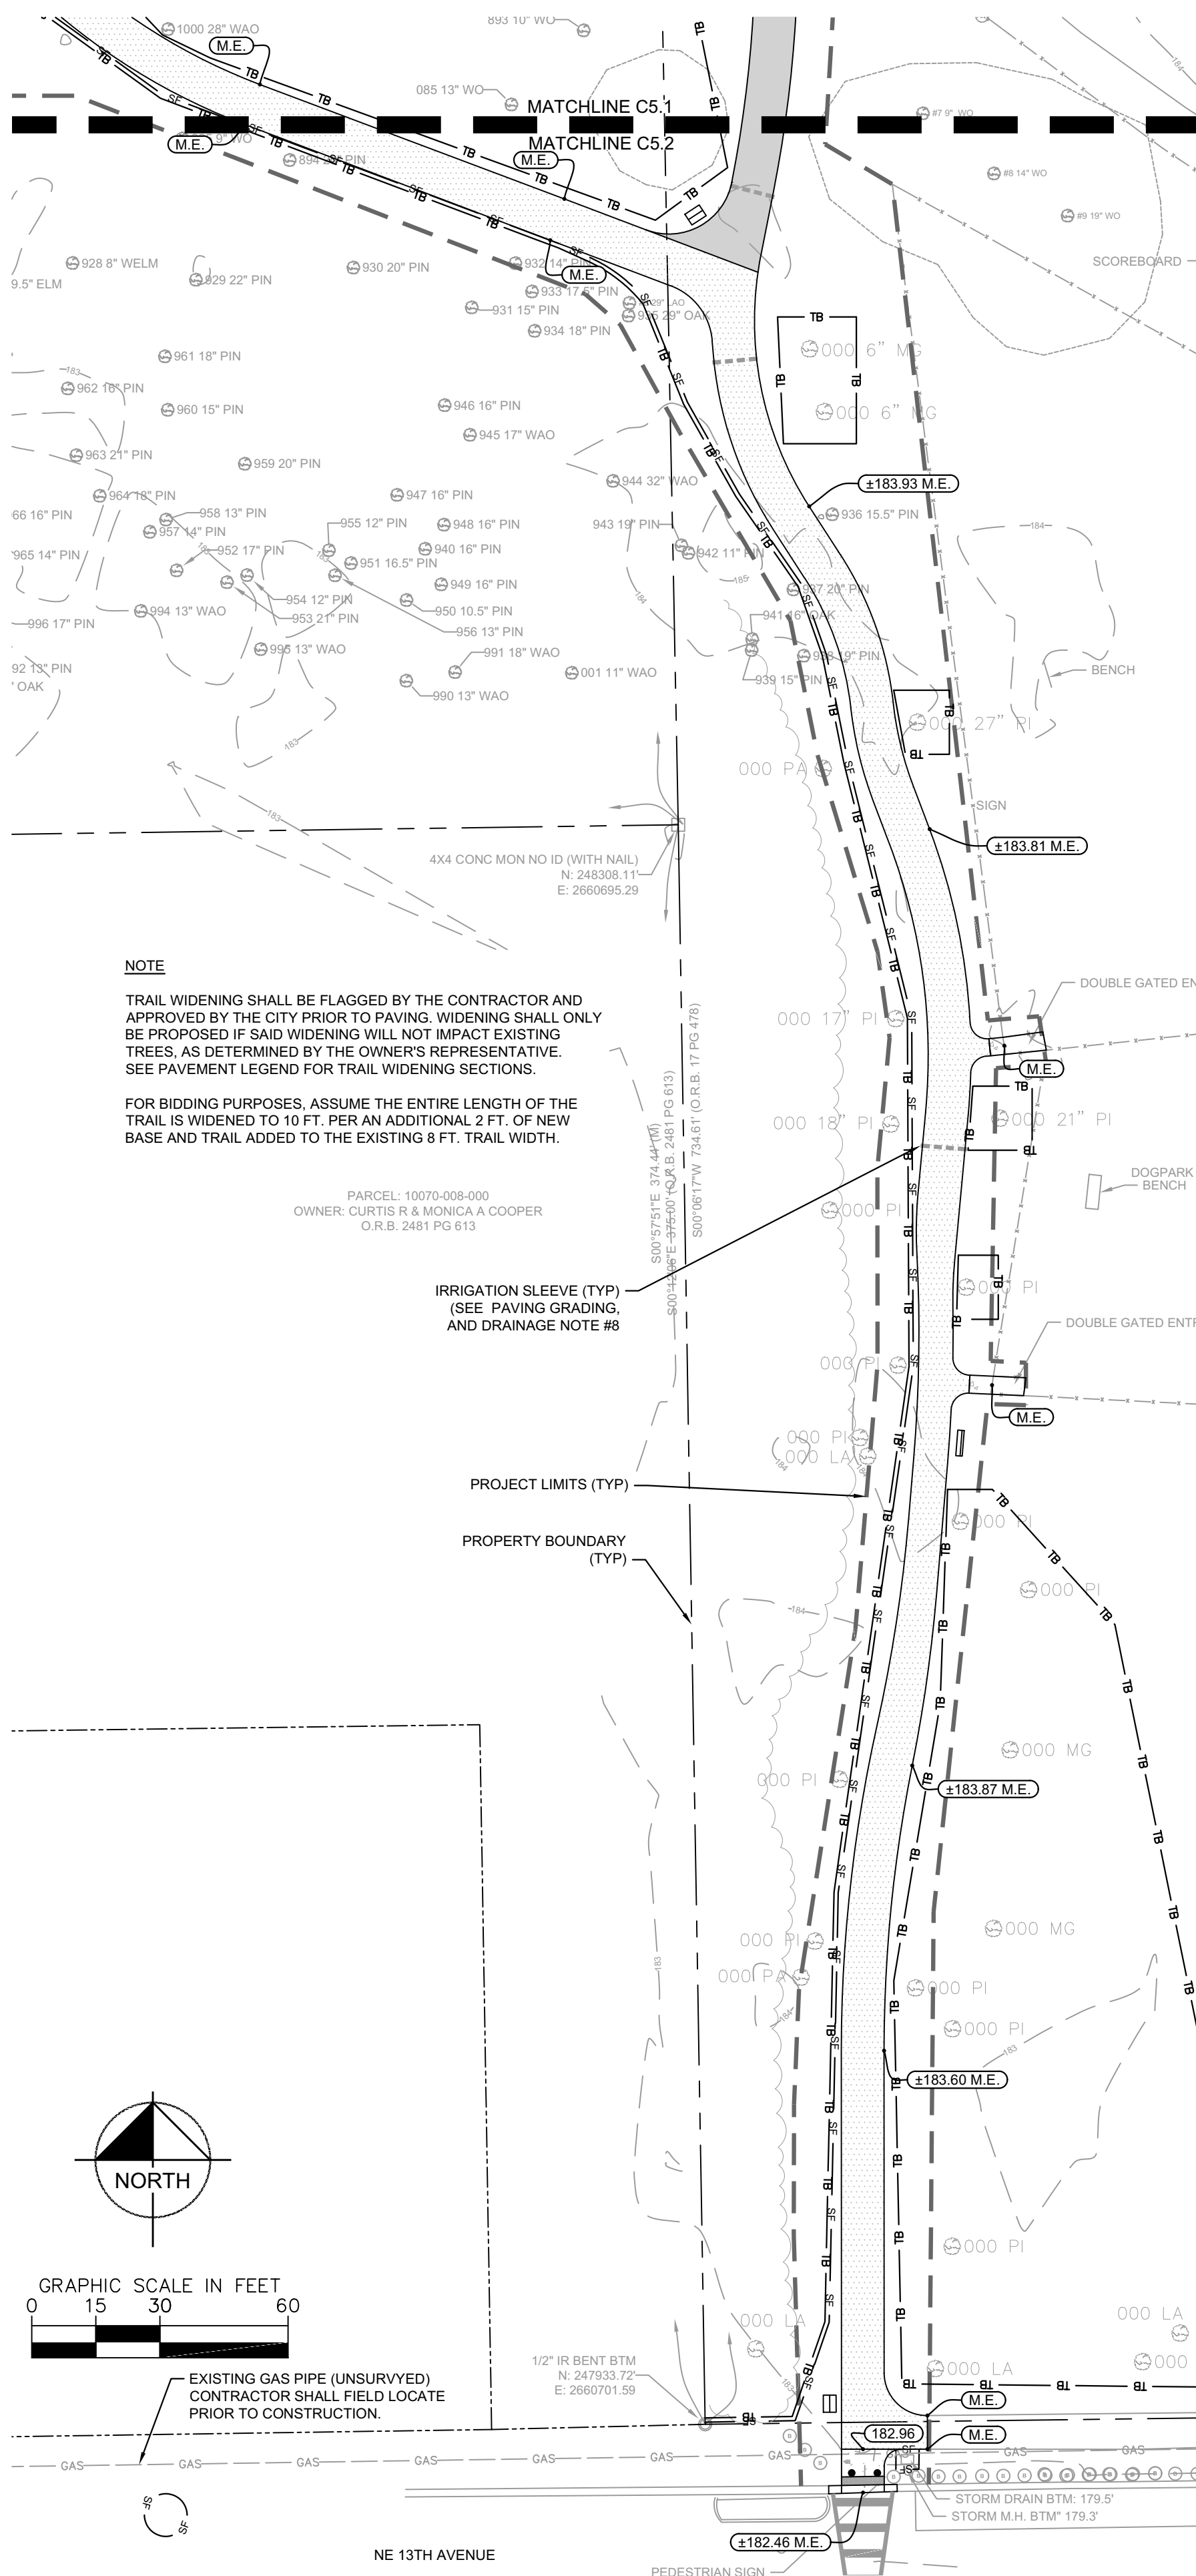


				-	
	DESIGN DEVELOPMENT SUBMITTAL	05-21-24	-		
	90% CONSTRUCTION DOCUMENTS	07-02-24	-		
	SITE DEVELOPMENT REVIEW	09-06-24	-		
	SITE DEVELOPMENT REVIEW	12-20-24	-		
	SITE DEVELOPMENT REVIEW &				
	BID ADDENDUM NO. 1				
	NOT FOR CONSTRUCTION	01-21-25	-		
No.	REVISIONS	DATE	BY		

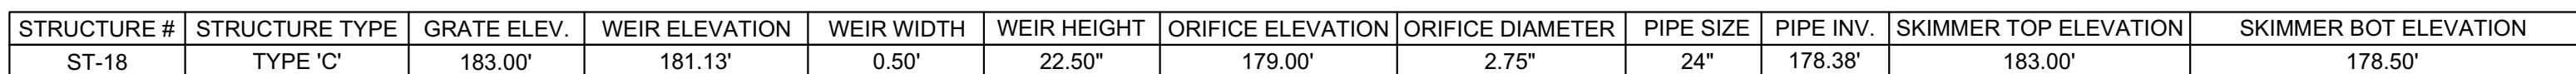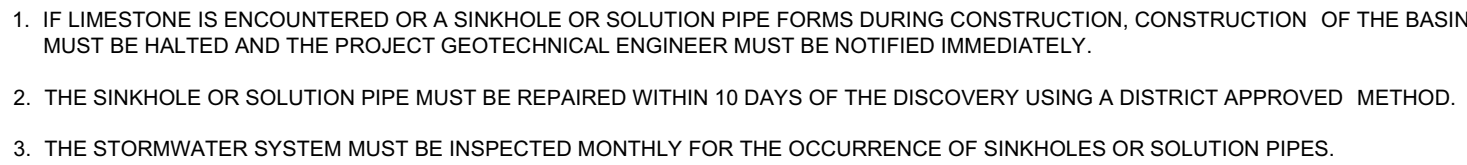

N.T.S.

K:\S01-LA\142107025 - Tom Petty Construction Docs\04-WORKING FILES\CAD\PlanSheets\C5.4 POND BORING SECTIONS.dwg, Layout:C5.4 POND BORING SECTIONS Jan 22, 2025 dclanymarkham  
PLOT: Addplot=142107025.ctb W=3600 H=3600 Plot Device=plotters-3600  
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POND TOP EL.: 183.50  
EXISTING GRADE = VARIES  
SHGWT PER GEOTECHNICAL REPORT = 180.50  
NWT = 179.00  
SHGWT & SLGWT AVERAGE ELEVATION: 178.25  
SLGWT PER GEOTECHNICAL REPORT = 176.00  
POND BOTTOM EL.: 171.00

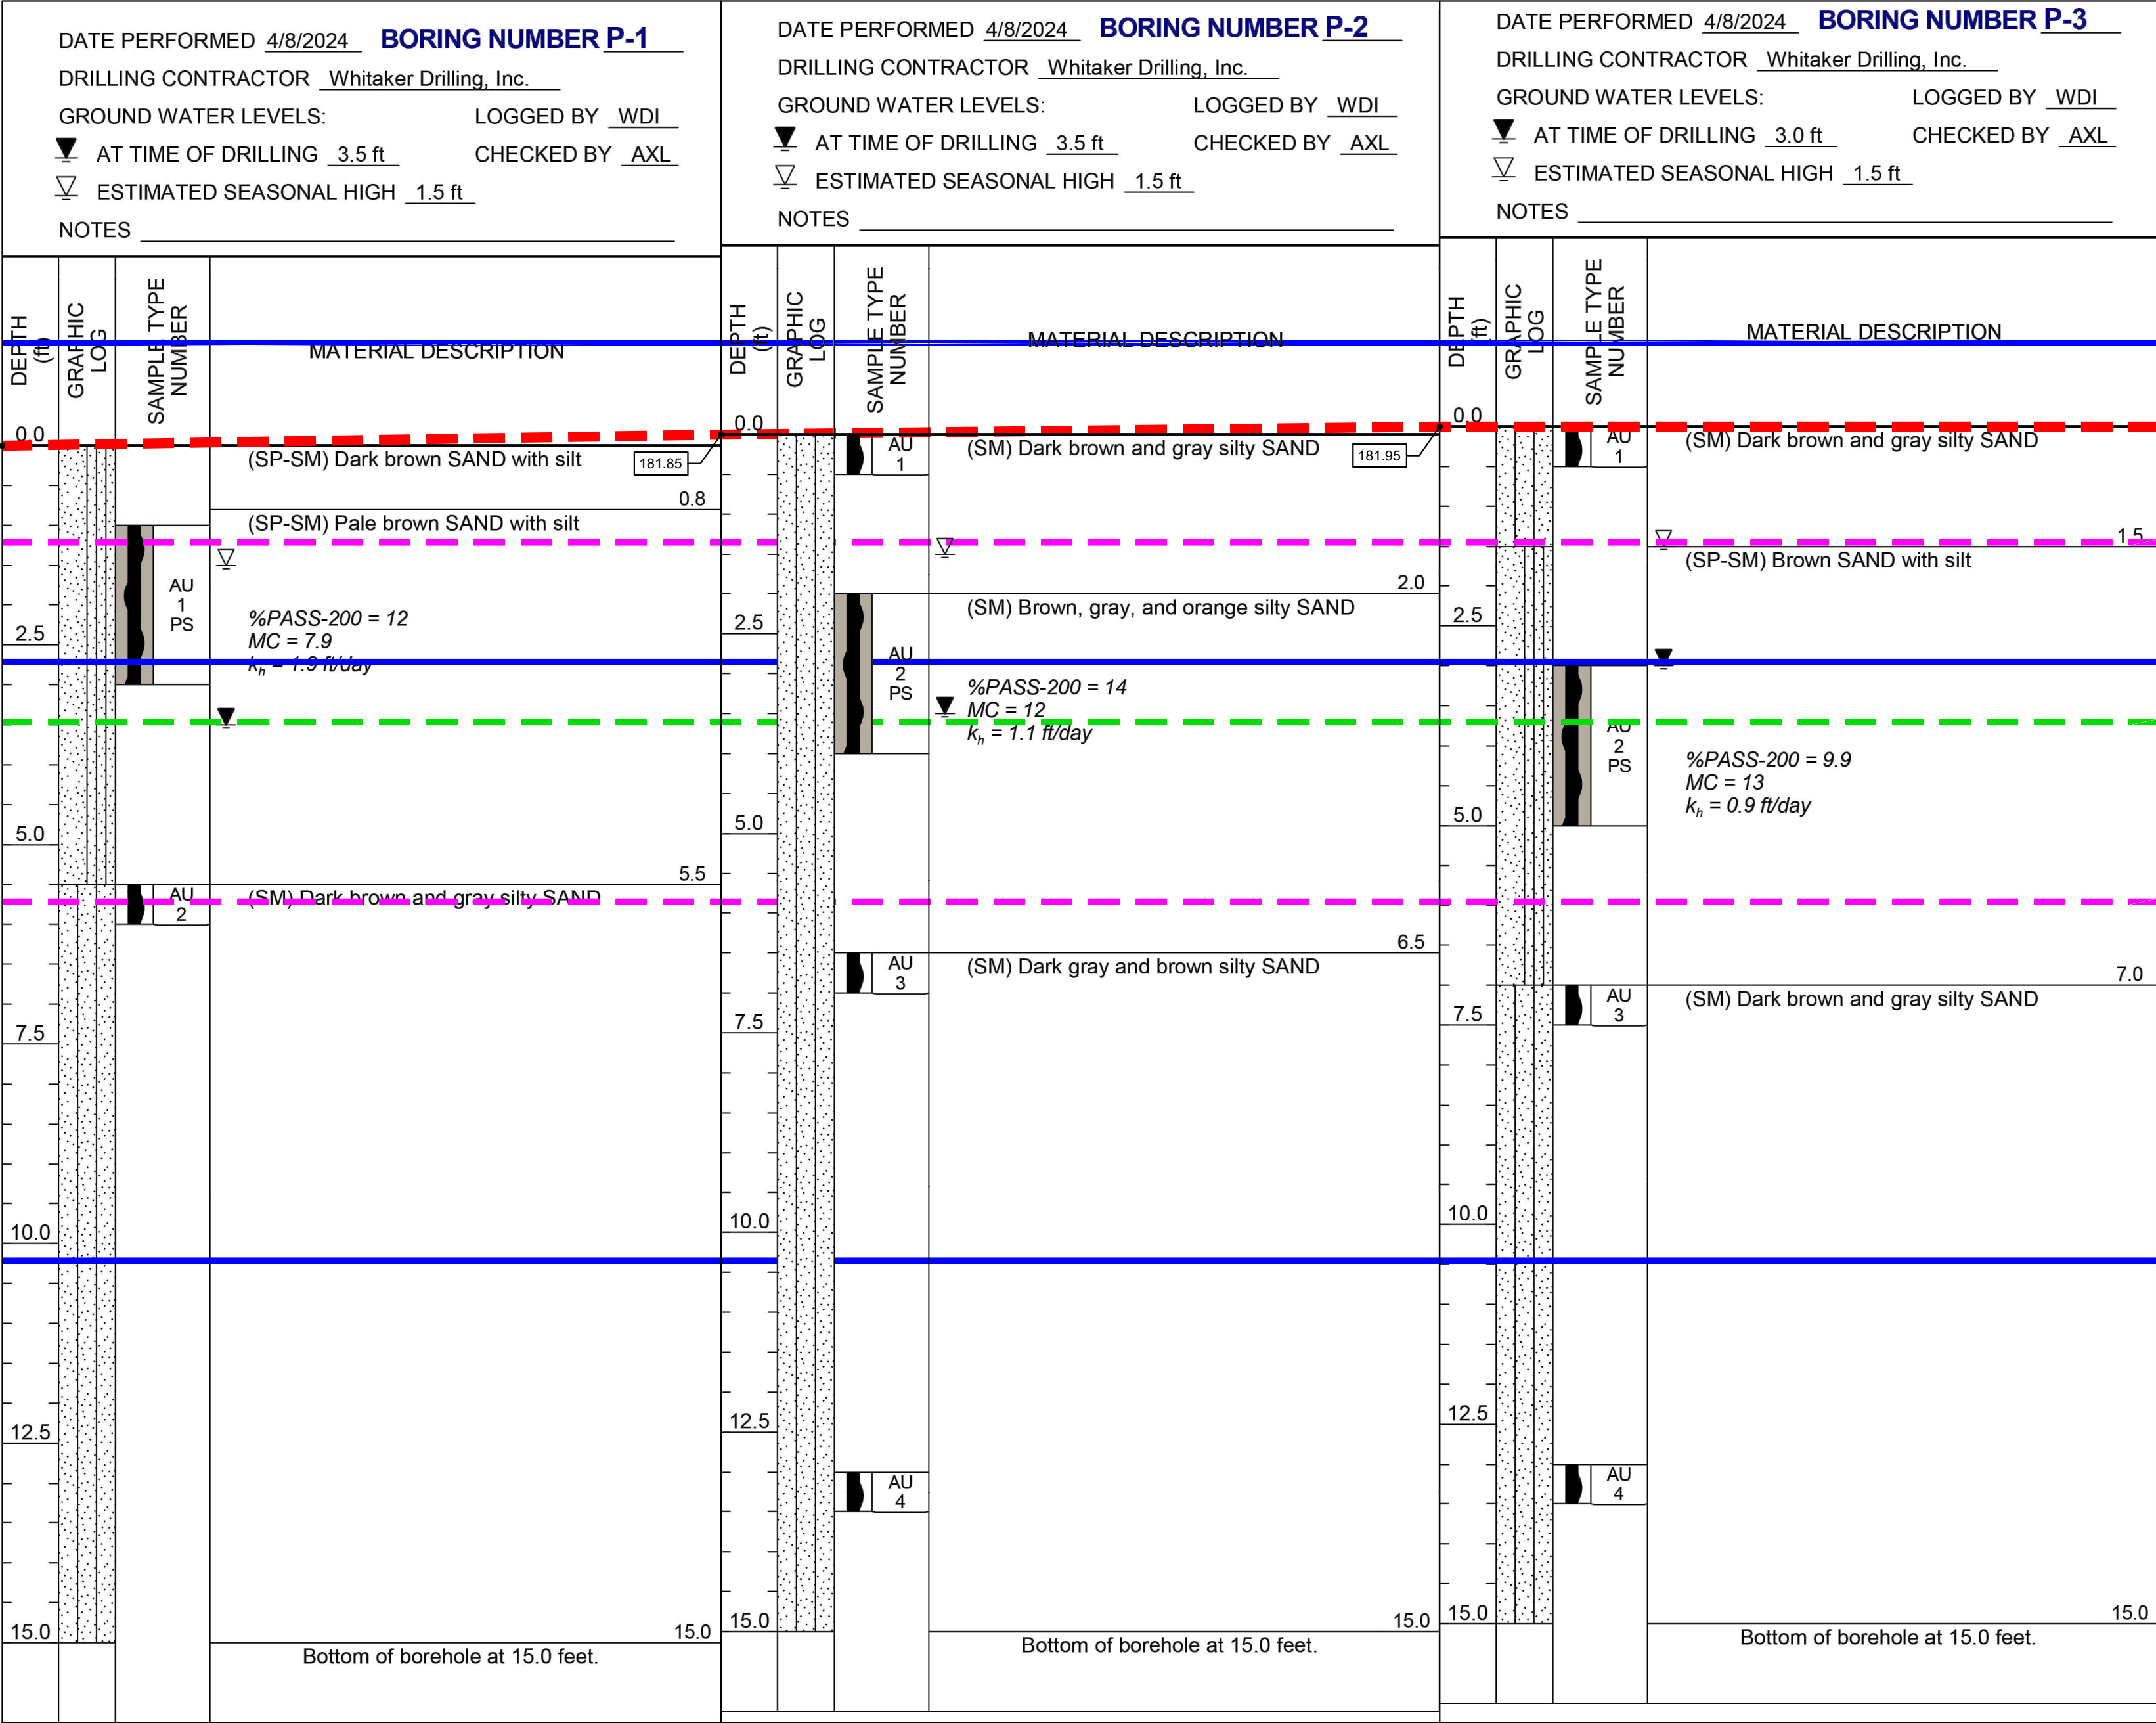DESIGN	DEVELOPMENT	SUBMITTAL	05-21-24	-
	90% CONSTRUCTION	DOCUMENTS	07-02-24	-
	SITE DEVELOPMENT	REVIEW	09-06-24	-
	SITE DEVELOPMENT	REVIEW	12-20-24	-
	SITE DEVELOPMENT	REVIEW &		
	BID ADDENDUM	NO. 1	01-21-25	-
	NOT FOR CONSTRUCTION		-	-
No.	REVISIONS		DATE	BY

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PHONE: 352-374-3274  
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2025.01.22 17:04:33-05:00  
DAVID C. SOWELL, P.E.  
STATE OF FLORIDA  
PROFESSIONAL ENGINEER  
LICENSE NO. 68831  
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SIGNED BY DAVID C. SOWELL  
ON THE DATE INDICATED  
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SIGNED AND THE SIGNATURE  
ON ANY FILE

KHA PROJECT  
142107025  
DATE  
JANUARY 2025  
SCALE  
AS SHOWN  
DESIGNED  
DRAWN  
CHECK

TOM PETTY PARK  
PICKLEBALL IMPROVEMENTS  
PREPARED FOR  
CITY OF GAINESVILLE  
WILD SPACES & PUBLIC PLACES  
FLORIDA  
SHEET NUMBER  
**C5.4**

**GAINESVILLE**  
REVIEWED FOR  
CODE COMPLIANCE  
SW25-000012 - SITE WORK  
Tom Petty Park (LD24-000087)  
02/28/25



	DESIGN DEVELOPMENT SUBMITTAL	05-21-24	-
	90% CONSTRUCTION DOCUMENTS	07-02-24	-
	SITE DEVELOPMENT REVIEW	09-06-24	-
	SITE DEVELOPMENT REVIEW	12-20-24	-
	SITE DEVELOPMENT REVIEW &		
	BID ADDENDUM NO. 1		-
	NOT FOR CONSTRUCTION	01-21-25	-
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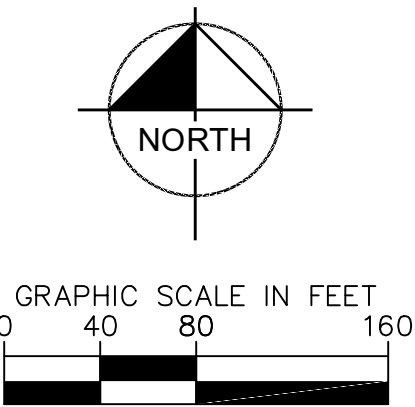
SW25-000012 - SITE WORK -  
Tom Petty Park (LD24-000087)

02/28/25

TOM PETTY PARK  
PICKLEBALL IMPROVEMENTS  
PREPARED FOR  
CITY OF GAINESVILLE  
WILD SPACES & PUBLIC PLACES  
GAINESVILLE, FLORIDA

SHEET NUMBER

## C6.0




1. CONTRACTOR SHALL CONTACT GRU GAS OPERATIONS SUPERVISOR WESLEY LESTER AT (352)-538-2570 AT LEAST SEVEN (7) DAYS PRIOR TO THE START OF DEMOLITION.
2. CONTRACTOR SHALL CONTACT GRU GAS OPERATIONS SUPERVISOR WESLEY LESTER AT (352)-538-2570 AT LEAST SEVEN (7) DAYS PRIOR TO THE START OF CONSTRUCTION.
3. CONTRACTOR SHALL CONTACT GRU GAS OPERATIONS SUPERVISOR WESLEY LESTER AT (352)-538-2570 AT LEAST THREE (3) DAYS PRIOR TO CASING INSTALLATIONS AND METER SETS.
4. CONTRACTOR SHALL LOCATE, PROTECT, AND MAINTAIN A MINIMUM OF 36" INCHES OF COVER OVER EXISTING GRU GAS MAIN AND GAS SERVICES DURING ALL PHASES OF DEMOLITION AND CONSTRUCTION.
5. CONTRACTOR SHALL MAINTAIN 12" ALL-CLEAR ZONE (HORIZONTAL AND VERTICAL) AROUND GAS MAINS AND SERVICES. MAINTAIN A MINIMUM DEPTH OF 3' FOR THE GAS MAIN AND ASSOCIATED CASINGS.

1. PRIOR TO INSTALLATION OF CONDUIT, CONTRACTOR SHALL CONTACT GRU INSPECTOR, EUGENE GREEN, (352) 339-0340.
2. ELECTRIC DESIGN PROVIDED BY GRU ENERGY DELIVERY.
3. CONTACT PETE JONES, METERING, (352) 393-1592 WITH METER SOCKET/BYPASS MODEL # TO VERIFY REQUIREMENTS.

1. W/WWW/RCW SYSTEM DESIGN IS IN ACCORDANCE WITH GRU DESIGN AND MATERIAL STANDARDS.
2. GRU TO OWN AND MAINTAIN SEWER MAINS AND MANHOLES ONLY. ALL END OF MAINTENANCE IS EITHER AT THE MANHOLE OR SEWER LATERAL WYE AT THE MAIN.

ELECTRIC DESIGN PROVIDED  
BY GRU ENERGY DELIVERY

K:\SOL\_LA\142107025 - Tom Petty Construction\Doc\G4\_WORKING FILES\G4\PlanSheets\G4\G4.0 UTILITY PLANS.dwg, Layer: C6.1 UTILITY PLAN, Jan 22, 2025, ddesney.mcham  
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**LANDSCAPE NOTES:**

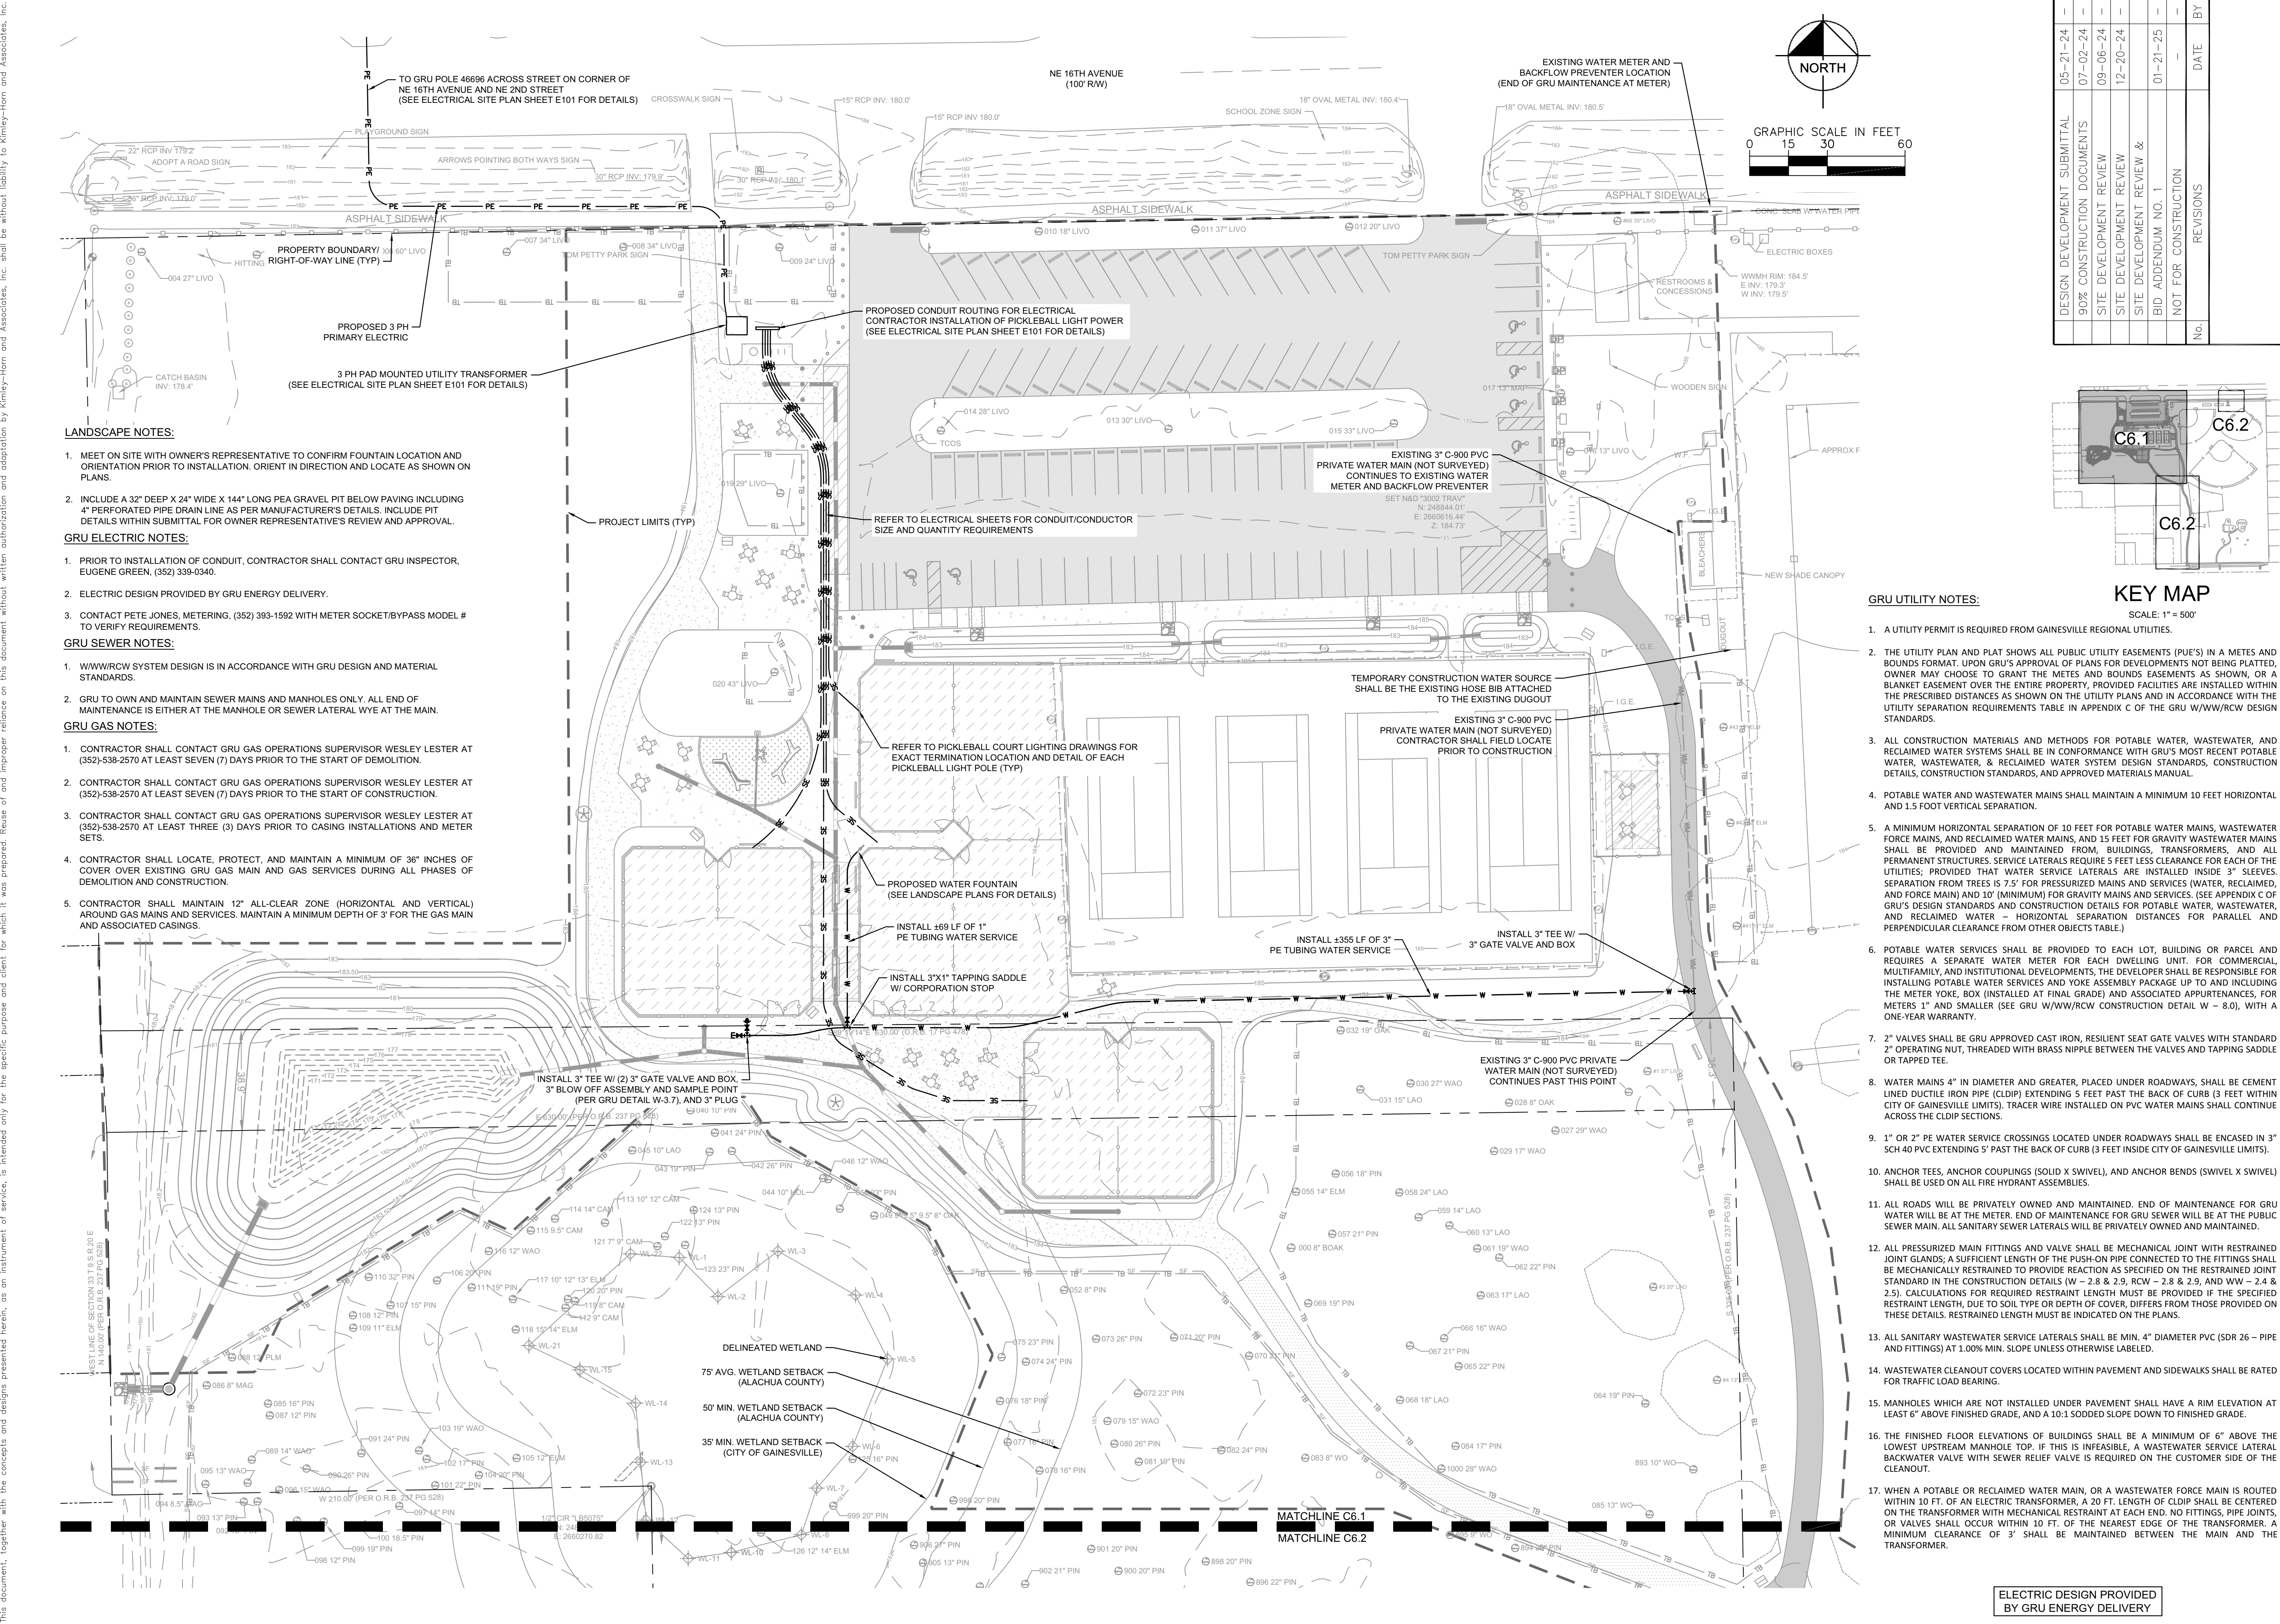1. MEET ON SITE WITH OWNER'S REPRESENTATIVE TO CONFIRM FOUNTAIN LOCATION AND ORIENTATION PRIOR TO INSTALLATION. ORIENT IN DIRECTION AND LOCATE AS SHOWN ON PLANS.
2. INCLUDE A 32" DEEP X 24" WIDE X 144" LONG PEA GRAVEL PIT BELOW PAVING INCLUDING 4" PERFORATED PIPE DRAIN LINE AS PER MANUFACTURER'S DETAILS. INCLUDE PIT DETAILS WITHIN SUBMITTAL FOR OWNER REPRESENTATIVE'S REVIEW AND APPROVAL.

**GRU ELECTRIC NOTES:**

1. PRIOR TO INSTALLATION OF CONDUIT, CONTRACTOR SHALL CONTACT GRU INSPECTOR, EUGENE GREEN, (352) 339-0340.
2. ELECTRIC DESIGN PROVIDED BY GRU ENERGY DELIVERY.
3. CONTACT PETE JONES, METERING, (352) 393-1592 WITH METER SOCKET/BYPASS MODEL # TO VERIFY REQUIREMENTS.

**GRU SEWER NOTES:**

1. WWWWRCW SYSTEM DESIGN IS IN ACCORDANCE WITH GRU DESIGN AND MATERIAL STANDARDS.
2. GRU TO OWN AND MAINTAIN SEWER MAINS AND MANHOLES ONLY. ALL END OF MAINTENANCE IS EITHER AT THE MANHOLE OR SEWER LATERAL WYE AT THE MAIN.

**GRU GAS NOTES:**

1. CONTRACTOR SHALL CONTACT GRU GAS OPERATIONS SUPERVISOR WESLEY LESTER AT (352)-538-2570 AT LEAST SEVEN (7) DAYS PRIOR TO THE START OF DEMOLITION.
2. CONTRACTOR SHALL CONTACT GRU GAS OPERATIONS SUPERVISOR WESLEY LESTER AT (352)-538-2570 AT LEAST SEVEN (7) DAYS PRIOR TO THE START OF CONSTRUCTION.
3. CONTRACTOR SHALL CONTACT GRU GAS OPERATIONS SUPERVISOR WESLEY LESTER AT (352)-538-2570 AT LEAST THREE (3) DAYS PRIOR TO CASING INSTALLATIONS AND METER SETS.
4. CONTRACTOR SHALL LOCATE, PROTECT, AND MAINTAIN A MINIMUM OF 36" INCHES OF COVER OVER EXISTING GRU GAS MAIN AND GAS SERVICES DURING ALL PHASES OF DEMOLITION AND CONSTRUCTION.
5. CONTRACTOR SHALL MAINTAIN 12" ALL-CLEAR ZONE (HORIZONTAL AND VERTICAL) AROUND GAS MAINS AND SERVICES. MAINTAIN A MINIMUM DEPTH OF 3' FOR THE GAS MAIN AND ASSOCIATED CASINGS.

**GRU UTILITY NOTES:**

1. A UTILITY PERMIT IS REQUIRED FROM GAINESVILLE REGIONAL UTILITIES.
2. THE UTILITY PLAN AND PLAT SHOWS ALL PUBLIC UTILITY EASEMENTS (PUE'S) IN A METES AND BOUNDS FORMAT. UPON GRU'S APPROVAL OF PLANS FOR DEVELOPMENTS NOT BEING PLATTED, OWNER MAY CHOOSE TO GRANT THE METES AND BOUNDS EASEMENTS AS SHOWN, OR A BLANKET EASEMENT OVER THE ENTIRE PROPERTY, PROVIDED FACILITIES ARE INSTALLED WITHIN THE PRESCRIBED DISTANCES AS SHOWN ON THE UTILITY PLANS AND IN ACCORDANCE WITH THE UTILITY SEPARATION REQUIREMENTS TABLE IN APPENDIX C OF THE GRU WWWWRCW DESIGN STANDARDS.
3. ALL CONSTRUCTION MATERIALS AND METHODS FOR POTABLE WATER, WASTEWATER, AND RECLAIMED WATER SYSTEMS SHALL BE IN CONFORMANCE WITH GRU'S MOST RECENT POTABLE WATER, WASTEWATER, & RECLAIMED WATER SYSTEM DESIGN STANDARDS, CONSTRUCTION DETAILS, CONSTRUCTION STANDARDS, AND APPROVED MATERIALS MANUAL.
4. POTABLE WATER AND WASTEWATER MAINS SHALL MAINTAIN A MINIMUM 10 FEET HORIZONTAL AND 1.5 FOOT VERTICAL SEPARATION.
5. A MINIMUM HORIZONTAL SEPARATION OF 10 FEET FOR POTABLE WATER MAINS, WASTEWATER FORCE MAINS, AND RECLAIMED WATER MAINS, AND 15 FEET FOR GRAVITY WASTEWATER MAINS SHALL BE PROVIDED AND MAINTAINED FROM, BUILDINGS, TRANSFORMERS, AND ALL PERMANENT STRUCTURES. SERVICE LATERALS REQUIRE 5 FEET LESS CLEARANCE FOR EACH OF THE UTILITIES. PROVIDED THAT WATER SERVICE LATERALS ARE INSTALLED INSIDE 3" SLEEVES. SEPARATION FROM TREES IS 7.5' FOR PRESSURIZED MAINS AND SERVICES (WATER, RECLAIMED, AND FORCE MAIN) AND 10' (MINIMUM) FOR GRAVITY MAINS AND SERVICES. (SEE APPENDIX C OF GRU'S DESIGN STANDARDS AND CONSTRUCTION DETAILS FOR POTABLE WATER, WASTEWATER, AND RECLAIMED WATER - HORIZONTAL SEPARATION DISTANCES FOR PARALLEL AND PERPENDICULAR CLEARANCE FROM OTHER OBJECTS TABLE.)
6. POTABLE WATER SERVICES SHALL BE PROVIDED TO EACH LOT, BUILDING OR PARCEL AND REQUIRES A SEPARATE WATER METER FOR EACH DWELLING UNIT. FOR COMMERCIAL, MULTIFAMILY, AND INSTITUTIONAL DEVELOPMENTS, THE DEVELOPER SHALL BE RESPONSIBLE FOR INSTALLING POTABLE WATER SERVICES AND YOKE ASSEMBLY PACKAGE UP TO AND INCLUDING THE METER YOKE, BOX (INSTALLED AT FINAL GRADE) AND ASSOCIATED APPURTENANCES, FOR METERS 1" AND SMALLER (SEE GRU WWWWRCW CONSTRUCTION DETAIL W - 8.0), WITH A ONE-YEAR WARRANTY.
7. 2" VALVES SHALL BE GRU APPROVED CAST IRON, RESILIENT SEAT GATE VALVES WITH STANDARD 2" OPERATING NUT, THREADED WITH BRASS NIPPLE BETWEEN THE VALVES AND TAPPING SADDLE OR TAPPED TEE.
8. WATER MAINS 4" IN DIAMETER AND GREATER, PLACED UNDER ROADWAYS, SHALL BE CEMENT LINED DUCTILE IRON PIPE (CLDIP) EXTENDING 5 FEET PAST THE BACK OF CURB (3 FEET WITHIN CITY OF GAINESVILLE LIMITS). TRACER WIRE INSTALLED ON PVC WATER MAINS SHALL CONTINUE ACROSS THE CLDIP SECTIONS.
9. 1" OR 2" PE WATER SERVICE CROSSINGS LOCATED UNDER ROADWAYS SHALL BE ENCASED IN 3" SCH 40 PVC EXTENDING 5' PAST THE BACK OF CURB (3 FEET INSIDE CITY OF GAINESVILLE LIMITS).
10. ANCHOR TEES, ANCHOR COUPLINGS (SOLID X SWIVEL), AND ANCHOR BENDS (SWIVEL X SWIVEL) SHALL BE USED ON ALL FIRE HYDRANT ASSEMBLIES.
11. ALL ROADS WILL BE PRIVATELY OWNED AND MAINTAINED. END OF MAINTENANCE FOR GRU WATER WILL BE AT THE METER. END OF MAINTENANCE FOR GRU SEWER WILL BE AT THE PUBLIC SEWER MAIN. ALL SANITARY SEWER LATERALS WILL BE PRIVATELY OWNED AND MAINTAINED.
12. ALL PRESSURIZED MAIN FITTINGS AND VALVE SHALL BE MECHANICAL JOINT WITH RESTRAINED JOINT GLANDS; A SUFFICIENT LENGTH OF THE PUSH-ON PIPE CONNECTED TO THE FITTINGS SHALL BE MECHANICALLY RESTRAINED TO PROVIDE REACTION AS SPECIFIED ON THE RESTRAINED JOINT STANDARD IN THE CONSTRUCTION DETAILS (W - 2.8 & 2.9, RCW - 2.8 & 2.9, AND WW - 2.4 & 2.5). CALCULATIONS FOR REQUIRED RESTRAINT LENGTH MUST BE PROVIDED IF THE SPECIFIED RESTRAINT LENGTH, DUE TO SOIL TYPE OR DEPTH OF COVER, DIFFERS FROM THOSE PROVIDED ON THESE DETAILS. RESTRAINED LENGTH MUST BE INDICATED ON THE PLANS.
13. ALL SANITARY WASTEWATER SERVICE LATERALS SHALL BE MIN. 4" DIAMETER PVC (SDR 26 - PIPE AND FITTINGS) AT 1.00% MIN. SLOPE UNLESS OTHERWISE LABELED.
14. WASTEWATER CLEANOUT COVERS LOCATED WITHIN PAVEMENT AND SIDEWALKS SHALL BE RATED FOR TRAFFIC LOAD BEARING.
15. MANHOLES WHICH ARE NOT INSTALLED UNDER PAVEMENT SHALL HAVE A RIM ELEVATION AT LEAST 6" ABOVE FINISHED GRADE, AND A 10:1 SLOTTED SLOPE DOWN TO FINISHED GRADE.
16. THE FINISHED FLOOR ELEVATIONS OF BUILDINGS SHALL BE A MINIMUM OF 6" ABOVE THE LOWEST UPSTREAM MANHOLE TOP. IF THIS IS INFEASIBLE, A WASTEWATER SERVICE LATERAL BACKWATER VALVE WITH SEWER RELIEF VALVE IS REQUIRED ON THE CUSTOMER SIDE OF THE CLEANOUT.
17. WHEN A POTABLE OR RECLAIMED WATER MAIN, OR A WASTEWATER FORCE MAIN IS ROUTED WITHIN 10 FT. OF AN ELECTRIC TRANSFORMER, A 20 FT. LENGTH OF CLDIP SHALL BE CENTERED ON THE TRANSFORMER WITH MECHANICAL RESTRAINT AT EACH END. NO FITTINGS, PIPE JOINTS, OR VALVES SHALL OCCUR WITHIN 10 FT. OF THE NEAREST EDGE OF THE TRANSFORMER. A MINIMUM CLEARANCE OF 3' SHALL BE MAINTAINED BETWEEN THE MAIN AND THE TRANSFORMER.

ELECTRIC DESIGN PROVIDED  
BY GRU ENERGY DELIVERY



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2025.01.22 17:04:55:00  
DAVID C. SOWELL, P.E.  
STATE OF FLORIDA  
PROFESSIONAL ENGINEER  
LICENSE NO. 66831



KHA PROJECT  
142107025  
DATE  
JANUARY 2025  
SCALE  
AS SHOWN  
DESIGNED  
DRAWN  
CHECK

**UTILITY PLAN**

TOM PETTY PARK  
PICKLEBALL IMPROVEMENTS  
PREPARED FOR  
CITY OF GAINESVILLE  
WILD SPACES & PUBLIC PLACES  
FLORIDA  
GAINESVILLE

SHEET NUMBER  
**C6.1**



	DESIGN DEVELOPMENT SUBMITTAL	05-21-24	-
	90% CONSTRUCTION DOCUMENTS	07-02-24	-
	SITE DEVELOPMENT REVIEW	09-06-24	-
	SITE DEVELOPMENT REVIEW &	12-20-24	-
	BID ADDENDUM NO. 1	01-21-25	-
	NOT FOR CONSTRUCTION	-	-
No.	REVISIONS	DATE	BY

NOTE:

1. SEE SITE PLAN FOR SPECIFIC SIDEWALK LOCATIONS. SIDEWALK SHALL BE CONSTRUCTED PER PDOT INDEX NO. 522-001.
2. WALKS TO BE LIGHT BROOM-SWEEP FINISH, DIRECTION PERPENDICULAR TO WALK.
3. CONTROL JOINTS TO BE SAW CUT AND TO DEPTH AS SHOWN.
4. EXPANSION JOINTS AT TO BE  $\frac{1}{2}$ " FULL DEPTH AND TO BE LOCATED AT INTERFACES WITH EXISTING PAVING, COLUMNS OR WALLS AND AS SHOWN IN PLANS.
5. WALK DIRECTIONAL SLOPE TO NOT EXCEED 5% WALK CROSS-SLOPE TO NOT EXCEED 2%.
6. CONTROL JOINTS TO BE SPACED ON CENTER TO MATCH THE WALK WIDTH.
7. EXPANSION JOINTS TO BE NO MORE THAN 30° ON CENTER.
8. JOINTS TO NOT CREATE ACUTE ANGLES AND SHALL INTERSECT WITH PAVING PERIMETERS AT 90 DEGREES.

TYPICAL.

9. SUBMIT A SHOP DRAWING OF PROPOSED JOINTING FOR REVIEW AND APPROVAL PRIOR TO CUTTING.

- NOTE: 1. SEE SITE PLAN FOR SPECIFIC SIDEWALK LOCATIONS  
SIDEWALK SHALL BE CONSTRUCTED PER FDOT INDEX NO. 522-001
2. WALKS TO BE LIGHT BROOM-SWEEP FINISH, DIRECTION PERPENDICULAR TO WALK.
3. CONTROL JOINTS TO BE SAW CUT AND TO DEPTH AS SHOWN
4. EXPANSION JOINTS AT TO BE  $\frac{1}{2}$  FULL DEPTH AND TO BE LOCATED AT INTERFACES WITH EXISTING PAVING, COLUMNS OR WALLS AND AS SHOWN IN PLANS.
5. WALK DIRECTIONAL SLOPE TO NOT EXCEED 5%. WALK CROSS-SLOPE TO NOT EXCEED 2%.
6. CONTROL JOINTS TO BE SPACED ON CENTER TO MATCH THE WALK WIDTH.
7. TRANSITION JOINTS TO BE NO MORE THAN 36" ON CENTER
8. JOINTS SHALL NOT CREATE ACUTE ANGLES AND SHALL INTERSECT WITH PAVING PERIMETERS AT 90 DEGREES, TYPICAL
9. SUBMIT A SHOP DRAWING OF PROPOSED JOINTING FOR REVIEW AND APPROVAL PRIOR TO CUTTING.

N.T.S.

NOTES:

1. WHEN HEADER CURB IS USED IN LIEU OF WHEEL STOPS, SIDEWALK ABUTTING CURB MUST BE WIDENED BY 18" SO THAT THE TOTAL SIDEWALK WIDTH IS 62", ALLOWING FOR 44" MINIMUM CLEAR ACCESSIBLE ROUTE.
2. FOR COMPLETE DETAIL OF HANDICAPPED SIGN, REFER TO HANDICAP SIGN DETAIL.
3. NO RAMPS ARE REQUIRED WHEN SIDEWALK IS FLUSH WITH PAVEMENT. SEE GRADING PLAN.
4. ALL PARKING STRIPES SHALL BE 6" IN WIDTH.
5. SEE F.D.O.T. INDEX 711-001 FOR THE MOST CURRENT DETAIL.
6. MUST COMPLY WITH ADA REQUIREMENTS.

N.T.S.

ACCESSIBLE PARKING SPACES  
AND ACCESS AISLES SHALL BE  
LEVEL WITH SURFACE SLOPES  
NOT EXCEEDING 1:50 (2%) IN  
ALL DIRECTIONS

N.T.S

N.T.S



N.T.S.

## PGKH24A.DWG

NOTE:

CONTRACTOR SHALL REMOVE ALL UNSUITABLE MATERIAL  
SUCH AS CLAY AND ROOTS PER AGENCY REQUIREMENTS

N.T.S.

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2025.01.22 17:04:56-0500  
DAVID C. SOWELL, P.E.  
STATE OF FLORIDA,  
PROFESSIONAL ENGINEER,  
LICENSE NO. 68531

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SW25-000012 - SITE WORK -  
Tom Petty Park (LD24-000087)

02/28/25

## CONSTRUCTION DETAILS

TOM PETTY PARK  
PICKLEBALL IMPROVEMENTS  
PREPARED FOR  
CITY OF GAINESVILLE  
WILD SPACES & PUBLIC PLACES

SHEET NUMBER  
**C7.0**

No.	REVISIONS	DATE	BY
	NOT FOR CONSTRUCTION	01-22-25	-
	BID ADDENDUM NO. 1		
	SITE DEVELOPMENT REVIEW &	12-20-24	-
	SITE DEVELOPMENT REVIEW	09-06-24	-
	90% CONSTRUCTION DOCUMENTS	07-02-24	-
	DESIGN DEVELOPMENT SUBMITTAL	05-21-24	-

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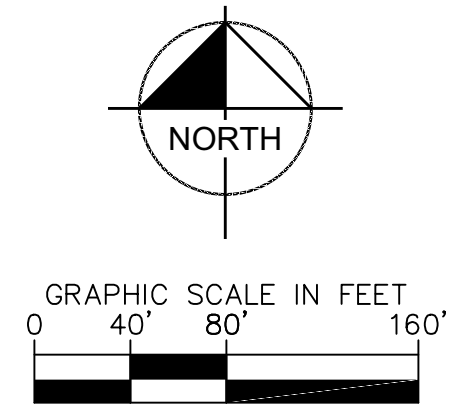
SW25-000012 - SITE WORK -  
Tom Petty Park (LD24-000087)

02/28/25

# OVERALL HARDSCAPE PLAN AND NOTES

GAINESVILLE  
FLORIDA

SHEET NUMBER  
**L1.00**



K:\CWL\_LA\142107025 - Tom Petty Construction Docs\04\_WORKING FILES\CAD\PlanSheets\142107025 TPP\_HP.dwg, Layout:L1.00 Jan 21, 2025 Maceo.Abreu  
REFS: vBorder=142107025, h=address=cd DownloadInfo xSurvey=142107025, yBase=142107025, yPoles=142107025, yUtilities=142107025, yWaters=142107025, yWells=142107025

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No.	REVISIONS	DATE	BY
	DESIGN DEVELOPMENT SUBMITTAL	05-21-24	
	90% CONSTRUCTION DOCUMENTS	07-02-24	
	SITE DEVELOPMENT REVIEW	09-06-24	
	SITE DEVELOPMENT REVIEW	12-20-24	
	SITE DEVELOPMENT REVIEW &		
	BID ADDENDUM NO. 1	01-22-25	
	NOT FOR CONSTRUCTION		
		-	

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# GAINEVILLE

## REVIEWED FOR CODE COMPLIANCE

SW25-000012 - SITE WORK -  
Tom Petty Park (LD24-000087)

02/28/25

KHA PROJECT  
142107025

DATE  
JANUARY 2025

SCALE AS SHOWN

DESIGNED BY  
DRAWN BY  
CHECKED BY

SW25-000012  
Tom Petty Park


02/28/2025

## HARDSCAPE PLAN

TOM PETTY PARK  
PICKLEBALL IMPROVEMENTS  
PREPARED FOR  
CITY OF GAINESVILLE  
WILD SPACES & PUBLIC PLACES

GAINESVILLE  
FLORIDA

SHEET NUMBER  
**L1.01**

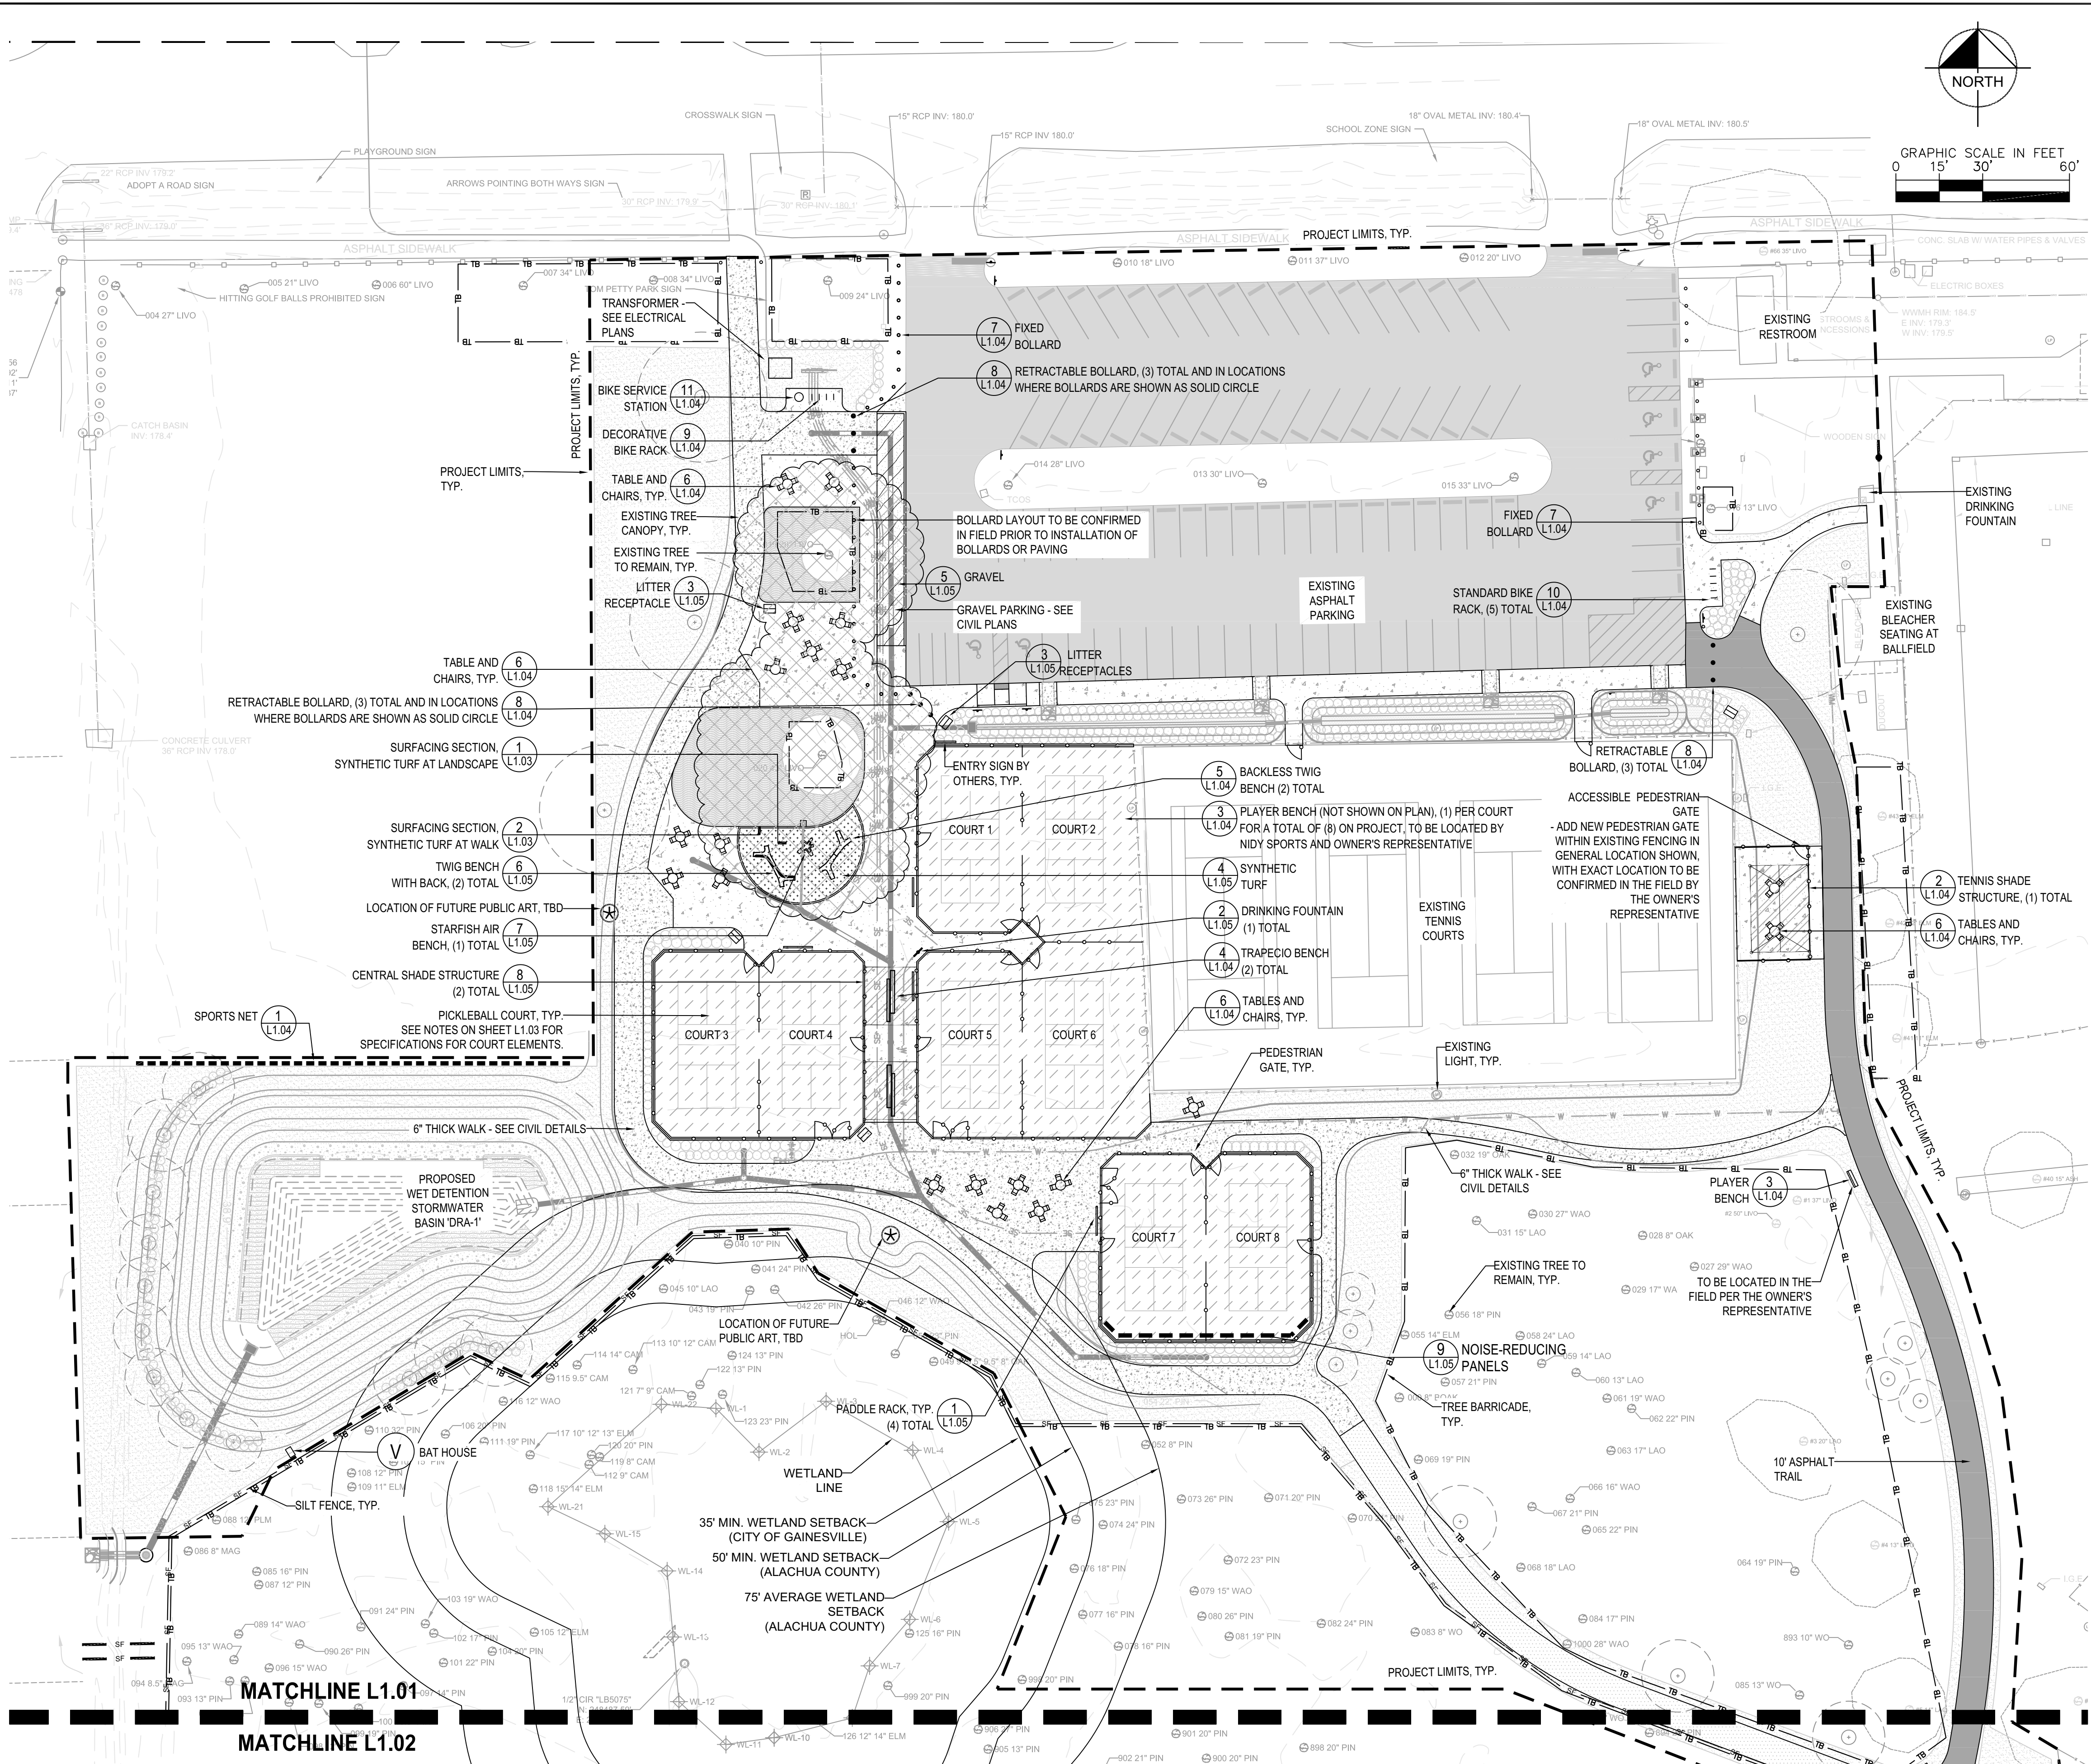

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No.	REVISIONS	DATE	BY
	NOT FOR CONSTRUCTION	01-22-25	-
	BID ADDENDUM NO. 1		
	SITE DEVELOPMENT REVIEW &	12-20-24	-
	SITE DEVELOPMENT REVIEW	09-06-24	-
	90% CONSTRUCTION DOCUMENTS	07-02-24	-
	DESIGN DEVELOPMENT SUBMITTAL	05-21-24	-

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PHONE: 352-374-3274  
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SW25-000012 - SITE WORK -  
Tom Petty Park (LD24-000087)

02/28/25

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JANUARY 2025

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## HARDSCAPE PLAN

TOM PETTY PARK





## PICKLEBALL IMPROVEMENTS

PREPARED FOR  
CITY OF GAINESVILLE

## WILD SPACES & PUBLIC PLACES

GAINESVILLE  
FLORIDA

SHEET NUMBER  
**L1.02**

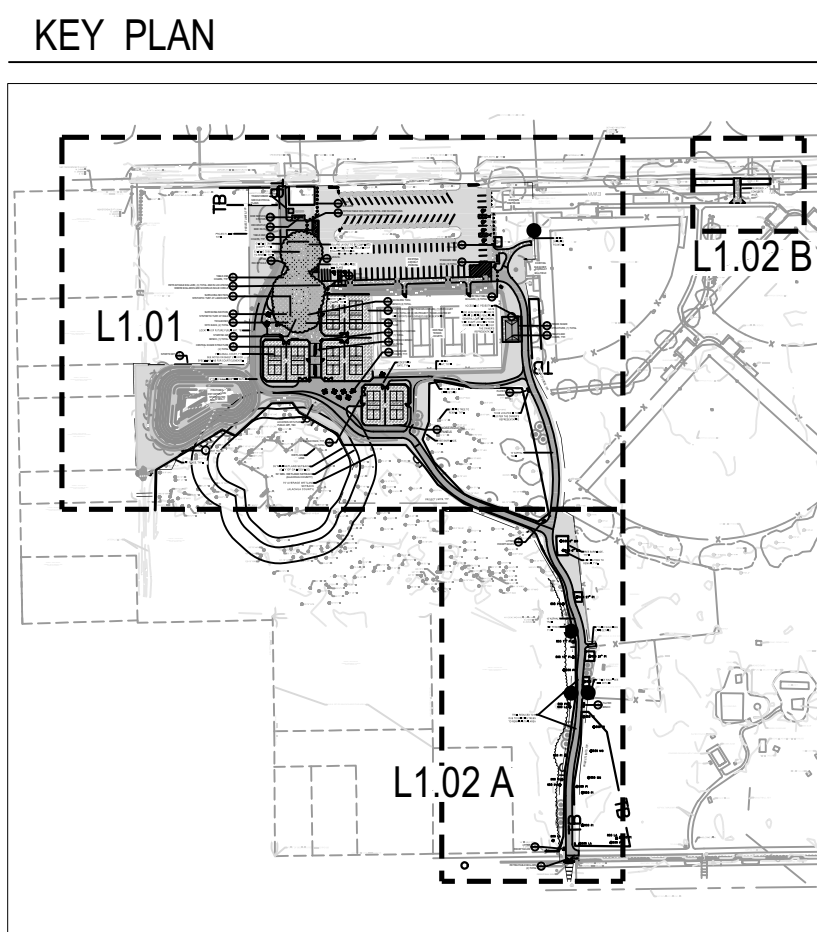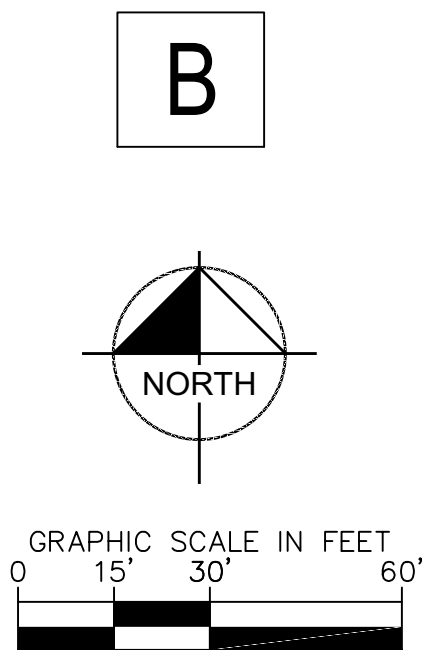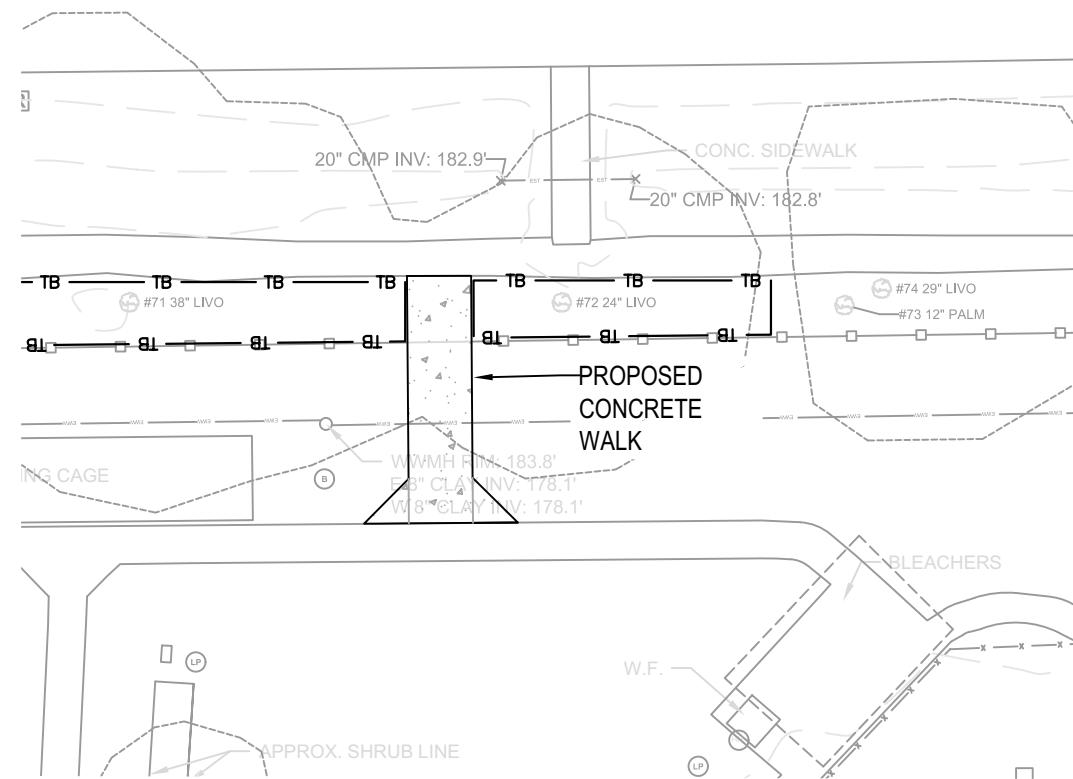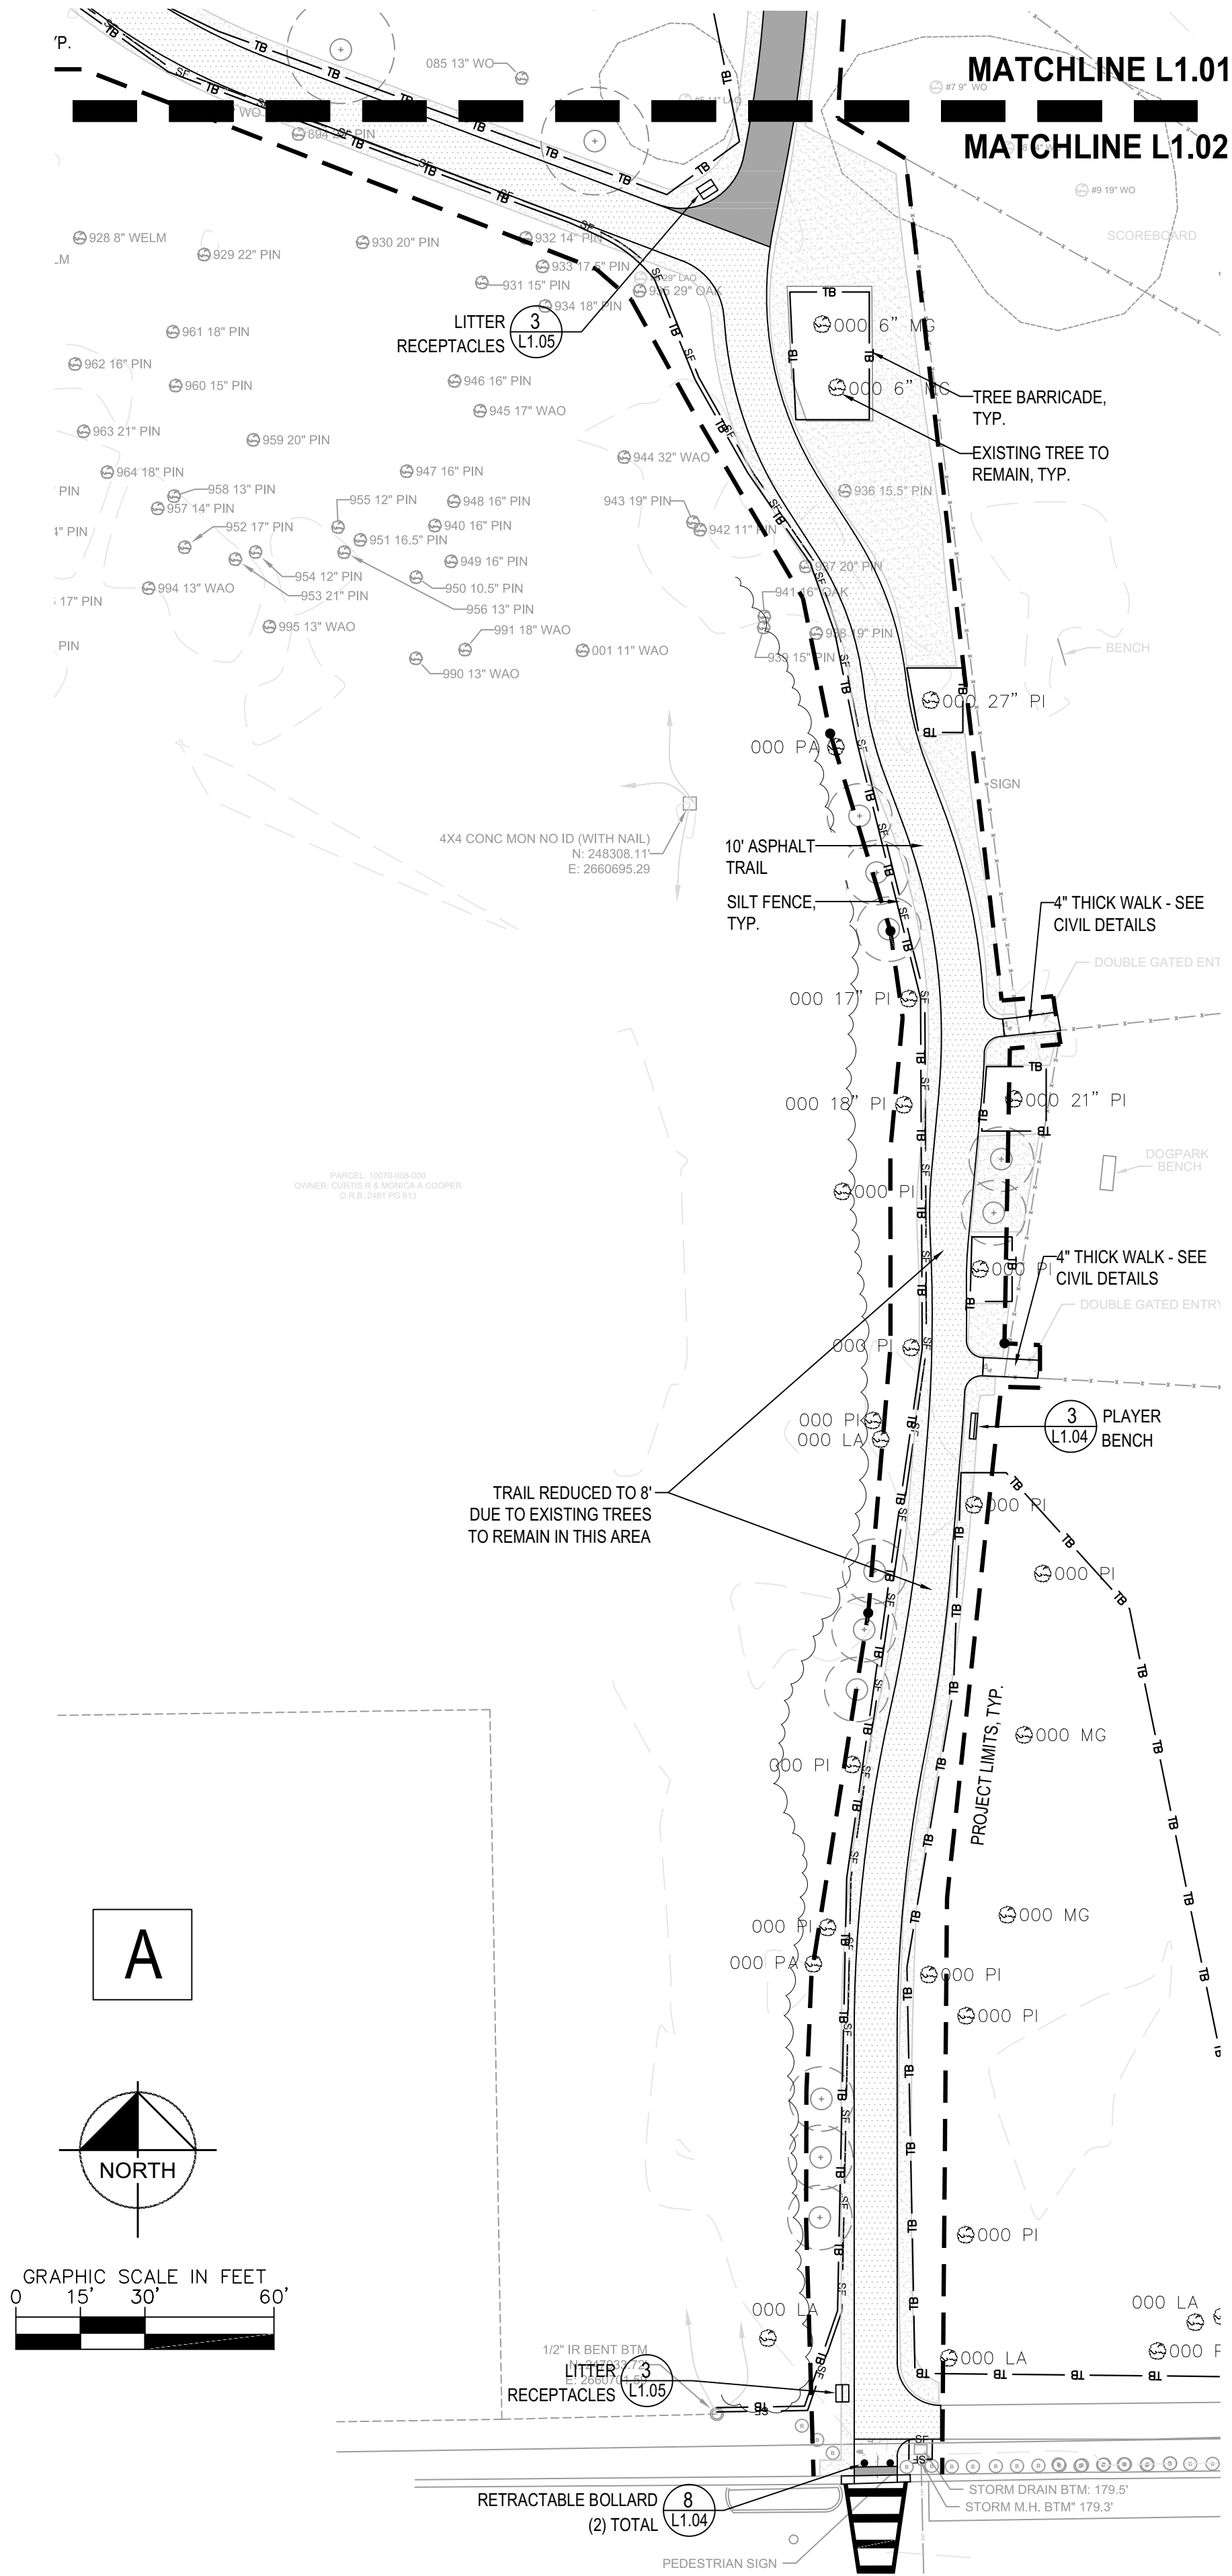

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SW25-000012 - SITE WORK -  
Tom Petty Park (LD24-000087)

02/28/25


## HARDSCAPE DETAILS

GAINESVILLE  
FLORIDA

SHEET NUMBER  
**L1.03**


NOTE:

1. INSTALL PER MANUFACTURER'S SPECIFICATIONS.
2. ROLL TURF AROUND NAILER BOARD AT ALL EDGES. TYP.
3. ENSURE AREAS DRAIN WELL BEFORE INSTALLING SURFACING.
4. PTP NAILER BOARD TO BE CONTACT TREATED LUMBER. MOUNT 1/2" - 3/4" BELOW CONCRETE SURFACE. SECURE TO CONCRETE WITH CONCRETE ANCHORS EVERY 24" ON CENTER. MIN.
5. INFILL SYNTHETIC TURF AS PER MANUFACTURER'S SPECIFICATIONS.
6. SECURE SYNTHETIC TURF WITH 1" LONG, 1/4" CROWN GALVANIZED STAPLES LOCATED WITHIN 1' OF CONCRETE AND SPACED 3' ON CENTER, MAX.
7. WASH #89 GRAVEL PRIOR TO PLACEMENT.
8. IN AREAS IN WHICH ROOTS 2" DIA. OR OVER ARE ENCOUNTERED, BRIDGE ROOTS REDUCING THE FLUSH CURB DEPTH 8" OR INSTEAD OF 8". CONTACT THE URBAN FORESTRY INSPECTOR AT 352-334-5023 FOR REVIEW AND APPROVAL REGARDING CONSTRUCTION METHODS AND PRIOR TO ANY SITEWORK ACTIVITIES WITHIN THE DRIPLINE OF LARGE EXISTING LIVE OAKS.
9. CONCRETE TO BE 4000 PSI.

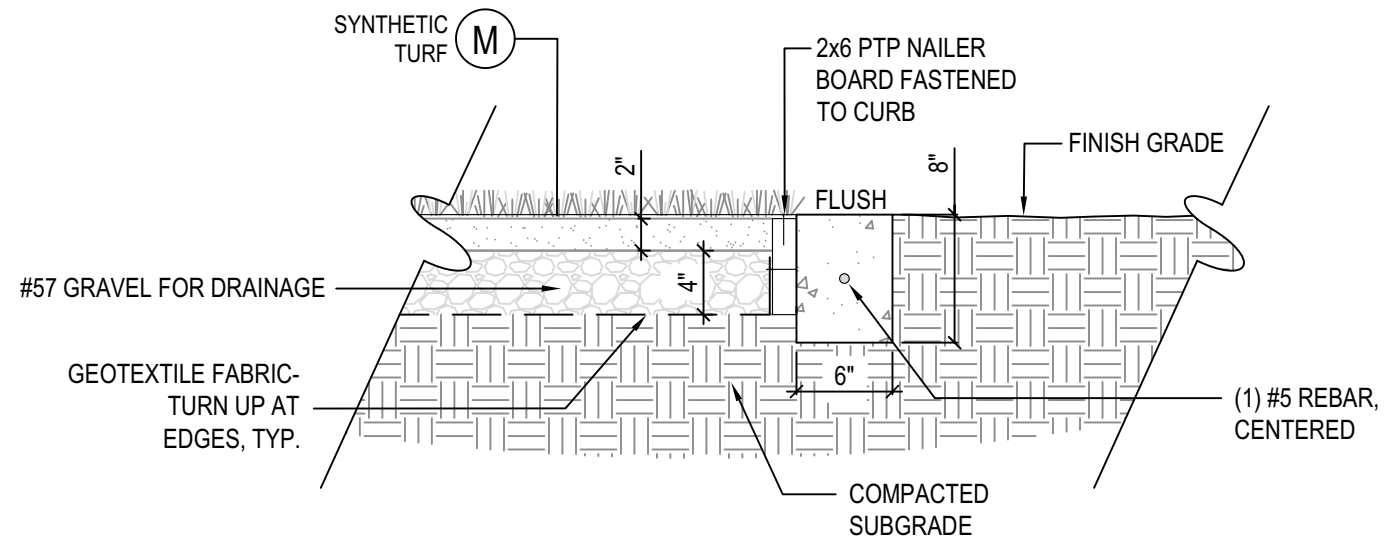

**1 SURFACING SECTION, SYNTHETIC TURF AT LANDSCAPE**  
SCALE: N.T.S.

1. INSTALL PER MANUFACTURER'S SPECIFICATIONS.
2. ROLL TURF AROUND NAILER BOARD AT ALL EDGES, TYP.
3. ENSURE AREAS DRAIN WELL BEFORE INSTALLING SURFACING.
4. PTP NAILER BOARD TO BE CONTACT TREATED LUMBER, MOUNT 1/2" - 3/4" BELOW CONCRETE SURFACE. SECURE TO CONCRETE WITH CONCRETE ANCHORS EVERY 24" ON CENTER, MIN.
5. INFILL SYNTHETIC TURF AS PER MANUFACTURER'S SPECIFICATIONS.
6. LOCATE WITHIN TURF WITH 1" LONG, 1/4" CROWN GALVANIZED STAPLES LOCATED WITHIN 1' OF CONCRETE AND SPACED 3' ON CENTER, MAX.
7. WASH #89 GRAVEL PRIOR TO PLACEMENT.
8. IN AREAS IN WHICH ROOTS 2" DIA. OR OVER ARE ENCOUNTERED, BRIDGE ROOTS BY REDUCING THE FLUSH CURB DEPTH TO 6" INSTEAD OF 8". CONTACT THE URBAN FORESTRY INSPECTOR AT 352-334-5023 FOR REVIEW AND APPROVAL REGARDING CONSTRUCTION METHODS AND PRIOR TO ANY SITEWORK ACTIVITIES WITHIN THE DRIPLINE OF LARGE EXISTING LIVE OAKS.
9. CONCRETE TO BE 4000 PSI.

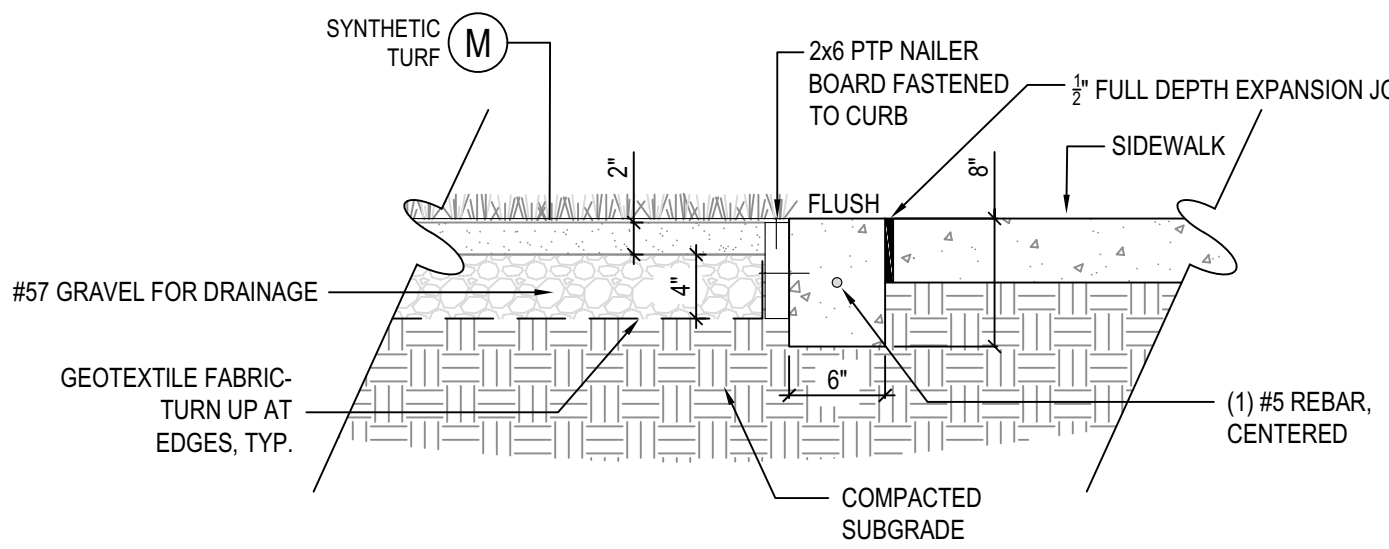

2 SURFACING SECTION, SYNTHETIC TURF AT WALK  
SCALE: N.T.S.

## PICKLEBALL COURT ELEMENT NOTES

- COURT FENCING TO BE 10 FT. HIGH CHAIN-LINK, BLACK VINYL COATED AND PER THE FOLLOWING:
- A. FABRIC: 120" 9 GA. VINYL COATED (2" MESH) CHAIN LINK FABRIC.
  - B. TOP RAIL: 1 5/8" O.D. FULL WEIGHT PIPE, 2.27 LBS. PER FOOT. TOP RAIL 21' IN LENGTH, JOINED WITH 1 5/8" SLEEVE.
  - C. LINE POST: 2 1/2" O.D. FULL WEIGHT PIPE, 3.65 LBS. PER FOOT. LINE POSTS SET 1' 0" ON CENTER MAXIMUM SPACING. CONCRETE FOOTING: 12" DIAMETER, 36" DEPTH.
  - D. TERMINAL POST: 3" O.D. FULL WEIGHT PIPE, 5.79 LBS. PER FOOT. CONCRETE FOOTING: 12" DIAMETER, 36" DEPTH.
  - E. BRACING: HORIZONTAL BRACING WITH 1-5/8" O.D. FULL WEIGHT PIPE BETWEEN EVERY POST
  - F. TENSION WIRE: 7 GA. COIL SPRING VINYL TENSION WIRE ATTACHED TO BOTTOM OF FENCE FABRIC WITH 9 GA. ALUMINUM HOG RING SPACED 24" ON CENTER.
  - G. FITTINGS: REGULAR BRACE BAND & CARRIAGE BOLT, PRESSED STEEL RAIL-END, PRESSED STEEL EYE-TOP, PRESSED STEEL CAP, 3/16" X 3/4" TENSION BAR, REGULAR TENSION BAND & CARRIAGE BOLT.
  - H. TIE WIRE: 8 1/4" 9 GA. ALUMINUM TIE WIRE SPACED 15" ON CENTER FOR LINE POSTS & 24" ON CENTER FOR RAILS.
  - I. POST FOOTING: HAND MIXED CONCRETE, 3000 PSI. FOOTINGS TO BE ENGINEERED BY THE FENCE MANUFACTURER. IF REQUIRED FOR CITY BUILDING PERMIT, PROVIDE SIGNED AND SEALED DRAWINGS OF POST FOOTING DETAILS SIGNED AND SEALED BY AN ENGINEER LICENSED IN THE STATE OF FLORIDA. PROVIDE THESE DRAWINGS AT NO ADDITIONAL COST TO THE PROJECT.
  - J. FENCE WINDSCREEN: INCLUDE FENCE WINDSCREEN ON ALL PERIMETER FENCING. USE 6 FT. HEIGHT 100% VINYL COATED POLYESTER MESH, SHADE FACTOR 70-80%, 3-PLY REINFORCED HEMS WITH BRASS GROMMETS EVERY 12". USE STANDARD COLOR OR SELECTED BY OWNER'S REPRESENTATIVE. WINDSCREENS BY PUTTERMAN ATHLETICS, (800) 621-0146, WWW.PUTTERMANATHLETICS.COM, OR APPROVED EQUAL.
  - K. GATES: SEE GATE LOCATIONS AND COUNT PER PLAN. GATES TO BE 4' WIDE FOR PEDESTRIANS ENTRIES AND 12' WIDE DOUBLE SWING GATES FOR MAINTENANCE ENTRIES.
  - L. HANDLES, PULLS, LATCHES, LOCKS AND OTHER OPERABLE PARTS ON GATES SHALL COMPLY WITH FBC-A 309.4. OPERABLE PARTS OF SUCH HARDWARE SHALL BE 34 INCHES MINIMUM AND 48 INCHES MAXIMUM ABOVE THE FINISH FLOOR OR GROUND, FBC-A 404.2.7.
2. COURT EDGE FLUSH CURB TO BE THE FOLLOWING:
- A. INSTALL A 12" WIDE X 8" DEEP CONCRETE FLUSH CURB WITH (1) #5 BAR CONTINUOUS AS THE OUTSIDE PERIMETER OF COURTS. CENTER PERIMETER FENCING IN BAND.
  - B. BAND TO MATCH ADJACENT WALK SURFACING IN COLOR AND FINISH.
  - C. INSTALL FULL DEPTH 1/2" EXPANSION JOINT BETWEEN BAND AND ADJACENT PAVING, TYPICAL.
  - D. INSTALL EXPANSION JOINTS EVERY 20 FT. MAXIMUM AND CONTROL JOINTS EVERY 6 FT. MAXIMUM, WITH JOINTS EVENLY SPACED ALONG RUNS AND EXPANSION JOINTS AT ALL CORNERS.
3. COURT PAVING TO BE PER THE FOLLOWING:
- A. SEE GRADING PLANS FOR PROPOSED GRADES.
  - B. COMPACT SUBGRADE TO 95% STANDARD PROCTOR.
  - C. INSTALL 6" FOOT LIMEROCK BASE, COMPACTED OVER SUBGRADE.
  - D. INSTALL ASPHALT SURFACE COURSE AS 1-1/2" VIRGIN ASPHALT (SP 9.5 VIRGIN MIX, NO RECYCLED MIX).
  - E. INSTALL COURT COATING AS PER BELOW.
4. COURT COATING TO BE PER THE FOLLOWING:
- A. INSTALL ACRYLIC RESURFACER BLENDED WITH APPROVED SILICA SAND OVER NEW ASPHALT.
  - B. INSTALL CALIFORNIA SPORTS SURFACES PLEXIPAVE® PLEXI STANDARD® HARDCOURT SURFACE SYSTEM® ATHLETIC SURFACE OR APPROVED EQUAL, OVER RESURFACER. SEE WWW.ICPGROUP.COM OR (978) 623-9980.
  - C. INSTALL PER MANUFACTURER'S SPECIFICATIONS. APPLY TWO COATS OF ACRYLIC RESURFACE ARE TWO COATS OF FINISH COLOR.
  - D. NEW ASPHALT TO CURE A MINIMUM OF 14-DAYS PRIOR TO SURFACING.
  - E. USE THREE COURT COLORS, ALL STANDARD COLORS, FOR 1.) PLAYING AREA, 2.) OUT OF BOUNDS, AND 3.) KITCHEN. COLORS TO BE SELECTED BY OWNER'S REPRESENTATIVE.
  - F. LINE PAINT COLOR, WIDTH, AND LAYOUT TO BE PER USA PICKLEBALL NATIONAL STANDARDS.
5. COURT NETS AND POSTS TO BE PER THE FOLLOWING:
- A. PICKLEBALL NETS AND POST TO BE PUTTERMAN ATHLETICS OR APPROVED EQUAL, WWW.PUTTERMANATHLETICS.COM, (800) 621-0146.
  - B. NETS TO BE 32" NETS, 3.0MM BRAIDED POLYETHYLENE ROPE IN 1-3/4" KNOTTED MESH, WITH INCLUDE HEAD, SIDE, AND BOTTOM BANDS WITH BUILT-IN GROMMETS AND STEEL COATED CABLE
  - C. INCLUDE INTERNAL WIND POST SET, 3" DIAMETER, 54" HEIGHT, POWDER-COATED STEEL POST WITHIN TERNAL BRASS WINDER AND LACING RODS.
  - D. INCLUDE CRANK AND TWO POST CAPS. COLOR TO BE BLACK. NET POST FOOTING TO BE PER MANUFACTURER'S SPECIFICATIONS.
  - E. INSTALL BELOW ASPHALT SURFACING SUCH THAT SURFACING IS TO POST SLEEVE.
6. INCLUDE ONE (1) PLAYER BENCH AT EACH COURT, WITH THE LOCATION OF THE BENCH CONFIRMED BY OWNER IN THE FIELD. SEE DETAIL 3/SHEET L1.04 FOR PLAYER BENCH SPECIFICATION.

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SW25-000012 - SITE WORK -  
Tom Petty Park (LD24-000087)

02/28/25

KHA PROJECT

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## HARDSCAPE DETAILS

**TOM PETTY PARK  
PICKLEBALL IMPROVEMENTS  
PREPARED FOR  
CITY OF GAINESVILLE  
WILD SPACES & PUBLIC PLACES  
GAINESVILLE, FLORIDA**

SHEET NUMBER  
**L1.04**

A SPORTS NET



1 SPORTS NET  
SCALE: N.T.S.

**B** TENNIS SHADE  
STRUCTURE



## 2 TENNIS SHADE STRUCTURE


**E** TABLE WITH  
3 CHAIRS

F TABLE WITH 4-CHAIRS



6 TABLE AND CHAIRS  
SCALE: N.T.S.

1 DECORATIVE BIKE RACK

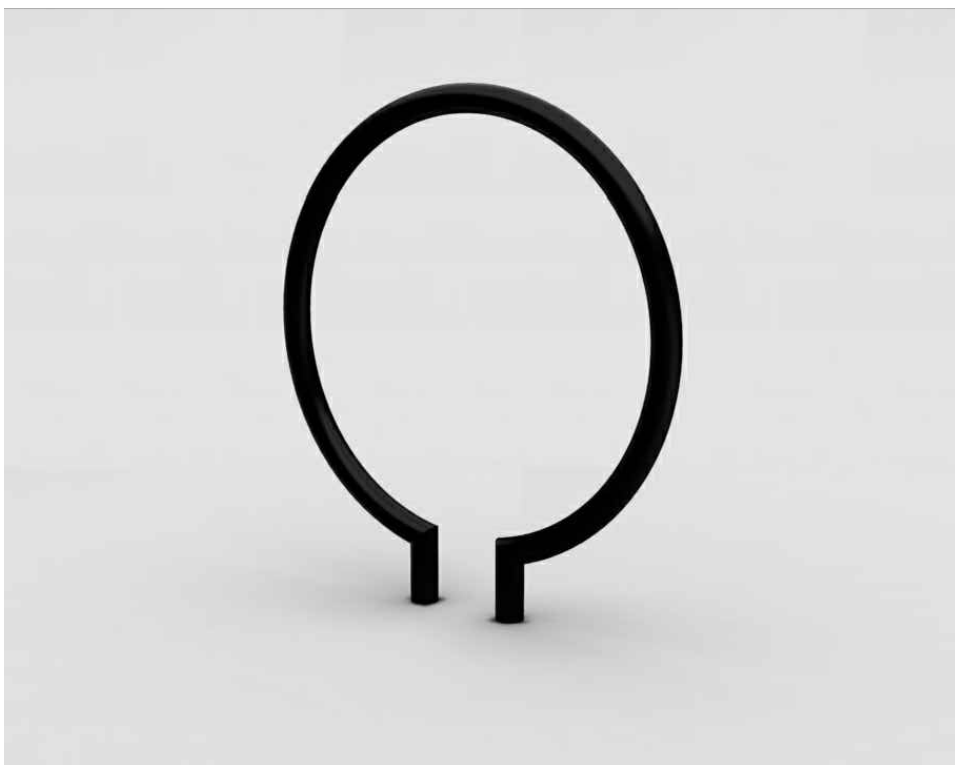

## 9 DECORATIVE BIKE RACK

**(D) PLAYER BENCH**



3 **PLAYER BENCH**  
SCALE: N.T.S.

NOTE:

- AUGER AREA TO MINIMUM 12" DIAMETER HOLE FOR 4" BOLLARD OR MINIMUM 18" DIAMETER HOLE FOR 6" BOLLARD.
- REMOVE SOIL AND PLACE 3000 PSI READY MIX CONCRETE AT BOTTOM TO PROVIDE LEVEL AND SUFFICIENT BASE-MAINTAINING MINIMUM DEPTH OF 2".
- PLACE BOLLARD AND ENSURE IT IS LEVEL AND PLUMB (SHOULD BE 36" ABOVE GRADE).
- PLACE 3000 PSI READY MIX CONCRETE FROM BOTTOM OF EXCAVATION AND AROUND BOLLARD TO GRADE LEVEL.
- PLACE 3000 PSI READY MIX CONCRETE INSIDE BOLLARD, FULL LENGTH AND LEVEL WITH TOP OF BOLLARD IF USING SLEEVE OR DOME SHAPE IF PAINTING UNIT

**G** BOLLARD (FIXED)



**7** **FIXED BOLLARD**  
SCALE: N.T.S.

**S** TRAPÉCIO BENCH



4 TRAPÉCIO BENCH  
SCALE: N.T.S.

 BOLLARD (RETRACTABLE)

NOTE: INSTALL PER  
MANUFACTURERS  
SPECIFICATION AND  
FOOT DESIGN.



8 RETRACTABLE BOLLARD  
SCALE: N.T.S.

**U BIKE SERVICE STATION**

NOTE: ORIENT SERVICE STATION AS SHOWN IN PHOTO  
RELATIVE TO CONCRETE PAD AND ACCESS DIRECTION.



**11 BIKE SERVICE STATION**  
SCALE: N.T.S.

**J** STANDARD BIKE RACK



10 STANDARD BIKE RACK  
SCALE: N.T.S.

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(S)	TRAPECIO BENCH QTY = 2	PRODUCT: Landscape Forms 'Trapezio' concrete bench, 32" wide x 212" length x 27" height FINISH: Standard concrete with acid-etched finish COLOR: Standard SUPPLIER: Landscape Forms, Kelley Moore, (407) 754-6214, <a href="mailto:kmoores@landscapeforms.com">kmoores@landscapeforms.com</a>
(T)	NOISE REDUCING PANELS	PRODUCT: 850 Series Pickleball Court Acoustic Wraps by FenceScreen, 10' x 4' standard panels including grommets and fasteners. Attach to pickleball court fencing as per FenceScreen and chain-link fencing manufacturer's specifications. FINISH: Standard COLOR: Standard, selected by owner SUPPLIER: FenceScreen, <a href="http://www.fencescreen.com">www.fencescreen.com</a> , (877) 975-5216
(U)	BIKE SERVICE STATION QTY = 1	PRODUCT: Dero Single Sided Fixit Plug with Fixit Pump: Air Kit Prime FINISH: Powder coat COLOR: Black SUPPLIER: Dero, <a href="http://www.dero.com">www.dero.com</a> , (888) 337-6729
(V)	BAT HOUSE QTY = 1	PRODUCT: Four Chambered Bat House with (2) posts and mounting hardware and laser engraved faceplate. Install at height per manufacturer's specifications. Manufacturer to provide post embedment and/or footing design. FINISH: Standard COLOR: Standard SUPPLIER: Lubees Bat Conservancy, <a href="http://www.lubees.org">www.lubees.org</a> , (352) 485-1250, <a href="mailto:info@lubees.org">info@lubees.org</a>

FINISH SCHEDULE		
<p>NOTE:</p> <ul style="list-style-type: none"> <li>SUBMIT SAMPLES AND SHOP DRAWINGS FOR ALL ITEMS FOR OWNER REPRESENTATIVE'S APPROVAL PRIOR TO ORDERING/ INSTALLATION.</li> <li>SUBSTITUTIONS SHALL NOT BE ACCEPTED WITHOUT PRIOR APPROVAL BY OWNER REPRESENTATIVE.</li> <li>MOCK-UPS ARE REQUIRED FOR ALL PAVING TYPES AND PATTERNS. MOCK UPS MAY BE CONSTRUCTED IN PLACE AND SHALL BE A MINIMUM OF 6'-0" LENGTH FOR WALKS OR BANDS AND 6'-0" x 6'-0" FOR PAVING AREAS.</li> <li>ADHERE TO MANUFACTURER'S INSTALLATION PROCEDURES AND SPECIFICATIONS.</li> <li>PROVIDE ALL HARDWARE FOR SURFACE MOUNTING, UNLESS OTHERWISE SHOWN. HARDWARE TO BE HOT DIPPED, GALVANIZED AND VANDAL RESISTANT.</li> </ul>		
SYM	ITEM	DESCRIPTION
(A)	SPORTS NET QTY = 1	<p>PRODUCT: #36 Nylon Backstop Netting, 12' high, including posts and attachment hardware per manufacturer's specifications. Provide signed and sealed plans per an engineer licensed in the State of Florida, for post footings.</p> <p>FINISH: Standard</p> <p>COLOR: Standard, selected by owner</p> <p>SUPPLIER: BURBANK SPORT NETS, <a href="http://WWW.BURBANKSPORTNETS.COM">WWW.BURBANKSPORTNETS.COM</a>, (866) 349-0057</p>
(B)	TENNIS SHADE STRUCTURE QTY = 1	<p>PRODUCT: 12' x 30' Cantilevered Shade Structure - to match existing</p> <p>FINISH: To match existing</p> <p>COLOR: To match existing</p> <p>SUPPLIER: <a href="https://WWW.CREATIVESHADESOLUTIONS.COM">https://WWW.CREATIVESHADESOLUTIONS.COM</a></p>
(C)	CENTRAL SHADE STRUCTURE QTY = 2	<p>PRODUCT: 18' x 20' Two-post, Hip Roof Shade Structure</p> <p>FINISH: To match existing</p> <p>COLOR: To match existing</p> <p>SUPPLIER: <a href="https://WWW.CREATIVESHADESOLUTIONS.COM">https://WWW.CREATIVESHADESOLUTIONS.COM</a></p>
(D)	PLAYER BENCH QTY = 10	<p>PRODUCT: UltraSite Custom Backed Bench, Model #P940S-P6-CL 6' length, surface mount - See detail for bench text</p> <p>FINISH: Standard</p> <p>COLOR: 'Textured Black' frame with 'Blue' bench seat and back</p> <p>SUPPLIER: Bliss Products, Jessica Allen, (904) 315-4664 or <a href="mailto:jessica@blissproducts.com">jessica@blissproducts.com</a></p>
(E)	TABLE WITH 3-CHAIRS QTY = 8	<p>PRODUCT: DuMor Model # 101-40, 42" diameter, with 3 attached chairs, no umbrella hole, portable, surface mounted</p> <p>FINISH: Standard, circle perforation chairs, solid table top</p> <p>COLOR: 'Textured Black'</p> <p>SUPPLIER: REP Services, Contact Mary Langley, (407) 831-9658, <a href="mailto:MLangley@REPServices.com">MLangley@REPServices.com</a></p>
(F)	TABLE WITH 4-CHAIRS QTY = 12	<p>PRODUCT: DuMor Model # 101-40, 42" diameter, with 4 attached chairs, no umbrella hole, portable, surface mounted</p> <p>FINISH: Standard, circle perforation chairs, solid table top</p> <p>COLOR: 'Textured Black'</p> <p>SUPPLIER: REP Services, Contact Mary Langley, (407) 831-9658, <a href="mailto:MLangley@REPServices.com">MLangley@REPServices.com</a></p>
(G)	FIXED BOLLARD QTY = 41	<p>PRODUCT: 4" Schedule 40 Primed Surplus Steel Bollard with 18" Bollard Cover</p> <p>FINISH: Standard</p> <p>COLOR: Dark Gray</p> <p>SUPPLIER: Bollard Solutions, Wanda McConnell, (626) 628-3311, <a href="mailto:bollardsolutionsltd@gmail.com">bollardsolutionsltd@gmail.com</a></p>
(H)	RETRACTABLE BOLLARD QTY = 11	<p>PRODUCT: To match existing City Parks standard</p> <p>FINISH: To match existing City Parks standard</p> <p>COLOR: To match existing City Parks standard</p> <p>SUPPLIER: To match existing City Parks standard</p>
(I)	DECORATIVE BIKE RACK QTY = 4	<p>PRODUCT: Landscape Forms, 'Ring' Model</p> <p>FINISH: Standard</p> <p>COLOR: Black</p> <p>SUPPLIER: Landscape Forms, 800-381-3455, <a href="http://www.LandscapeForms.com">www.LandscapeForms.com</a></p>
(J)	STANDARD BIKE RACK QTY = 5	<p>PRODUCT: Standard City Of Gainesville Bike Rack</p> <p>FINISH: Standard</p> <p>COLOR: White</p> <p>SUPPLIER: Contact City Of Gainesville Parks</p>
(K)	PADDLE RACK QTY = 4	<p>PRODUCT: Model No. 2458-PVC Rack, 24-rack, 57" long PVC paddle rack</p> <p>FINISH: Standard</p> <p>COLOR: Standard</p> <p>SUPPLIER: NEXTUP Pickleball Racks, <a href="https://nextuppickleball.com/nextup-pickleball-racks/pvc/pvc-paddle-rack/">https://nextuppickleball.com/nextup-pickleball-racks/pvc/pvc-paddle-rack/</a>, (651) 303-9835</p>
(L)	DRINKING FOUNTAIN QTY = 1	<p>PRODUCT: Pedestal h/w/dw drinking fountain, Model # 840 SMSS with jug filler, and recessed hose bibb &amp; lock door</p> <p>FINISH: Textured powdercoat with stainless steel surface carrier</p> <p>COLOR: 'Textured Sapphire'</p> <p>SUPPLIER: Most Dependable Fountains, <a href="http://www.mostdependable.com">www.mostdependable.com</a>, (901) 867-0039</p>
(M)	LITTER RECEPTACLE QTY = 7	<p>PRODUCT: Max-R, Terra Style, Recycled Plastic, Standard City of Gainesville</p> <p>FINISH: Standard</p> <p>COLOR: Green-black trip and roof; symbols and text per City of Gainesville standard</p> <p>SUPPLIER: Max-R</p>
(N)	SYNTHETIC TURF	<p>PRODUCT: Forever Lawn K9Grass Classic+</p> <p>FINISH: Standard</p> <p>COLOR: Standard 'Summer Green' primary and 'Turf Green' secondary</p> <p>SUPPLIER: REP Services, Contact Mary Langley, (407) 831-9658, <a href="mailto:MLangley@REPServices.com">MLangley@REPServices.com</a></p>
(O)	GRAVEL	<p>PRODUCT: #57 Stone</p> <p>FINISH: Standard</p> <p>COLOR: Standard</p> <p>SUPPLIER: Southern Aggregates, (352) 245-4445 or <a href="http://www.southernrockyard.com">www.southernrockyard.com</a></p>
(P)	TWIG BENCH WITH BACK QTY = 2	<p>PRODUCT: Landscape Forms 'Twig' modular bench, backed, 76" depth x 93" length x 18" height</p> <p>FINISH: Standard acid-etched/waterproofed finish</p> <p>COLOR: Grey</p> <p>SUPPLIER: Landscape Forms, Kelley Moore, (407) 754-6214, <a href="mailto:kmoore@landscapeforms.com">kmoore@landscapeforms.com</a></p>
(Q)	BACKLESS TWIG BENCH QTY = 2	<p>PRODUCT: Landscape Forms 'Twig' modular bench, backless, 76" depth x 93" length x 18" height</p> <p>FINISH: Standard acid-etched/waterproofed finish</p> <p>COLOR: Grey</p> <p>SUPPLIER: Landscape Forms, Kelley Moore, (407) 754-6214, <a href="mailto:kmoore@landscapeforms.com">kmoore@landscapeforms.com</a></p>
(R)	STARFISH AIR BENCH QTY = 1	<p>PRODUCT: Landscape Forms 'Starfish Air' modular bench, backless, 75" depth x 81 1/2" length x 16 1/2" height</p> <p>FINISH: Standard acid-etched/waterproofed finish</p> <p>COLOR: Grey</p> <p>SUPPLIER: Landscape Forms, Kelley Moore, (407) 754-6214, <a href="mailto:kmoore@landscapeforms.com">kmoore@landscapeforms.com</a></p>

DESIGN DEVELOPMENT SUBMITTAL	05-21-24	-
90% CONSTRUCTION DOCUMENTS	07-02-24	-
SITE DEVELOPMENT REVIEW	09-06-24	-
SITE DEVELOPMENT REVIEW	12-20-24	-
SITE DEVELOPMENT REVIEW &		
BID ADDENDUM NO. 1	01-22-25	-
NOT FOR CONSTRUCTION	-	-
No.	REVISIONS	DATE
		BY

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SW25-000012 - SITE WORK -  
Tom Petty Park (LD24-000087)

02/28/25

OVERALL  
LANDSCAPE PLAN, NOTES,  
AND SCHEDULE

**TOM PETTY PARK  
PICKLEBALL IMPROVEMENTS  
PREPARED FOR  
CITY OF GAINESVILLE  
WILD SPACES & PUBLIC PLACES  
GAINESVILLE, FLORIDA**

SHEET NUMBER

L2.00

- PRE-CONSTRUCTION MEETING: CONTACT THE CITY OF GAINESVILLE URBAN FORESTRY INSPECTOR AT 352-334-5023 TO SCHEDULE A TREE BARRICADE INSPECTION AND TO REVIEW PROPOSED LANDSCAPE MATERIALS BEFORE BEGINNING ANY CLEARING, SITE WORK, OR INSTALLATION ACTIVITIES. CONTACT A MINIMUM OF THREE DAYS PRIOR TO REQUESTED MEETING DATE.
2. EXISTING TREE PROTECTION: PROTECTIVE BARRIERS SHALL BE CONSTRUCTED AS INDICATED IN DEMOLITION PLANS TO PREVENT THE DESTRUCTION OR DAMAGING OF REGULATED TREES THAT ARE LOCATED WITHIN 50 FEET OF ANY CONSTRUCTION ACTIVITY OR STORAGE OF EQUIPMENT AND MATERIALS. PROTECTED TREES SHALL INCLUDE THOSE TREES THAT HAVE NOT BEEN PERMITTED NOR DESIGNATED FOR REMOVAL AS SHOWN IN DEMOLITION PLANS BY EITHER THE TERMS OF THE PERMIT OR APPROVED DEVELOPMENT ORDER. PROTECTIVE BARRIERS SHALL BE PLAINLY VISIBLE AND SHALL CREATE A CONTINUOUS BOUNDARY AROUND TREES OR VEGETATION CLUSTERS IN ORDER TO PREVENT ENCRoACHMENT BY MACHINERY, VEHICLES, OR STORED MATERIALS. BARRIERS SHALL BE INSPECTED BY THE URBAN FORESTRY INSPECTOR PRIOR TO PROCEEDING WITH SITE WORK. SEE TREE PROTECTION DETAILS FOR SPECIFIC REQUIREMENTS FOR BOTH REGULATED TREES AND HIGH-QUALITY, HERITAGE TREES.
3. EXISTING UTILITIES: LOCATE ALL UTILITIES PRIOR TO COMMENCEMENT OF WORK. CALL SUNSHINE STATE ONE CALL - SEE LOGO BELOW.
4. INVASIVE SPECIES: REMOVE INVASIVE, NONNATIVE PLANT SPECIES AS LISTED ON THE FLORIDA PROHIBITED AQUATIC PLANTS LIST. THE SITE PRIOR TO ISSUANCE OF THE CERTIFICATE OF OCCUPANCY. ALL HERBICIDE APPLICATIONS TO CONTROL INVASIVE, NONNATIVE SET-ASIDE AREAS, INCLUDING BUFFERS, SHALL BE APPLIED BY A CONTRACTOR LICENSED BY THE FLORIDA DEPARTMENT OF AGRICULTURE/AGRICULTURAL ENVIRONMENTAL SERVICES, WITH A CURRENT CERTIFICATION IN NATURAL AREAS WEED MANAGEMENT.
5. PLANTING PREPARATION: REMOVE ALL CONSTRUCTION DEBRIS, LIMEROCK, GRAVEL, ROAD BEDDING, LITTER, AND OTHER ITEMS WITHIN PROPOSED LANDSCAPE AND TURF AREAS PRIOR TO PLANTING. MAINTAIN EXISTING GRADES UNLESS OTHERWISE APPROVED. IS REQUIRED, USE A CLEAN, SANDY LOAM WITH pH 5.5-6.5 AND EXCAVATED FROM LOCAL SOURCES AND DEEP PITS SUCH THAT IT AND OTHER ITEMS HARMFUL TO PLANTINGS.
6. PRUNING: IF TREE OR ROOT PRUNING IS REQUIRED, THESE ACTIVITIES SHALL BE PERFORMED BY AN ARBORIST CERTIFIED BY THE (ISA). PRUNING SHALL BE DONE IN ACCORDANCE WITH THE MOST CURRENT VERSION OF THE AMERICAN NATIONAL STANDARD FOR OTHER WOODY PLANT MAINTENANCE" (ANSI A300) AND "PRUNING, TRIMMING, REPAIRING, MAINTAINING, AND REMOVING TREES. A (ANSI Z133). NO MORE THAN 25 PERCENT OF THE CROWN SHOULD BE REMOVED AT ONE TIME, ON YOUNG TREES, LIMB REMOVAL, THE TRUNK BARK OF BRANCHES TREE AND/OR ROOT PRUNING ACTIVITIES FOR HIGH QUALITY HERITAGE TREES SHALL BE OVERSEEN BY AN ARBORIST. MINIMIZE IMPACTS ON EXISTING TREE ROOTS AS MUCH AS POSSIBLE. AVOID TREE ROOT PLATE AREAS AS DEFINED BY PERMIT THAT ARE ADJACENT TO EXTENSIVE EXCAVATION AND ARE 1" DIAMETER OR OVER SHALL BE HAND CUT. EXPOSE ROOTS BY HAND DIGGING, COVER WITH SOIL. DO NOT ALLOW CUT ROOTS TO DRY OUT. SUPPLEMENTAL IRRIGATION IS REQUIRED FOR TREES THAT HAVE UNDERGONE IMMEDIATELY FOLLOWING ROOT TRIMMING ACTIVITIES.
7. MINIMUM PLANTING AREA: A MINIMUM ROOTZONE VOLUME OF 700 CUBIC FEET SHALL BE PROVIDED FOR STREET TREES. IF STREET SHALL BE A MINIMUM OF 550 CUBIC FEET. ALL OTHER REQUIRED SHADE TREES SHALL BE HAVE A MINIMUM OF 420 CUBIC FEET OF ROOTZONE. FOOT DEEP PLANTING DEPTH FOR ALL PROPOSED PLANTING AND TURF AREAS.
8. PLANT MATERIAL - GENERAL: ALL PLANT MATERIALS SHALL MEET FLORIDA NUMBER 1 REQUIREMENTS AS PER THE MOST CURRENT STANDARDS FOR NURSERY PLANTS', FLORIDA DEPARTMENT OF AGRICULTURE AND CONSUMER SERVICES.
9. PLANT MATERIAL - AQUATIC: FOR THOSE PLANTINGS INDICATED TO BE PLANTED WITHIN WET CONDITIONS, PROCURE FROM A SOURCE THAT CAN GUARANTEE WET CONDITIONS.
10. PROPOSED TREES: ALL TREES TO BE A MINIMUM OF SEVEN FEET TALL AND HAVE A MINIMUM TRUNK CALIPER OF TWO INCHES. TREES LOCATED OUTSIDE OF THE PLANTING AREA SHALL BE PLANTED IN CONTAINERS OR, IF FIELD GROWN, HAVE A MINIMUM ROOTBALL DIAMETER OF 28 INCHES. NEW TREES LOCATED OUTSIDE OF THE PLANTING AREA SHALL BE INSTALLED WITH DRAIN TUBING INSTALLED AROUND THE BASE OF THEIR TRUNK TO PROTECT FROM MOWER AND STRING TRIMMER IMPACTS.
11. NEW TREE STAKING: IF NECESSARY TO MAINTAIN TREES PLUMB, TREES SHALL BE STAKED WITH BIODEGRADABLE STAKING MATERIALS APPROVED BY URBAN FORESTRY INSPECTOR PRIOR TO INSTALLATION.
12. SOD: ALL UNPAVED AND DISTURBED AREAS OUTSIDE OF PROPOSED TREE, SHRUB, AND GROUNDCOVER PLANTINGS SHALL BE SOIL INFORMATION FOR STORMWATER FACILITIES. SOD SHALL BE SAND-GROWN, STRONGLY ROOTED, WITHOUT SYNTHETIC STABILIZERS, FREE OF NOXIOUS WEEDS BY THE FLORIDA DEPARTMENT OF AGRICULTURE AND CONSUMER SERVICES, DIVISION OF PLANT INDUSTRY.
13. TREE MULCHING: FOUR INCHES OF MULCH SHALL COVER TREE RING PLANTING AREAS AND ALL SHRUB AND GROUNDCOVER PLANTINGS DEEPER THAN ONE INCH OVER THE TOP OF TREE ROOTBALLS. USE PINE BARK MINI NUGGETS' MULCH IN ALL AREAS EXCEPT SOD. MULCH SHALL BE USED. INSTALL GRASS MULCH IN SWALES AS SHOWN IN PLAN. MULCH TO BE 3" - 1.2" MAX. BROWN RIVER ROCK, INSTALLED IN SWALES SHALL BE 12" DEEP. MULCH SHALL BE APPLIED TO ALL PLANTINGS. MULCH TO BE FREE OF DEBRIS, SOD, AND OTHER MATERIALS.
14. IRRIGATION: SEE IRRIGATION PLANS.
15. RESPONSIBILITY: OWNER IS RESPONSIBLE FOR THE SURVIVAL OF PLANTINGS AND REMOVAL OF ALL TREE STAKING, IF INSTALLED. IF A TREE THAT IS REQUIRED FOR MITIGATION OR TO FULFILL THE REQUIREMENTS OF THE LAND DAMAGE CERTIFICATE OF OCCUPANCY, AS DETERMINED BY THE CITY MANAGER OR DESIGNEE, THEN THE TREE MUST BE REPLACED WITHIN SIX MONTHS OF THE DATE OF REMOVAL.
16. TRANSPORTATION MOBILITY PROGRAM AREA: THIS PROJECT IS LOCATED WITHIN ZONE A OF THE T.M.P.A. AS SUCH, STREET TREE PLANTINGS SHALL BE REQUIRED BY OTHER LAND DEVELOPMENT REGULATIONS, HOWEVER - SEE LANDSCAPE CALCULATIONS.

EXISTING TREES TO REMAIN

### PROPOSED TREE



SOD NOTE: CONTRACTOR RESPONSIBLE FOR SODDING ALL DISTURBED AREAS. THE QUANTITY PROVIDED ASSUMES AREAS OF PROPOSED GRADING AND IMPROVEMENTS WITHIN PROJECT AREA. IF ADDITIONAL AREAS ARE DISTURBED, CONTRACTOR TO SOD AT NO ADDITIONAL COST TO THE PROJECT.


CODE	QTY	BOTANICAL / COMMON NAME	SIZE	SPACING	CODE	QTY	BOTANICAL / COMMON NAME	SIZE	SPACING	NOTES
<b>UNDERSTORY TREES</b>										
CC	3	Cercis canadensis / Eastern Redbud	30 gal., 8' ht. x 36" sprd., 2" cal.	As shown	<b>GROUND COVERS</b>					
PA	17	Prunus angustifolia / Chickasaw Plum	30 gal., 8' ht. x 30" sprd., 2" cal.	As shown	SM	424	Salvia missila / Creeping Sage	1 gal., 6" ht. x 12" sprd.	30" o.c.	
<b>CANOPY TREES</b>										
ARF	3	Acer rubrum 'Florida Flame' / Florida Flame Red Maple	30 gal., 11' ht. x 48" sprd., 2" cal.	As shown	<b>AQUATIC PLANTS</b>					
LT	3	Liquidambar styraciflua / Sweetgum	30 gal., 11' ht. x 48" sprd., 2" cal.	As shown	IVR	247	Iris virginica / Blue Flag Iris	1 gal. 18" ht., full	30" o.c.	0"-18" planting
LT	3	Quercus prinus / White Oak	30 gal., 11' ht. x 48" sprd., 2" cal.	As shown	THG	90	Thalia geniculata / Fire Flag	1 gal. 18" ht., full	48" o.c.	2'-24" planting
QV	4	Quercus virginiana / Southern Live Oak	30 gal., 11' ht. x 48" sprd., 2" cal.	As shown	<b>SOD/SEED</b>					
TD	6	Taxodium distichum / Bald Cypress	30 gal., 11' ht. x 48" sprd., 2" cal.	As shown	SOD	54,400 SF	Paspalum notatum 'Argentine' / Argentine Bahia Grass			Sand grown
<b>SHRUBS</b>										
HA	70	Hamelia patens 'Compact' / Dwarf Firebush	3 gal., 18" ht. x 18" sprd.	42" o.c.	<b>MULCH*</b>					
MC	555	Muhlenbergia capillaris / Pink Muhly	3 gal., 24" ht., full	36" o.c.	GM	130 CF	Gravel Mulch / Gravel Mulch	* NOTE TYPICAL MULCH FOR LANDSCAPE BEDS IS PINESTRAW - SEE NOTE 13. SPECIALTY MULCH IS		
VOS	88	Viburnum opacifolium 'Mrs Shillers Delight' / Mrs Shillers Delight Viburnum	3 gal., 18" ht. x 18" sprd.	36" o.c.						

\* NOTE TYPICAL MULCH FOR LANDSCAPE BEDS IS PINESTRAW - SEE NOTE 13. SPECIALTY MULCH IS LISTED BELOW FOR ONLY THOSE AREAS IDENTIFIED IN PLAN.

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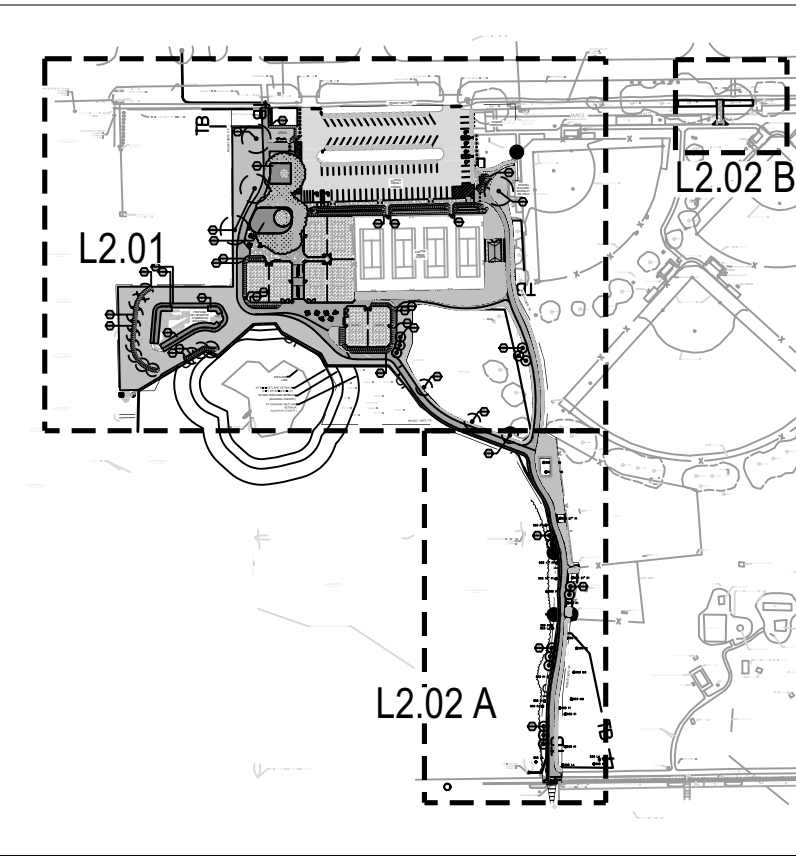
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DESIGN DEVELOPMENT SUBMITTAL	05-21-24	-	BY
90% CONSTRUCTION DOCUMENTS	07-02-24	-	DATE
SITE DEVELOPMENT REVIEW	09-06-24	-	BY
SITE DEVELOPMENT REVIEW	12-20-24	-	DATE
SITE DEVELOPMENT REVIEW & BID ADDENDUM NO. 1	01-22-25	-	BY
NOT FOR CONSTRUCTION	-	-	DATE
No.	REVISIONS	BY	DATE

KEY PLAN

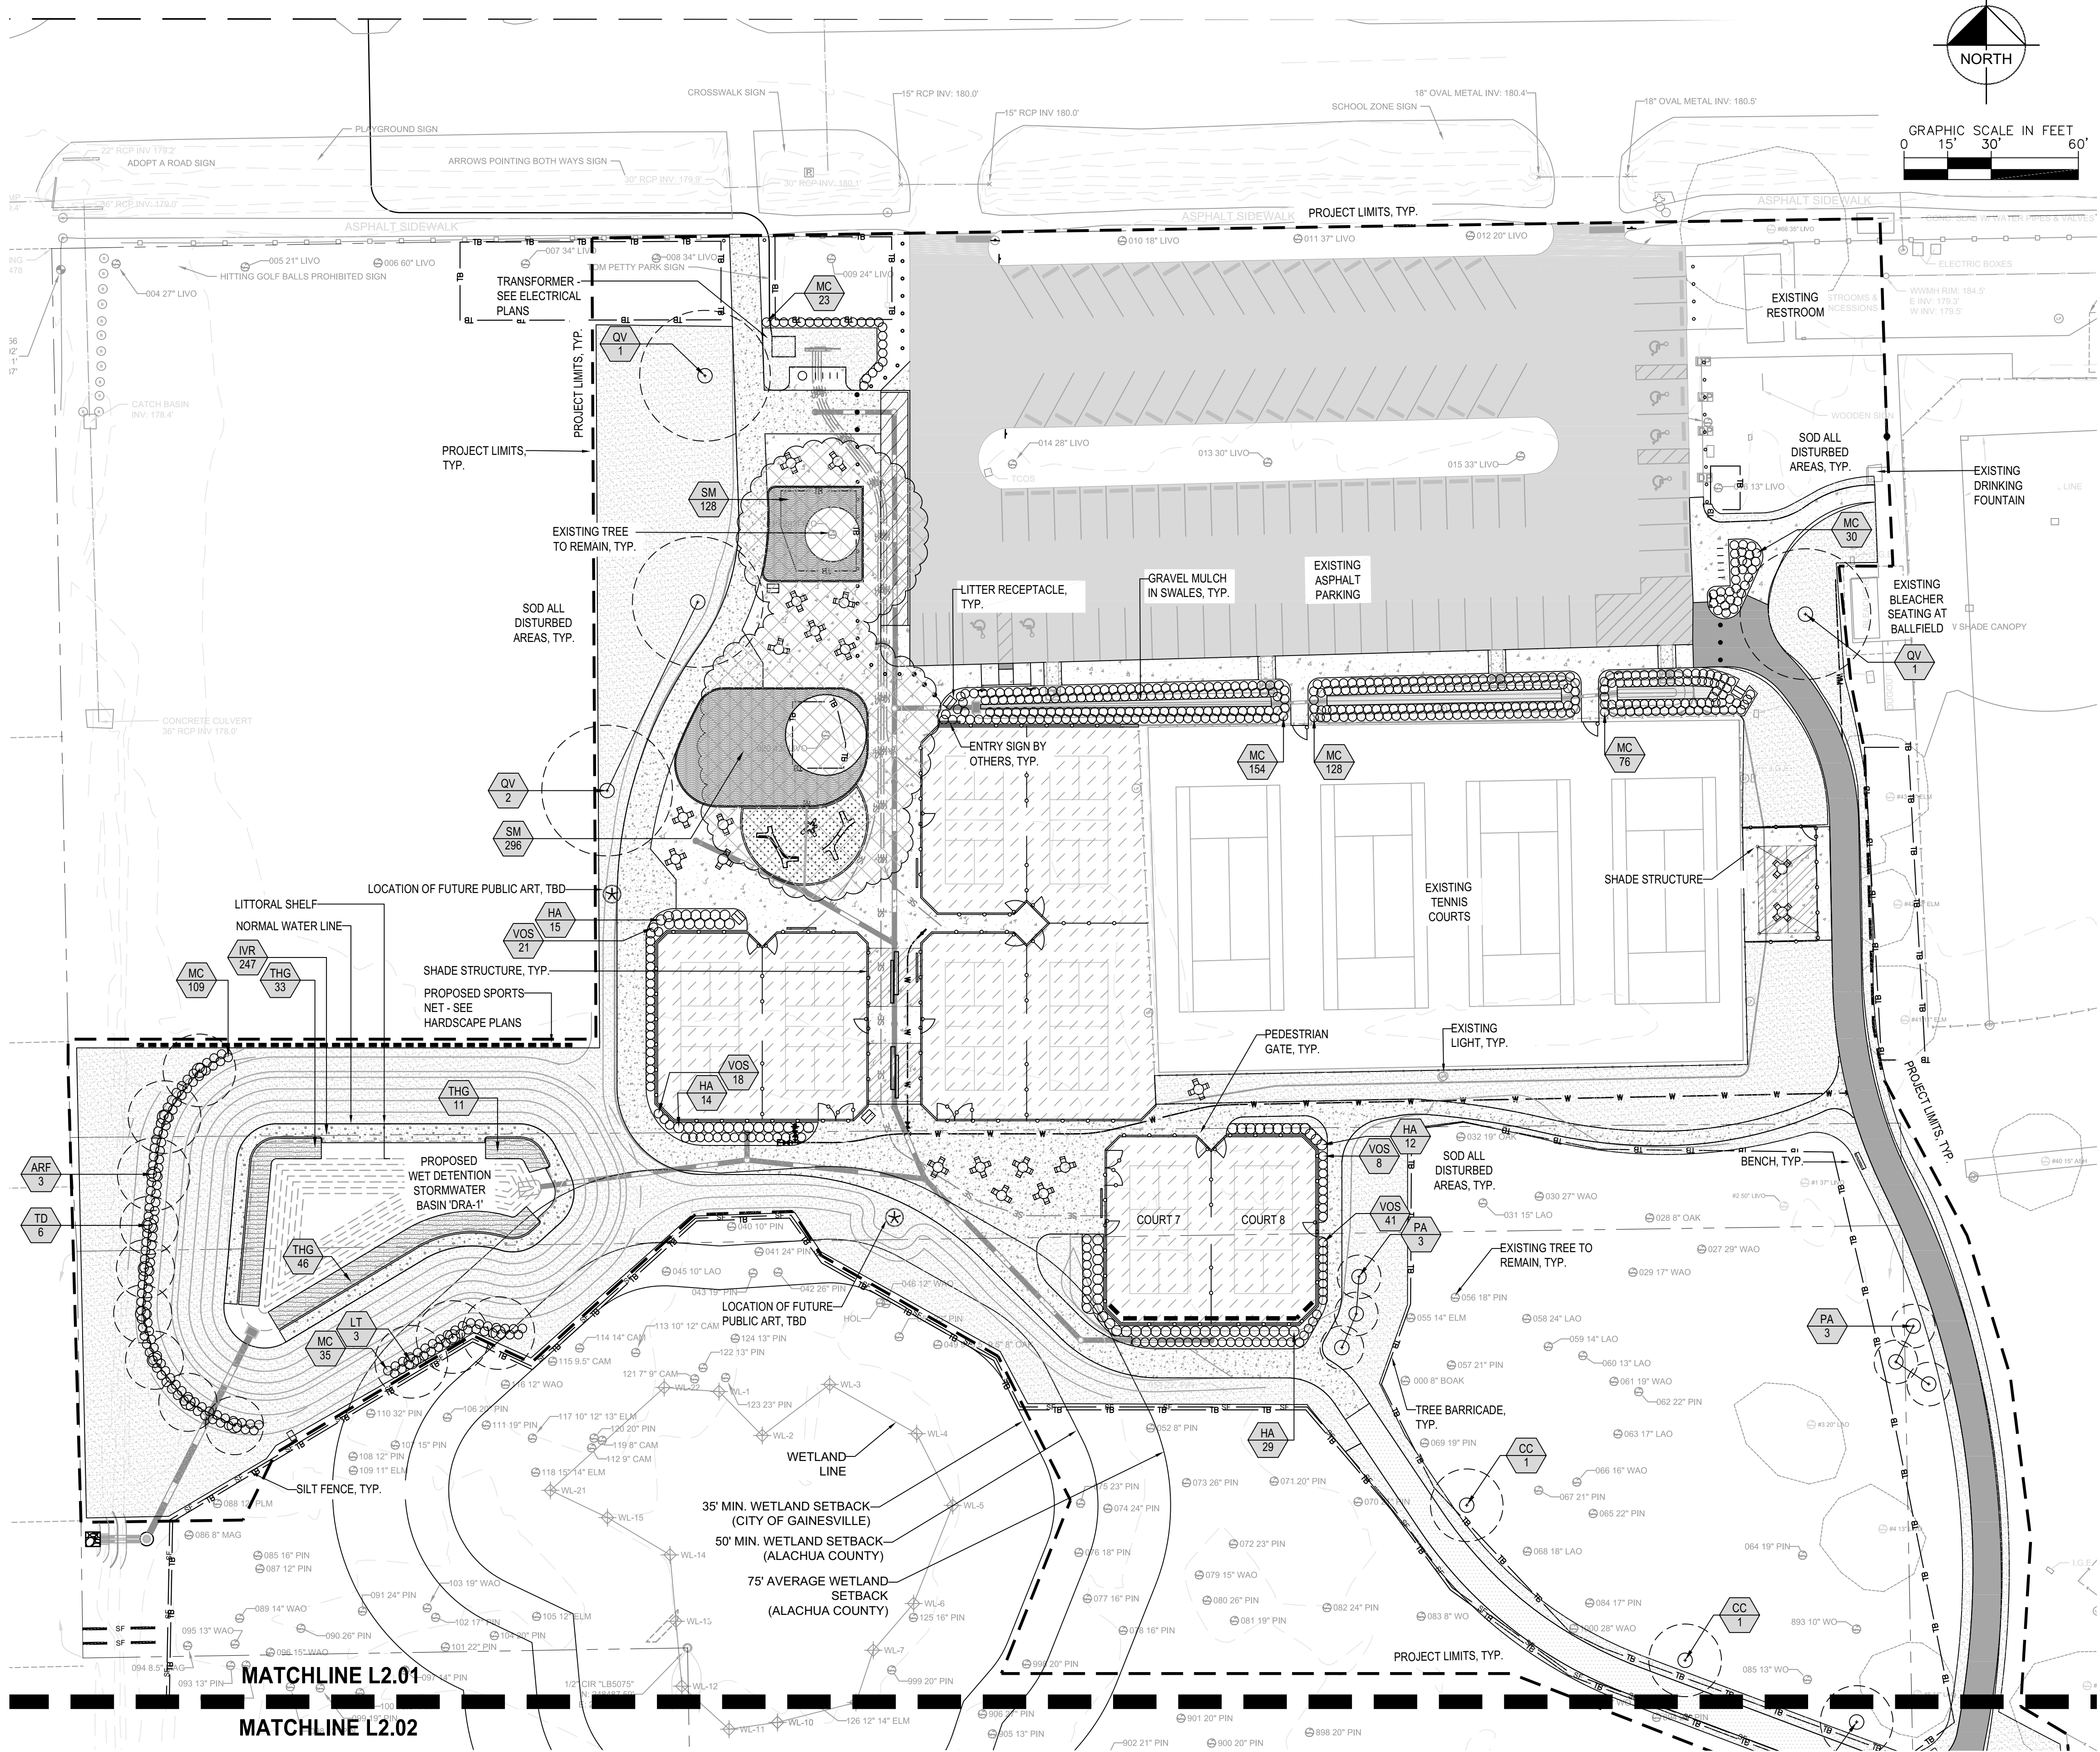

**Kimley»Horn**

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PHONE: 352-374-3274  
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**GAINESVILLE**  
REVIEWED FOR  
CODE COMPLIANCE

SW25-000012 - SITE WORK  
Tom Petty Park (LD24-000087)

02/28/25

KHA PROJECT  
142107025  
DATE  
JANUARY 2025  
SCALE  
AS SHOWN  
DESIGNED  
DRAWN  
CHECK

LANDSCAPE PLAN

TOM PETTY PARK  
PICKLEBALL IMPROVEMENTS  
PREPARED FOR  
CITY OF GAINESVILLE  
WILD SPACES & PUBLIC PLACES  
FLORIDA  
GAINESVILLE

SHEET NUMBER  
**L2.01**

DESIGN DEVELOPMENT SUBMITTAL	05-21-24	-
90% CONSTRUCTION DOCUMENTS	07-02-24	-
SITE DEVELOPMENT REVIEW	09-06-24	-
SITE DEVELOPMENT REVIEW	12-20-24	-
SITE DEVELOPMENT REVIEW & BID ADDENDUM NO. 1	01-22-25	-
NOT FOR CONSTRUCTION	-	-
No.	REVISIONS	DATE
		BY

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02/28/25

KHA PROJECT 142107025	DATE JANUARY 2025	SCALE AS SHOWN	DESIGNED SW25-000012 Tom Petty Park	DRAWN	CHECKED 02/28/25
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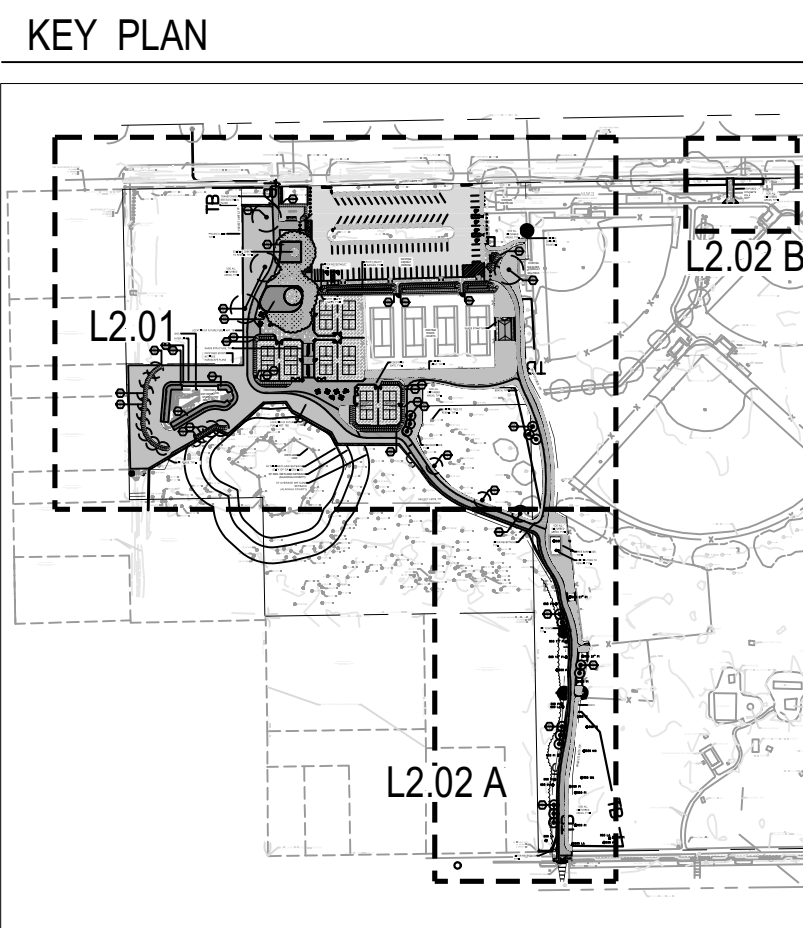
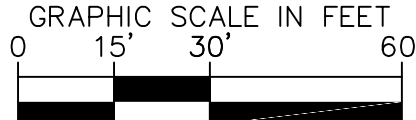
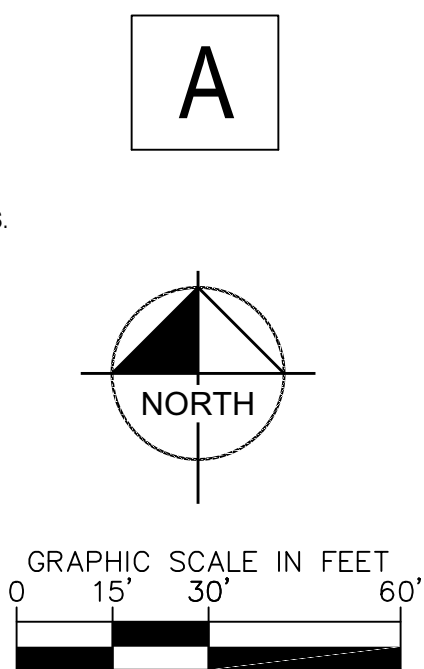
TOM PETTY PARK  
PICKLEBALL IMPROVEMENTS  
PREPARED FOR  
CITY OF GAINESVILLE  
WILD SPACES & PUBLIC PLACES

SHEET NUMBER  
**L2.02**


1. **UTILIZE THIS DETAIL FOR ALL EXISTING, HIGH QUALITY TREES THAT ARE 20" DBH AND LARGER.** HIGH QUALITY TREES ARE DEFINED BY THE CITY OF GAINESVILLE AS ANY OF THE FOLLOWING: Live Oak (*Quercus virginiana*), Sand Live Oak (*Q. geminata*), Bluff Oak (*Q. austrina*), Basket Oak (*Q. michauxii*), Southern Red Oak (*Q. falcata*), Southern Magnolia (*Magnolia grandiflora*), Florida Maple (*Acer barbatum*), Longleaf Pine (*Pinus palustris*), Spruce Pine (*P. sp.*), Cedar Elm (*Ulmus crassifolia*), Winged Elm (*U. alata*), Florida Elm (*U. floridana*), Bald Cypress (*Taxodium distichum*), Pond Cypress (*T. ascendens*), Tupelo (*Nyssa sylvatica*), Mockernut Hickory (*Carya tomentosa*) Pignut Hickory (*C. glabra*), Pecan (*C. illinoensis*), Persimmon (*Diospyros virginiana*), Basswood (*Tilia Americana*), Tulip Poplar (*Liriodendron tulipifera*), White Ash (*Fraxinus Americana*), Green Ash (*F. pensylvanica*) and Yaupon, Dahoon, and American Holly species (lex vomentoria, l. cassine, and l. opaca).
2. **DO NOT STORE MATERIALS OR ALLOW ENCRACEMENT OF VEHICLES OR MACHINERY WITHIN TREE BARRIER AREA. NO BUILDING MATERIALS, MACHINERY OR HARMFUL CHEMICALS SHALL BE PLACED WITHIN PROTECTIVE BARRIERS, EXCEPT SHORT-DURATION PLACEMENTS OF CLEAN FILL SOIL THAT WILL NOT HARM THE TREE.**
3. **NO GRADE CHANGES MAY OCCUR WITHIN TREE BARRIER AREA WITHOUT APPROVAL.**
4. **LANDSCAPE PREPARATION IN THE PROTECTED AREA SHALL BE LIMITED TO SHALLOW DISCING OF THE AREA. DISCING SHALL BE LIMITED TO A DEPTH OF FOUR INCHES UNLESS SPECIFICALLY APPROVED OTHERWISE.**
5. **TREE BARRIERS TO REMAIN IN PLACE UNTIL LANDSCAPING OPERATIONS BEGIN. ONCE REMOVED, VEHICLE AND EQUIPMENT TRAFFIC AND STORAGE OF MATERIALS WITHIN AREA SHALL BE MINIMIZED AS MUCH AS POSSIBLE.**




1. UTILIZE THIS DETAIL FOR ALL EXISTING, REGULATED TREES THAT ARE LESS THAN 20" DBH OR ARE NOT A HIGH QUALITY SPECIES (SEE DETAIL 1 FOR A LIST OF HIGH QUALITY SPECIES).
2. DO NOT STORE MATERIALS OR ALLOW ENCRACEMENT OF VEHICLES OR MACHINERY WITHIN TREE BARRIER AREA. NO BUILDING MATERIALS, MACHINERY OR HARMFUL CHEMICALS SHALL BE PLACED WITHIN PROTECTIVE BARRIERS, EXCEPT SHORT-DURATION PLACEMENTS OF CLEAN FILL SOIL THAT WILL NOT HARM THE TREE.
3. NO GRADE CHANGES MAY OCCUR WITHIN TREE BARRIER AREA WITHOUT APPROVAL.
4. LANDSCAPE PREPARATION IN THE PROTECTED AREA SHALL BE LIMITED TO SHALLOW DISCING OF THE AREA. DISCING SHALL BE LIMITED TO A DEPTH OF FOUR INCHES UNLESS SPECIFICALLY APPROVED OTHERWISE.
5. TREE BARRIERS TO REMAIN IN PLACE UNTIL LANDSCAPING OPERATIONS BEGIN. ONCE REMOVED, VEHICLE AND EQUIPMENT TRAFFIC AND STORAGE OF MATERIALS WITHIN AREA SHALL BE MINIMIZED AS MUCH AS POSSIBLE.



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1 SHRUB PLANTING DETAIL  
SCALE: N.T.S.

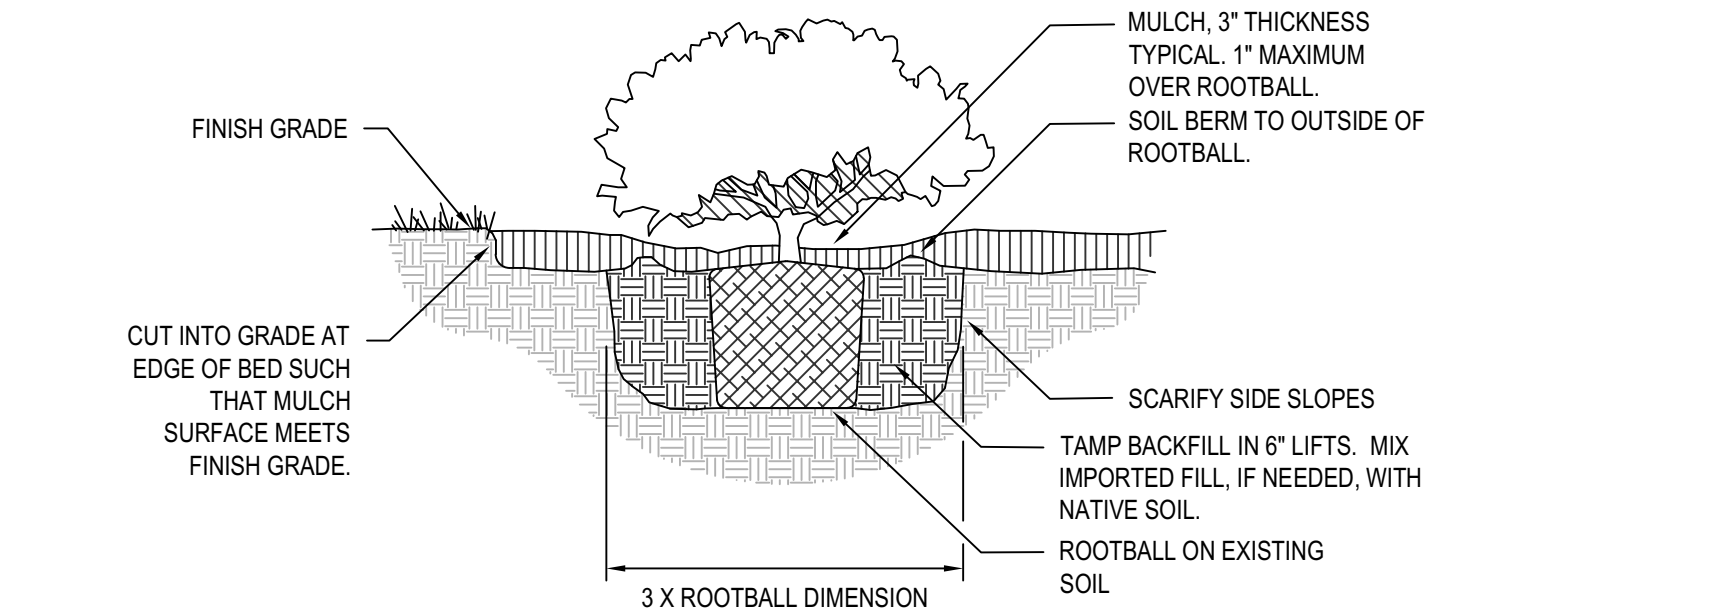

2 SHRUB LAYOUT DETAIL  
SCALE: N.T.S.

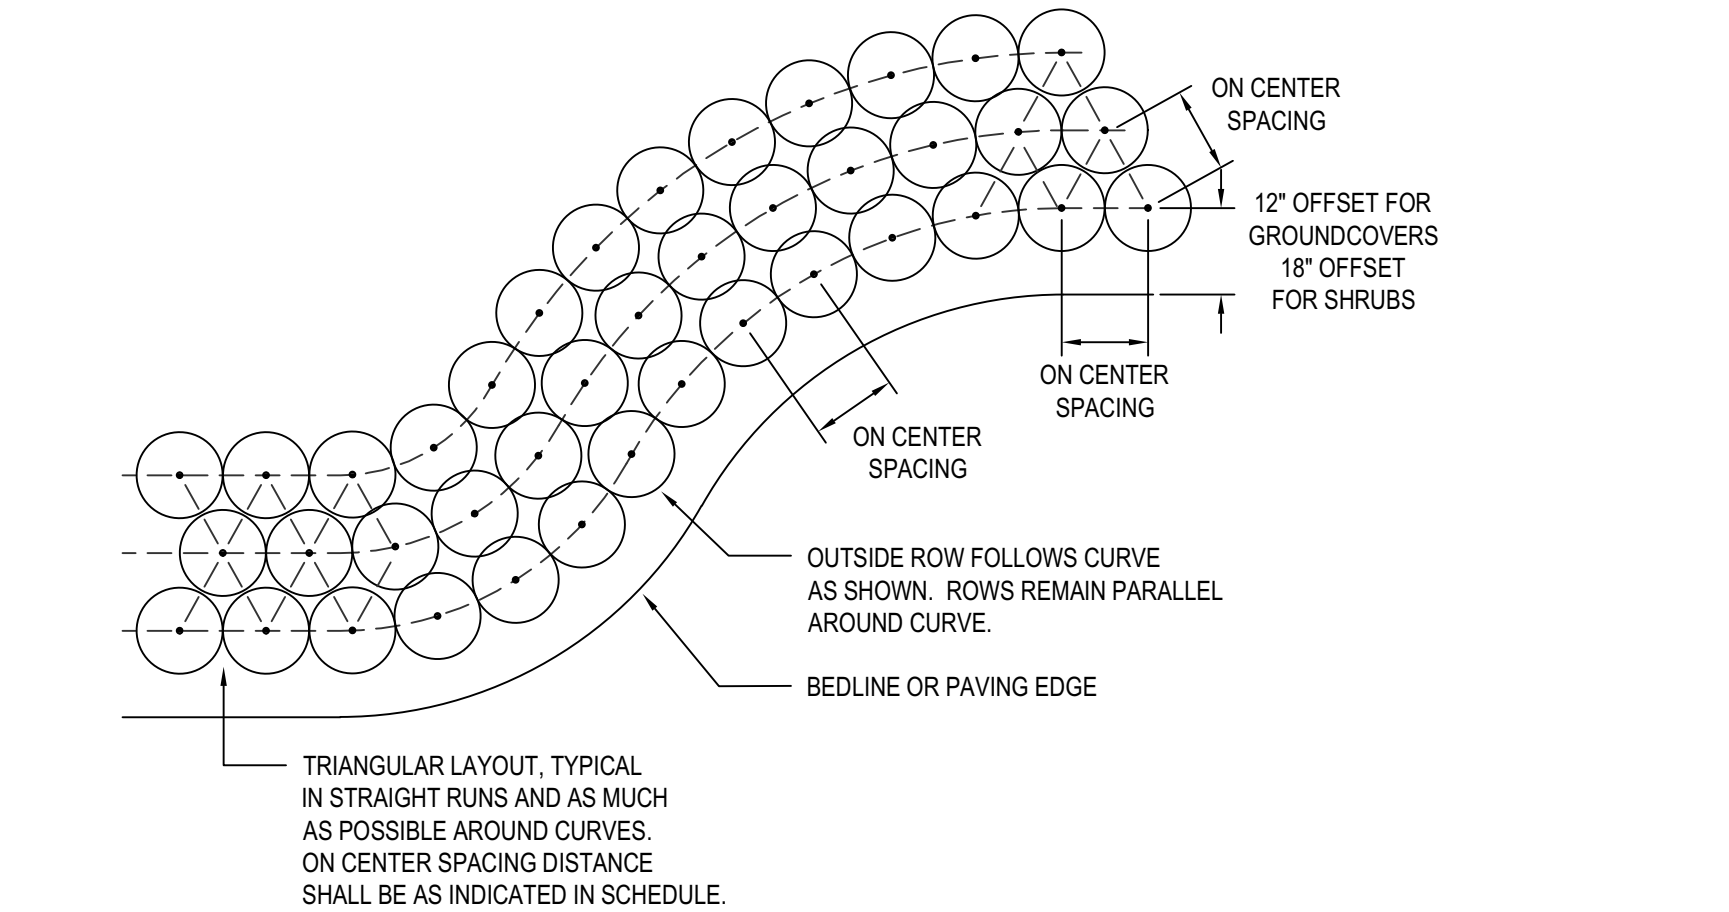CITY OF GAINESVILLE TREE MITIGATION CALCULATIONS Sec. 30-8.7 City Submittal No. 2			
CATEGORY 1 = TREE APPRAISED VALUE (T.A.V.) PAYMENT TREES			
Per Sec. 30-8.7(D) table: "High quality heritage trees, in fair or better condition requires mitigation payment based on tree appraised value, limited to three trees per acre averaged over the entire site. If more than three trees per acre in this category are located on the site then the trees with the highest tree appraised value throughout the site shall be used to calculate the payment. High quality heritage trees proposed for removal in excess of the overall average of three per acre shall require mitigation trees on an inch-for-inch on a diameter basis." Per Sec. 30-2.1 Definitions: "High quality trees means any trees of the following species: Live Oak (Quercus virginiana), Sand Live Oak (Q. geminata), Bluff Oak (Q. austrina), Basket Oak (Q. michauxii), Southern Red Oak (Q. falcata), Southern Magnolia (Magnolia grandiflora), Florida Maple (Acer barbatum), Longleaf Pine (Pinus palustris), Spruce Pine (P. glabra), Cedar Elm (Ulmus crassifolia), Winged Elm (U. alata), Florida Elm (U. floridana), Bald Cypress (Taxodium distichum), Pond Cypress (T. ascendens), Tupelo (Nyssa sylvatica), Mockernut Hickory (Carya tomentosa)/Pignut Hickory (C. glabra), Pecan (C. illinoensis), Persimmon (Diospyros virginiana), Basswood (Tilia Americana), Tulip Poplar (Liriodendron tulipifera), White Ash (Fraxinus Americana), Green Ash (F. pennsylvanica) and Yaupon, Dahoon, and American Holly species (Ilex vomitoria, I. cassine, and I. opaca).\" Note removal of trees in this category require a 'TAV' payment and cannot be addressed with proposed replacement trees.			
TOTAL SITE AREA	5.19	ACRES	
MAX. T.A.V. TREES (3 per acre per code)	16	TREES	
TOTAL TREES IN CATEGORY TO BE REMOVED & MITIGATED (Listed below)	0	TREES	
TREES BEYOND MAX. (If any, to be mitigated inch:inch - See Category 2)	0	TREE	
REMOVED APPRAISED TREES			
Tree No.	DBH/Inches	Tree Type	T.A.V.
-	-	-	-
TOTAL =		\$	-

CATEGORY 2 = INCH:INCH REPLACEMENT			
Per Sec. 30-8.7(D) table: "Heritage trees of other than high quality species, in fair or better condition, excluding laurel oaks and water oaks, requires mitigation trees on an inch-for-inch diameter basis." Per Sec. 30-2.1 Definitions: "Heritage trees means trees that are larger than 20 inches diameter breast height, except for Water Oaks (Quercus nigra), Laurel Oaks (Quercus hemispherica), Sweetgums (Liquidambar styraciflua), Loblolly Pine (Pinus taeda) and Slash Pine (Pinus elliotii), which become heritage trees only when they are larger than 30 inches diameter breast height."			
<b>Note:</b> 1. Although Laurel Oaks and Water Oaks are considered heritage size over 30" DBH, they are not mitigated within Category 2 (INCH:INCH) per Sec. 30-8.7(D) table. See Category 3 for all Laurel Oaks and Water Oak mitigation. 2. Proposed trees can serve as replacement trees to meet mitigation of this category. If mitigation remains beyond proposed tree number, then the City allows payment of \$100/remaining replacement tree.			
Tree No.	Non-High Quality Heritage Tree Removed	DBH of Tree/Inches Required	Converted to Replacement Tree (2\"/>
	N/A		0 trees
TOTAL TREES REQUIRED FOR INCH:INCH MITIGATION			0 trees

CATEGORY 3 = 2:1 REPLACEMENT	
Per Sec. 30-8.7(D) table: "Any heritage trees in less than fair or better condition; any heritage laurel oak or water oak; and any other regulated tree requires mitigation trees consisting of two trees of high quality shade species established for each tree removed." Per Sec. 30-2.1 Definitions: "Regulated trees means trees of eight inches or greater in diameter breast height or any tree that was planted in compliance with an approved development order or to mitigate the removal of a regulated tree. Slash and Loblolly Pines are not regulated until they reach 20 inches in diameter, except those that were preserved during development in order to meet a landscaping requirement, which are considered regulated regardless of size." Palms are considered a regulated tree if over 8\"/>	
NUMBER OF REGULATED TREES REMOVED (See list below)	19 trees
TOTAL TREES REQUIRED FOR MITIGATION AT 2:1 REPLACEMENT	38 trees

TOTAL ANTICIPATED TREE MITIGATION	
CATEGORY 1 = TREE APPRAISED VALUE TREE PAYMENT REQUIREMENTS	\$ - subtotal
CATEGORY 2 = INCH:INCH REPLACEMENT REQUIREMENTS	0 trees
CATEGORY 3 = 2:1 REPLACEMENT REQUIREMENTS	38 trees
TOTAL REQUIRED REPLACEMENT TREES (CAT. 2 + 3)	38 trees
NO. OF REPLACEMENT TREES PROPOSED IN DEVELOPMENT, CODE-MINIMUM	36 trees
REMAINING REQUIRED MITIGATION REPLACEMENT TREES	2 trees
REMAINING MITIGATION REPLACEMENT TREES AS PAYMENT (\$100/REPLACEMENT TREE)	\$ 200.00 subtotal
TOTAL MITIGATION BASED ON ABOVE	\$ 200.00 total *
* PAYMENT SHALL BE MADE PRIOR TO RECEIPT OF DEVELOPMENT ORDER.	



STORMWATER MANAGEMENT FACILITY LDC SEC. 30-8.6. 1 High quality shade trees per 35 linear feet (on average) of basin perimeter with minimum tree spacing of 10 feet. 25% of planting area/littoral zone shall be landscaped with shrubs, groundcovers, native perennials, or aquatic plants.			
BASIN 1			
REQUIREMENT	Perimeter (LF)	Trees Required	PROVIDED
1 HQS Tree / 35 LF Perimeter	449	12.8	12 trees + 1 existing
	Area (SF)	25% Area	
25% Littoral Area as defined by City of Gainesville in Landscape (Shrubs)	3577	894.3	1079 SF shrubs
	Area (SF)	80% Area	
80% Littoral Zone as defined by Water Management District in Landscape (Aquatics)	3577	2861.6	2965 SF aquatics

TREE SPECIES DIVERSITY LDC SEC. 30-8.3.A.6. Developments which require 16 or more shade trees shall have at least four different high quality shade tree species.	
Shade Trees Required	Species Provided
16	4

DESIGN DEVELOPMENT SUBMITTAL	05-21-24	-
90% CONSTRUCTION DOCUMENTS	07-02-24	-
SITE DEVELOPMENT REVIEW	09-06-24	-
SITE DEVELOPMENT REVIEW	12-20-24	-
SITE DEVELOPMENT REVIEW &		
BID ADDENDUM NO. 1	01-22-25	-
NOT FOR CONSTRUCTION	-	-
REVISIONS	DATE	BY
No.		



**Kimley»Horn**  
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800 SW 2ND AVENUE, SUITE 100, GAINESVILLE, FL 32601  
PHONE: 352-374-3274  
WWW.KIMLEY-HORN.COM REGISTRY NO. 35106

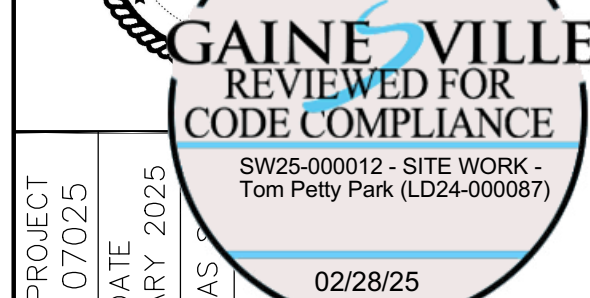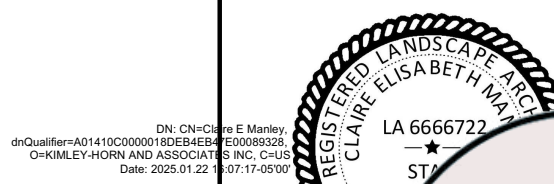

KHA PROJECT	DATE	SCALE	DESIGNED	DRAWN	CHECK
142107025	JANUARY 2025	AS SHOWN			

LANDSCAPE DETAILS AND CALCULATIONS

TOM PETTY PARK  
PICKLEBALL IMPROVEMENTS  
PREPARED FOR  
CITY OF GAINESVILLE  
WILD SPACES & PUBLIC PLACES  
FLORIDA  
GAINESVILLE

SHEET NUMBER  
**L2.03**

## PART 1 - GENERAL

- 1.2 SUBMITTALS
- A. PROVIDE TO THE OWNER'S REPRESENTATIVE FOR REVIEW AND APPROVAL PRIOR TO ANY PLANTING ACTIVITIES. SUBMITTALS SHALL INCLUDE:
1. A COPY OF CURRENT CERTIFICATE AS A CERTIFIED LANDSCAPE CONTRACTOR BY THE FLORIDA NURSERY, GROWERS, AND LANDSCAPE ASSOCIATION (FNGLA).
  2. A COPY OF CURRENT PEST CONTROL LICENSE (ROW, ORNAMENTAL AND/OR AQUATIC, IF APPROPRIATE)
  3. CERTIFICATION BY THE FLORIDA DEPARTMENT OF AGRICULTURE AND CONSUMER SERVICES AS A COMMERCIAL FERTILIZER APPLICATOR PER SE-14.117(18) F.A.C.
  4. MANUFACTURER'S LABELS OR INFORMATION FOR ANY COMPONENTS INCORPORATED INTO THIS PROJECT, INCLUDING BUT NOT LIMITED TO FERTILIZERS, PESTICIDES, AND STAKING SYSTEMS.
  5. IF IMPORTED FILL IS REQUIRED TO AUGMENT EXISTING CONDITIONS FOR PLANTING, PROVIDE IMPORTED FILL AS DESCRIBED WITHIN PRODUCTS SECTION. PROVIDE A SOIL ANALYSIS THROUGH THE UNIVERSITY OF FLORIDA EXTENSION SOIL TESTING LABORATORY FOR EACH FILL SOURCE AND INCLUDING. INCLUDE A WRITTEN REPORT CONTAINING SOIL-AMENDMENT AND FERTILIZER RECOMMENDATIONS FOR EACH SOURCE.
  6. SCHEDULE OF VALUES: PRIOR TO THE COMMENCEMENT OF THE WORK, SUBMIT INSTALLED UNIT PRICES FOR ALL PLANT MATERIALS (MULCH SHALL BE INCLUDED IN THE INSTALLED UNIT PRICING) AND SODDING. THE SCHEDULE OF VALUES SHOULD EQUAL THE TOTAL CONTRACT PRICE FOR LANDSCAPE INSTALLATION.
  7. TYPEWRITTEN INSTRUCTIONS PROVIDING A MAINTENANCE SCHEDULE AND ALL MAINTENANCE OPERATIONS NECESSARY TO MAINTAIN THE PLANTINGS DURING AND FOLLOWING INSTALLATION, AS SPECIFIED BELOW.
  8. WRITTEN WARRANTIES AS SPECIFIED BELOW.
  9. RECORD DRAWINGS: FURNISH ONE SET OF RECORD DRAWINGS THAT CLEARLY SHOW ALL CHANGES MADE TO THE ORIGINAL CONTRACT DRAWINGS DURING THE COURSE OF THE WORK. DRAWINGS SHALL BE PROVIDED IN PDF FILE FORMAT AND TO BE FULLY LEGIBLE AND TO SCALE.

### 1.3 QUALITY CONTROL

- A. ALL WORK SHALL BE PERFORMED BY A FLGIA CERTIFIED LANDSCAPE CONTRACTOR (FLC) WHO HAS COMPLETED LANDSCAPE WORK SIMILAR IN SCOPE, MATERIAL, DESIGN, AND EXTENT TO THAT AS IDENTIFIED FOR THIS PROJECT AND WITH A RECORD OF SUCCESSFUL TREES AND SHRUB ESTABLISHMENT. THE LANDSCAPE CONTRACTOR SHALL MAINTAIN FLC CERTIFICATION UNDER FLGIA.
  - B. PRUNING AND TRIMMING, IF REQUIRED, SHALL BE PERFORMED BY A CERTIFIED ARBORIST, AS CERTIFIED BY THE INTERNATIONAL SOCIETY OF ARBORICULTURE (ISA).
  - C. ALL PLANT MATERIAL TO COMPLY WITH "FLORIDA #1" GRADE QUALITY STANDARD AS DEFINED AND SPECIFIED WITHIN THE LATEST EDITION OF THE "FLORIDA GRADES AND STANDARDS FOR NURSERY PLANTS" PUBLISHED BY THE FLORIDA DEPARTMENT OF AGRICULTURE AND CONSUMER SERVICES, DIVISION OF PLANT INDUSTRIES. PROVIDE HEALTHY, VIGOROUS STOCK GROWN IN A RECOGNIZED NURSERY IN ACCORDANCE WITH GOOD HORTICULTURAL PRACTICES AND FREE OF DISEASE, INSECTS, EGGS, LARVAE, AND DEFECTS SUCH AS KNOTS, SUN-SCALED, INJURIES, ABRASIONS, OR DISFIGUREMENT.
  - D. UNSATISFACTORY OR DEFECTIVE MATERIAL MAY BE REJECTED AT ANY TIME, AND REJECTED MATERIAL SHALL BE REMOVED IMMEDIATELY FROM THE PROJECT SITE.
  - E. CONTRACTOR SHALL MAINTAIN AND EXPERIENCED, FULL-TIME SUPERVISOR ON THE PROJECT SITE DURING ALL PLANTING ACTIVITIES.
  - F. SUBSTITUTIONS WILL NOT BE ACCEPTED UNLESS PROOF OF NON-AVAILABILITY OR EVIDENCE OF "EQUAL" STATUS IS DEMONSTRATED PRIOR TO ORDERING AND/OR INSTALLATION. CONTRACTOR TO SUBMIT A SUBSTITUTION REQUEST TO THE OWNER'S REPRESENTATIVE FOR REVIEW AND APPROVAL PRIOR TO ORDERING, DELIVERY, OR INSTALLATION OF MATERIAL. THE SUBSTITUTION REQUEST SHALL IDENTIFY THE ISSUE WITH THE SPECIFIED MATERIAL AND PROPOSE ALTERNATIVE, EQUIV. MATERIAL(S). INFORMATION TO BE PROVIDED REGARDING ALTERNATIVE MATERIALS SHALL INCLUDE SCIENTIFIC NAME, COMMON NAME, SIZE, AND SOURCE.
  - G. PACKAGE STANDARD PRODUCTS WITH MANUFACTURER'S CERTIFIED ANALYSIS OR ANALYSIS BY RECOGNIZED LABORATORY.
- 1.4 CONTRACTOR REQUIREMENTS
- A. PROVIDE ALL EQUIPMENT, MATERIALS AND LABOR NECESSARY FOR COMPLETION OF WORK AND MAINTENANCE.
  - B. OBTAIN ALL NECESSARY PERMITS, LICENSES, AND NOTIFICATIONS AND PAY FEES NECESSARY FOR COMPLETION OF THE WORK.
  - C. COMPLY WITH ALL APPLICABLE CODES.
  - D. COORDINATE WITH OTHER TRADES WORKING ON THE PROJECT DURING PLANTING ACTIVITIES.
  - E. COORDINATION SHALL OCCUR WITH OTHER CONTRACTORS OR PROJECTS OCCURRING OFF SITE IF NECESSARY.
  - F. IDENTIFY AND VERIFY THE LOCATION OF ALL UTILITIES WITHIN PROPOSED PLANTING AREAS. CONTRACTOR TO CONTACT SUNSHINE STATE ONE CALL OF FLORIDA, INC. AS REQUIRED BY CHAPTER 556 OF FLORIDA STATUTES PRIOR TO ANY EXCAVATION OR PLANTING ACTIVITIES.
  - G. PROVIDE SCAFF. STORAGE FOR ALL EQUIPMENT AND MATERIALS. STORAGE OF SUCH ITEMS IS AT THE CONTRACTOR'S RISK.
  - H. REPAIR, AT NO COST TO THE OWNER, ANY DAMAGE OCCURRING DUE TO CONTRACTOR NEGLIGENCE TO EXISTING UTILITIES, STRUCTURES, FURNISHINGS, HARDSCAPE, LANDSCAPE, OR OTHER ELEMENTS TO REMAIN. ANY DAMAGED WORK SHALL BE REPAIRED AS PER PLANS, OTHER SPECIFICATIONS SECTIONS, OR AS INSTRUCTED BY THE OWNER'S REPRESENTATIVE.
  - I. MAINTENANCE DURING INSTALLATION AND UNTIL FINAL ACCEPTANCE.

## 1.5 WARRANTY

- A. EXISTING LANDSCAPE AND VEGETATION
1. ALL EXISTING LANDSCAPE AND TURF TO REMAIN SHALL BE PROTECTED DURING CONSTRUCTION ACTIVITIES.
- B. NEW PLANTS
1. WARRANTY SHRUBS AND GROUNDCOVER FOR A PERIOD OF TWELVE (12) MONTHS AFTER DATE OF SUBSTANTIAL COMPLETION AGAINST DEFECTS INCLUDING DEATH AND UNSATISFACTORY GROWTH, EXCEPT FOR THAT WHICH IS A RESULT OF NEGLIGENCE BY OWNER, ABUSE, DAMAGE BY OTHERS, OR UNUSUAL PHENOMENA OR INCIDENTS WHICH ARE BEYOND THE CONTRACTOR'S CONTROL.
2. REMOVE AND REPLACE ANY LANDSCAPE MATERIAL FOUND TO BE DEAD OR IN UNHEALTHY CONDITION DURING WARRANTY PERIOD.
- B. NEW SOG
1. WARRANTY ALL GRASS FOR A PERIOD OF SIX (6) MONTHS AFTER SUBSTANTIAL COMPLETION AGAINST DEFECTS INCLUDING DEATH AND UNSATISFACTORY GROWTH, AS DETERMINED BY THE OWNER'S REPRESENTATIVE, EXCEPT FOR DEFECTS RESULTING FROM NEGLIGENCE BY THE OWNER, ABUSE OR DAMAGE BY OTHERS, OR THE UNUSUAL PHENOMENA OR INCIDENTS, WHICH ARE BEYOND THE CONTRACTOR'S CONTROL.
2. REMOVE AND REPLACE ALL TURF FOUND TO BE DEAD OR IN AN UNHEALTHY CONDITION DURING WARRANTY PERIOD AS DETERMINED BY THE OWNER'S REPRESENTATIVE.
- C. REPAIR GRADES, LAWN AREAS, PAVING, AND ANY OTHER DAMAGE RESULTING FROM REPLACEMENT PLANTING OPERATIONS, AT NO ADDITIONAL COST TO OWNER.
- D. IF ANY PLANTS ARE REPLACED DURING THE WARRANTY PERIOD, THEN THE REPLACEMENT MATERIAL SHALL ALSO BE WARRANTED FOR THE SAME PERIOD AS LISTED FOR NEW MATERIAL. ABOVE, FROM THE DATE OF REPLACEMENT. ONLY ONE REPLACEMENT WILL BE REQUIRED EXCEPT FOR LOSSES OR REPLACEMENTS DUE TO FAILURE TO COMPLY WITH SPECIFIED REQUIREMENTS.
- E. A FINAL INSPECTION MAY BE MADE AT THE END OF THE WARRANTY PERIOD TO DETERMINE ACCEPTANCE OR REJECTION. THE CONTRACTOR SHALL BE RESPONSIBLE FOR NOTIFYING THE OWNER, IN WRITING, THIRTY (30) DAYS PRIOR TO THE END OF THE WARRANTY PERIOD, AT WHICH TIME THE OWNER HAS THE OPTION TO PERFORM AN END OF WARRANTY INSPECTION. FAILURE TO NOTIFY THE OWNER OF THE END DATE OF THE WARRANTY PERIOD SHALL CAUSE THE WARRANTY PERIOD TO EXTEND UNTIL SUCH TIME AS THE CONTRACTOR GIVES THE OWNER THE REQUIRED 30 DAYS' NOTICE.

## 1.6 DELIVERY, STORAGE, AND HANDLING

- A. PACKAGED MATERIALS: DELIVER PACKAGED MATERIALS IN CONTAINERS SHOWING WEIGHT, CERTIFIED ANALYSIS, AND NAME OF MANUFACTURER. PROTECT MATERIALS FROM DETERIORATION DURING DELIVERY AND WHILE STORED AT SITE.
- B. SOD: TIME DELIVERY SO THAT SOD WILL BE PLACED WITHIN 24 HOURS AFTER STRIPPING. PROTECT SOD AGAINST DRYING AND BREAKING OF ROLLED STRIPS.
- C. PLANTS: DO NOT PRUNE PRIOR TO DELIVERY UNLESS OTHERWISE APPROVED BY THE OWNER'S REPRESENTATIVE. DO NOT BEND OR BIND-TIE SHRUBS IN SUCH A MANNER AS TO DAMAGE BARK, BREAK BRANCHES, OR DESTROY NATURAL SHAPE. PROVIDE PROTECTIVE COVERING DURING DELIVERY. DELIVER PLANTS AFTER PREPARATIONS FOR PLANTING HAVE BEEN COMPLETED AND PLANT IMMEDIATELY. IF PLANTING IS DELAYED MORE THAN SIX (6) HOURS AFTER DELIVERY, SET PLANTS IN SHADE. PROTECT FROM WEATHER AND MECHANICAL DAMAGE, AND KEEP ROOTS MOIST BY COVERING WITH MULCH, BURLAP OR OTHER ACCEPTABLE MEANS OF RETAINING MOISTURE. DO NOT REMOVE CONTAINER-GROWN STOCK FROM CONTAINERS UNTIL PLANTING TIME. HANDLE PLANT MATERIALS BY ROOTBALL.

## PART 1 - GENERAL, CON'T

## 1.7 PROJECT CONDITIONS

- A. COORDINATE AND COOPERATE WITH OTHER TRADES TO ENABLE WORK TO PROCEED AS RAPIDLY AND EFFICIENTLY AS POSSIBLE.
- B. IF WEATHER CONDITIONS DETRIMENTAL TO PLANTING ARE ENCOUNTERED OR ANTICIPATED, NOTIFY THE OWNER'S REPRESENTATIVE OR OWNER'S REPRESENTATIVE PRIOR TO PLANTING. PLANTING SHALL NOT OCCUR DURING PERIODS OF OR WITHIN 48 HOURS OF PREDICTED TEMPERATURES LESS THAN 32 F.
- C. WHEN CONDITIONS DETRIMENTAL TO PLANT GROWTH ARE ENCOUNTERED OR ANTICIPATED, INCLUDING BUT NOT LIMITED TO LIMESTONE, ROAD BASE, RUBBLE FILL, ADVERSE DRAINAGE CONDITIONS, OBSTRUCTIONS, OR TOXIC MATERIALS, NOTIFY THE OWNER'S REPRESENTATIVE OR OWNER'S REPRESENTATIVE PRIOR TO PLANTING.
- D. MAINTAIN GRADE STAKES SET BY OTHERS UNTIL REMOVAL IS MUTUALLY AGREED UPON BY PARTIES CONCERNED.
- E. DETERMINE LOCATION OF UNDERGROUND UTILITIES PRIOR TO COMMENCEMENT OF WORK. CALL SUNSHINE STATE ONE CALL, 811. PERFORM WORK IN A MANNER THAT AVOIDS POSSIBLE DAMAGE. HAND EXCAVATE AS REQUIRED.

## PART 2 - PRODUCTS

## 2.1 FILL

- A. IF REQUIRED TO AUGMENT EXISTING SOILS FOR LANDSCAPE AND TURF INSTALLATION, PROVIDE NEW, DEEP FILL MATERIAL AS PER USDA STANDARD TEXTURES AND THAT IS TAKEN FROM WELL-DRAINING LOCAL SOURCES WITH SIMILAR SOIL TYPES AS FOUND AT THE PROJECT SITE.
- B. FILL TO BE SUITABLE FOR PLANT GROWTH, FRIABLE, AND FREE OF CLAY LUMPS, BRUSH, WEEDS, SEEDS, ROOTS, STUMPS, STONES, ORGANIC MUCK, HARD PAN CLAY, LITTER AND CONSTRUCTION DEBRIS INCLUDING LIMEROCK OR PAVING BASE MATERIAL, ASPHALT, AND CONCRETE, AND OTHER EXTRANEEOUS OR TOXIC MATTER HARMFUL TO PLANT GROWTH
- C. FILL TO BE OF PH 5-6.5.
- 2.2 MULCH
- A. MULCH SHALL BE AS INDICATED IN NOTES OR THE PLANT SCHEDULE AND TO BE FREE OF BRANCHES, CONES, AND DEBRIS.
- 2.3 COMMERCIAL FERTILIZER

#### A. FERTILIZER TYPE AND

- A. **LDR ARTICLE IV, REQUIREMENTS.** DO NOT APPLY FERTILIZER FROM JULY - FEBRUARY. APPLY FERTILIZER EITHER DURING THE PROJECTS INSTALLATION OR DURING THE ESTABLISHMENT PERIOD, DEPENDING ON WHICH IS POSSIBLE RELATIVE TO THIS TIME FRAME. IF IT IS ANTICIPATED THAT THE PROJECT WILL BE COMPLETED OUTSIDE OF THE SPECIFIED FERTILIZING WINDOW AND THAT FERTILIZING WON'T BE POSSIBLE, DISCUSS WITH THE OWNER'S REPRESENTATIVE PRIOR TO INSTALLATION.
- B. FERTILIZER MAY ONLY BE APPLIED WITHIN 10 FT. FROM ANY WETLAND OR BODY OF WATER FOR A PERIOD OF 90 DAYS FOLLOWING PLANTING. FOLLOWING THAT TIME PERIOD, FERTILIZING IN THIS AREA IS NOT ALLOWED.
- C. FERTILIZERS APPLIED TO TURF AND/OR LANDSCAPE PLANTS SHALL BE FORMULATED AND APPLIED IN ACCORDANCE WITH DIRECTIONS PROVIDED BY RULE SE-1.003, FLORIDA ADMINISTRATIVE CODE, LABELING REQUIREMENTS FOR URBAN TURF FERTILIZERS.
- D. C.1. NITROGEN OR PHOSPHORUS FERTILIZER SHALL NOT BE APPLIED TO TURF OR LANDSCAPE PLANTS EXCEPT AS ALLOWED BY THIS RULE OR IF WITHIN UFIFAS RECOMMENDATIONS FOR LANDSCAPE PLANTS, VEGETABLE GARDENS, AND FRUIT TREES AND SHRUBS, UNLESS A SOIL OR TISSUE DEFICIENCY HAS BEEN VERIFIED BY AN APPROVED TEST.
- D. C.2. NO FERTILIZER CONTAINING PHOSPHORUS SHALL BE APPLIED TO TURF, SOD, LAWNS, OR LANDSCAPE PLANTS UNLESS A SOIL OR PLANT TISSUE DEFICIENCY IS VERIFIED BY A TESTING METHODOLOGY APPROVED BY THE UNIVERSITY OF FLORIDA, INSTITUTE OF FOOD AND AGRICULTURAL SCIENCES. IF A DEFICIENCY IS VERIFIED, THE APPLICATION OF FERTILIZER CONTAINING PHOSPHORUS MUST ADHERE TO THE RATES AND DIRECTION FOR THE APPROPRIATE REGION OF FLORIDA, AS ADOPTED BY THE FLORIDA ADMINISTRATIVE CODE RULE.
- D. C.3. FERTILIZERS CONTAINING NITROGEN APPLIED TO TURF OR LANDSCAPING PLANTS MUST CONTAIN NO LESS THAN 50 PERCENT SLOW RELEASE NITROGEN PER GUARANTEED ANALYSIS LABEL.
- E. SHRUBS AND GROUNDCOVERS: IF PERMISSIBLE BY SECTION C. ABOVE, UTILIZE A ROOT STARTER OR EQUIVALENT SLOW RELEASE FERTILIZER TO ENCOURAGE ROOT GROWTH. APPLY AT MANUFACTURER'S RECOMMENDED RATE. ROOT STARTER SHALL BE A COMPLETE, SLOW RELEASE FERTILIZER WITH ORGANIC NITROGEN AND CONTAIN THE FOLLOWING PERCENTAGES OF AVAILABLE PLANT NUTRIENTS:
- D.1. BETWEEN 5-8% TOTAL NITROGEN (N) CONSISTING OF 3.5-4.5% WATER INSOLUBLE/SLOW RELEASE NITROGEN AND 1.5% WATER SOLUBLE NITROGEN
- D.2. BETWEEN 1-2% PHOSPHATE (P2O5)
- D.3. BETWEEN 0.5-3% POTASH/POTASSIUM (K)
- F. TURF: IF PERMISSIBLE BY SECTION C. ABOVE, PROVIDE FERTILIZER WITH NO LESS THAN SIXTEEN (16) PERCENT TOTAL NITROGEN, FOUR (4) PERCENT AVAILABLE PHOSPHORIC ACID AND EIGHT (8) PERCENT SOLUBLE POTASH. APPLY AT MANUFACTURER'S RECOMMENDED RATE.

## 2.4 PLANT MATERIALS

- A. PROVIDE SHRUBS AND GROUNDCOVERS OF SIZE, GENUS, SPECIES, AND VARIETY AS SHOWN IN THE PLANT SCHEDULE FOR LANDSCAPE WORK THAT CONFORM TO FLORIDA NO. 1 QUALITY STANDARDS.
- B. PROVIDE HEALTHY, VIGOROUS STOCK GROWN IN A RECOGNIZED NURSERY IN ACCORDANCE WITH GOOD HORTICULTURAL PRACTICES AND FREE OF DISEASE, INSECTS, EGGS, LARVAE, AND DEFECTS SUCH AS KNOTS, SUN-SCALD, INJURIES, ABRASIONS, OR DISFIGUREMENT.
- C. LANDSCAPE MATERIAL SHALL BE CONTAINER GROWN MATERIAL UNLESS OTHERWISE SPECIFIED OR UNLESS APPROVED BY THE OWNER'S REPRESENTATIVE.
- 2.5 SOD
- A. PROVIDE SAND-GROWN ONLY, STRONGLY ROOTED SOD, NOT LESS THAN TWO YEARS OLD, FREE OF WEEDS AND UNDESIRABLE NATIVE GRASSES, AND MACHINE CUT TO PAD THICKNESS OF 3/4 INCH (PLUS OR MINUS 1/4 INCH), EXCLUDING TOP GROWTH AND THATCH. PROVIDE ONLY SOD CAPABLE OF VIGOROUS GROWTH AND DEVELOPMENT WHEN PLANTED. SOD SHALL BE VIABLE AND NOT DORMANT.
- B. PROVIDE SOD OF UNIFORM PAD SIZES WITH A MAXIMUM 5% DEVIATION IN EITHER LENGTH OR WIDTH. BROKEN PADS OR PADS WITH UNEVEN ENDS WILL NOT BE ACCEPTABLE. SOD PADS INCAPABLE OF SUPPORTING THEIR OWN WEIGHT WHEN SUSPENDED VERTICALLY WITH A FIRM GRASP ON UPPER 10 PERCENT OF PAD WILL BE REJECTED.
- C. STABILIZING NETTING OR OTHER SYNTHETIC MATERIALS WITHIN SOD SHALL BE PROHIBITED.
- D. SOD TO BE AS LISTED WITHIN THE PLANT SCHEDULE.
- E. REFER TO CIVIL PLANS FOR SOD TYPE AND INSTALLATION METHODS WITHIN STORMWATER FACILITIES.
- 2.6 WEED PRE-EMERGENT HERBICIDE
- A. IF APPROVED BY OWNER, APPLY 'RON STAR G' PRE-EMERGENT HERBICIDE, OR APPROVED EQUAL IN PLANTING AREAS.

### PART 3 - EXECUTION

### 3.1 PREPARATION

- A. CONDUCT A PRE-CONSTRUCTION CONFERENCE ON SITE WITH THE OWNER'S REPRESENTATIVE PRIOR TO COMMENCEMENT OF WORK. DISCUSS PROPOSED ACTIVITIES, REVIEW PROPOSED PLANTING AREAS, AND CONFIRM PROPOSED SCHEDULE OF WORK. PROVIDE ONE WEEK'S NOTICE OF PROPOSED CONFERENCE.
- B. ENSURE ALL ASPHALT, LIMEROCK, AND OTHER CONSTRUCTION DEBRIS ARE REMOVED FROM AREAS OF PROPOSED PLANTING OR SODDING TO A MINIMUM DEPTH OF THREE FEET PRIOR TO INSTALLATION.
- C. CLEAN EXISTING SOIL OF ROOTS, PLANTS, SODS, STONES, CLAY, LUMPS AND OTHER EXTRANEOUS MATERIALS HARMFUL OR TOXIC TO PLANT GROWTH.
- D. PLANTING DEPTH OF SOIL SHALL BE A MINIMUM OF THREE (3) FEET. IF FILL MUST BE ADDED, IT SHALL CONFORM TO THE REQUIREMENTS LISTED ABOVE.
- E. PLANTING AREAS SHALL NOT BE COMPACTED.
- F. PLANTING AREAS SHALL BE WELL-DRAINING. IF SATURATED OR WET CONDITIONS EXIST IN PROPOSED PLANTING AREAS OR WITHIN PLANTING HOLES, DO NOT PLANT MATERIAL AND CONTACT LANDSCAPE ARCHITECT FOR DIRECTION.
- G. GAIN APPROVAL FROM OWNER PRIOR TO WORK FOR REMOVAL OF EXISTING GRASS, VEGETATION, AND TURF BY METHODS OTHER THAN HAND REMOVAL. IF APPROVED, SPRAY AREAS WITH "ROUND-UP" OR OTHER APPROPRIATE HERBICIDE AND PERFORM ADDITIONAL SPRAY TREATMENTS AS NEEDED TO ENSURE A COMPLETE KILL. REMOVE AND DISPOSE OF RESULTING DEAD VEGETATION AND TURF. DO NOT TURN RESULTING DEAD VEGETATION OR TURF OVER INTO SOIL. REPEAT IF NECESSARY TO REMOVE EXISTING VEGETATION.
- H. FOR TURF AREAS INDICATED FOR RENOVATION, MECHANICALLY CUT OUT AREAS OF FAILING TURF AND CREATE A CLEAN EDGE FOR NEW SOD INSTALLATION.
- I. FINE GRADE PROPOSED PLANTING AND SOD AREAS TO SMOOTH, EVEN SURFACES WITH LOOSE, UNIFORMLY FINE TEXTURE AND FREE OF LUMPS, CLODS, STONES, ROOTS, AND OTHER EXTRANEOUS MATTER. ROLL, RAKE, AND DRAG AREAS, REMOVE RIDGES, AND FILL DEPRESSIONS AS REQUIRED TO MEET FINISH GRADES.
- J. ALLOW FOR SOD THICKNESS IN AREAS TO BE SODDED SUCH THAT INSTALLED SOD MEETS FINISHED GRADES.

## PART 3 - EXECUTION, CON'T

### 3.2 TREE BARRIERS AND EXISTING TREE PROTECTION

- |      |   |  |  |  |  |
|------|---|--|--|--|--|
| A.   | REFER TO NOTES ON DEMOLITION PLANS OR LANDSCAPE PLANS REGARDING TREE PROTECTION AND TREE PROTECTION BARRIERS.   |  |  |  |  |
| B.   | MINIMIZE IMPACTS ON EXISTING TREE ROOTS AS MUCH AS POSSIBLE. AVOID TREE ROOT PLANT AREAS AS DEFINED BY PERMITTING AGENCIES.   |  |  |  |  |
| C.   | ALL ROOTS OF TREES TO REMAIN THAT ARE IMMEDIATELY ADJACENT TO EXTENSIVE EXCAVATION AND ARE 1" DIAMETER OR OVER SHALL BE HAND CUT. EXPOSE ROOTS BY HAND DIGGING, HAND CUT OR SAW CLEANLY, AND IMMEDIATELY COVER WITH SOIL. DO NOT ALLOW CUT ROOTS TO DRY OUT.  |  |  |  |  |
| D.   | SUPPLEMENTAL IRRIGATION IS REQUIRED FOR TREES THAT HAVE UNDERGONE ROOT PRUNING. PROVIDE SUPPLEMENTAL IRRIGATION IMMEDIATELY FOLLOWING PRUNING AND CONTINUE THROUGH CONSTRUCTION.  |  |  |  |  |
| 3.3. | PLANTING  |  |  |  |  |
| A.   | PLANT TREES, SHRUBS, AND GROUNDCOVER AFTER FINAL GRADES ARE ESTABLISHED AND PRIOR TO PLANTING OF LAWNS UNLESS OTHERWISE AUTHORIZED BY OWNER'S REPRESENTATIVE. IF PLANTING OF TREES AND SHRUBS OCCURS AFTER INSTALLATION OF LAWNS, PROTECT LAWN AREAS AND PROMPTLY REPAIR DAMAGE CAUSED BY LANDSCAPE INSTALLATION.   |  |  |  |  |
| B.   | LAY OUT INDIVIDUAL PLANT LOCATIONS AND AREAS FOR MULTIPLE PLANTINGS. TRIANGLE SPACING SHALL BE USED FOR SHRUBS AND GROUNDCOVERS UNLESS OTHERWISE SPECIFIED IN PLANS OR BY OWNER'S REPRESENTATIVE. OUTLINE AREAS AND SECURE OWNER'S REPRESENTATIVE'S OR OWNER REPRESENTATIVE'S ACCEPTANCE BEFORE START OF PLANTING WORK. MAKE MINOR ADJUSTMENTS AS MAY BE REQUIRED.                          |  |  |  |  |
| C.   | EXCAVATE PITS, BEDS, AND TRENCHES SUCH THAT PITS ARE AS DEEP AS THE PLANT'S ROOTBALL AND 1.5 TIMES THE DIAMETER OF THE ROOTBALL. LOOSEN HARD SUBSTR, IN BOTTOM OF EXCAVATION. SCARIFY SIDES OF PIT.   |  |  |  |  |
| D.   | FILL EXCAVATIONS FOR SHRUBS WITH WATER AND ALLOW WATER TO PERCOLATE OUT PRIOR TO PLANTING. NOTIFY OWNERS REPRESENTATIVE OR OWNERS REPRESENTATIVE PRIOR TO PLANTING IF PITS DO NOT DRAIN PRIOR TO PLANTING.  |  |  |  |  |
| E.   | REMOVE PLANT MATERIAL FROM CONTAINER. LIFT TREES AND SHRUBS BY THE ROOTBALL AND NOT BY THE TRUNK OR MAIN STEM. SET PLANT MATERIAL, STOCK IN CONTAINER OF PIT OR TRENCH WITH TOP OF BALL AT 1'-2" ABOVE ADJACENT FINISH LANDSCAPE GRADES.  |  |  |  |  |
| F.   | REMOVE ANY SYNTHETIC OR STRAPPING MATERIAL PRIOR TO SETTING PLANT MATERIAL INTO PLANTING PIT OR TRENCH.   |  |  |  |  |
| G.   | ENSURE PLANT MATERIAL IS PLUMB.   |  |  |  |  |
| H.   | PLACE BACKFILL AROUND BASE AND SIDES OF BALL AND WORK IN EACH LAYER TO SETTLE BACKFILL AND ELIMINATE VOIDS AND AIR POCKETS. ENSURE ROOTBALL REMAINS 1-2" ABOVE ADJACENT FINISH GRADE. WHEN EXCAVATION IS APPROXIMATELY 2/3 FULL, WATER THOROUGHLY BEFORE PLACING REMAINDER OF BACKFILL. REPEAT WATERING UNTIL NO MORE WATER IS ABSORBED. WATER AGAIN AFTER PLACING FINAL LAYER OF BACKFILL. |  |  |  |  |
| I.   | DISH TOP OF BACKFILL FOR TREES AND PALMS TO ALLOW FOR MULCHING.   |  |  |  |  |

## J. ALL PLANT MATER

- WINDOW PER COUNTY CODE. MIX OR APPLY FERTILIZER ON TOP OF ROOTBALL AND NOT UNDER OR WITHIN PLANTING PITS. APPLY JUST INSIDE OF PLANT POLYAGGREGATE AND NOT DIRECTLY ON STEMS OR EXPOSED ROOTS OF MATERIAL. MIX SPECIFIED FERTILIZERS WITH HOT WATER TO PREPARE SLURRY BY THE MANUFACTURER. DELAY MIXING OF FERTILIZER IF PLANTING WILL NOT FOLLOW PLACING OF PLANTING SOIL WITHIN THREE (3) DAYS. DO NOT APPLY OR SPILL FERTILIZER ON IMPERVIOUS SURFACES- IMMEDIATELY CLEAN OFF AND/OR CONTAIN IF SO. DO NOT WASH, SWEEP, OR BLOW OFF EXCESS OR SPILLED FERTILIZER INTO DRAINS, STORMWATER DITCHES OR PONDS, OR OTHER WATER BODIES OR CONVEYANCE SYSTEMS.
- K. APPLY PRE-EMERGENT HERBICIDE, IF APPROVED BY OWNER, AND AS PER MANUFACTURER'S SPECIFICATIONS.
- L. MULCH PITS, TRENCHES, AND PLANTED AREAS. PROVIDE A THREE (3) INCH THICKNESS OF MULCH AND WOOD ON TOP OF BACKFILL. THE FINISH LEVEL OF MULCH SHOULD MEET ADJACENT FINISH GRADES. MULCH AREAS BETWEEN GROUND COVER PLANTS.
- M. WATER THOROUGHLY AFTER PLANTING, TAKING CARE NOT TO COVER CROWNS OF PLANTS WITH WET SOILS.
- N. GUY AND STAKE TREES AND PALMS IMMEDIATELY AFTER PLANTING AS NEEDED.
- 3.4. SODDING NEW LAWNS
- A. ENSURE GRADE IS SMOOTH AND EVEN WITH A LOOSE, UNIFORM TEXTURE. ROLL, RAKE AND DRAG PROPOSED LAWN AREAS, REMOVE RIDGES, AND FILL DEPRESSIONS AS REQUIRED TO MEET FINISH GRADES AND PROVIDE AN EVEN SURFACE FOR SOD INSTALLATION.
- B. LAY SOD WITHIN 24 HOURS FROM TIME OF STRIPPING.
- C. MOISTEN PREPARED LAWN AREAS BEFORE PLANTING IF SOIL IS DRY. WATER THOROUGHLY AND ALLOW SURFACE MOISTURE TO DRY BEFORE PLANTING LAWNS. DO NOT CREATE A MUDDY SOIL CONDITION.
- D. APPLY SPECIFIED COMMERCIAL FERTILIZER IF WITHIN THE ALLOWABLE FERTILIZING TIME WINDOW PER COUNTY CODE. APPLY AT RATES SPECIFIED AND THOROUGHLY MIX INTO UPPER TWO INCHES OF SOIL IN AREAS OF PROPOSED SOD. DELAY APPLICATION OF FERTILIZER IF LAWN PLANTING WILL NOT FOLLOW WITHIN A FEW DAYS. SPRINGER DEFLECTOR SHIELDS ARE REQUIRED WHEN FERTILIZING VIA ROTARY/BROADCAST SPREADERS. DO NOT APPLY OR SPILL FERTILIZER ON IMPERVIOUS SURFACES- IMMEDIATELY CLEAN OFF AND/OR CONTAIN IF SO. DO NOT WASH, SWEEP, OR BLOW OFF EXCESS OR SPILLED FERTILIZER INTO DRAINS, STORMWATER DITCHES OR PONDS, OR OTHER WATER BODIES OR CONVEYANCE SYSTEMS.
- E. LAY SOD TO FORM A SOLID MASS WITH TIGHTLY FITTED JOINTS. BUTT ENDS AND SIDES OF SOD STRIPS. DO NOT OVERLAP. STAGGER STRIPS TO OFFSET JOINTS IN ADJACENT COURSES. TAP SOD FIRMLY IN PLACE ONCE LAID.
- F. ANCHOR SOD ON SLOPES GREATER THAN 3:1 WITH WOOD PEGS TO PREVENT SLIDING, IF NEEDED.
- G. AVOID DAMAGE TO SUBGRADE OR SOD DUE TO INSTALLATION ACTIVITIES.
- H. WATER SOD THOROUGHLY WITH A FINE SPRAY IMMEDIATELY AFTER PLANTING.

### 3.5 CLEANUP

- A. MAINTAIN WORK AREAS IN AN ORDERLY CONDITION. KEEP PAVEMENTS AND ADJACENT SITE AREAS CLEAN. REMOVE ALL POTS, LITTER, TOOLS, EQUIPMENT, AND EXTRANEOUS SOIL, SOD, OR MATERIALS AT THE END OF EACH WORK DAY. STORE MATERIALS AND EQUIPMENT WHERE DIRECTED. DISPOSE OF MATERIALS AS DIRECTED.

### 3.6 NEW PLANT PROTECTION

- A. PROTECT LANDSCAPE WORK AND MATERIALS FROM DAMAGE DURING CONSTRUCTION. MAINTAIN PROTECTION DURING INSTALLATION AND THROUGHOUT THE MAINTENANCE PERIOD. TREAT, REPAIR, OR REPLACE DAMAGED LANDSCAPE WORK AS DIRECTED.
- B. TREES WHICH ARE TO REMAIN IN THE CONSTRUCTION AREA SHALL BE PROTECTED FROM DAMAGE THROUGHOUT THE CONSTRUCTION PROCESS BY THE CONTRACTOR.
- C. DO NOT PERMIT HEAVY EQUIPMENT OR STOCKPILES WITHIN THE DRIP LINE OF EXISTING OR NEWLY PLANTED TREES. REMOVE INTERFERING BRANCHES WITHOUT INJURY TO TRUNKS.

### 3.7 MAINTENANCE

- A. MAINTENANCE ACTIVITIES SHALL INCLUDE THE FOLLOWING ACTIVITIES DURING CONSTRUCTION AND UNTIL FINAL ACCEPTANCE:
1. WEEDING: MAINTAIN PLANTINGS AND TURF AS WEED FREE.
  2. MULCHING: MAINTAIN MULCH AT TREES, PALMS, AND WITHIN PLANTING BEDS AT A 3" DEPTH.
  3. PEST CONTROL: SPRAY AS REQUIRED TO KEEP PLANTINGS AND TURF FREE OF INSECTS AND DISEASE.
  4. MOWING: MOW TURF AREAS AS NEEDED OR AS DIRECTED BY THE OWNER'S REPRESENTATIVE.
  5. REPLACEMENT: REPLACE PLANTS OR SOO AREAS THAT ARE IN POOR CONDITION.
  6. LITTER REMOVAL: REMOVE LITTER AND DEBRIS FROM LANDSCAPE AND TURF AREAS.
  7. RESTORE PLANTING SAUCERS OF TREES AND SHRUBS.
  8. TIGHTEN AND REPAIR STAKE AND GUY WIRE SUPPORTS, IF PRESENT, AND RESET TREES AND SHRUBS TO PROPER GRADES OR VERTICAL POSITION AS REQUIRED.
  9. REMOVE ALL TREE STAKING, IF PRESENT, WITHIN ONE YEAR AFTER PLANTING.

### 3.8 REPLACEMENT OF EXISTING LANDSCAPE DAMAGED DURING PROJECT

- A. ANY EXISTING VEGETATION, INCLUDING TREES AND SHRUBS, DAMAGED OR DESTROYED SHALL BE REPLACED OR MITIGATED BY THE CONTRACTOR WITH LIKE SPECIES OR ANOTHER SPECIES APPROVED BY THE OWNER'S REPRESENTATIVE. ANY AREA OF VEGETATION THAT IS DAMAGED DURING CONSTRUCTION WILL BE RESTORED TO ITS ORIGINAL STATE WITHIN 72 HOURS OF THE COMPLETION OF THE ASSOCIATED CONSTRUCTION WORK.
- B. IF REMOVAL OF AN EXISTING TREE REQUIRES MITIGATION, THE CONTRACTOR SHALL BE HELD LIABLE FOR THE COMPLETE COST, INCLUDING BUT NOT LIMITED TO TREE REPLACEMENT COSTS AND PAYMENTS REQUIRED TO PERMITTING AGENCIES.
- C. TREE REPLACEMENT SPECIES AND PROCEDURES SHALL BE DISCUSSED WITH AND APPROVED BY THE OWNER'S REPRESENTATIVE AND OWNER'S REPRESENTATIVE PRIOR TO COMMENCEMENT OF ACTIVITIES.

### 3.9 INSPECTION AND ACCEPTANCE

- A. WHEN ALL LANDSCAPE WORK IS SUBSTANTIALLY COMPLETE, THE OWNER'S REPRESENTATIVE WILL, UPON REQUEST, MAKE A SUBSTANTIAL COMPLETION INSPECTION TO DETERMINE ACCEPTABILITY AND COMPLIANCE WITH THE CONTRACT DOCUMENTS. THE OWNER'S REPRESENTATIVE WILL PRODUCE A WRITTEN PUNCH LIST FOR THE CONTRACTOR AND OWNER'S REPRESENTATIVE TO IDENTIFY ITEMS THAT SHALL BE ADDRESSED PRIOR TO FINAL ACCEPTANCE.
- B. UPON THE TERMS OF THE OWNER'S REPRESENTATIVE'S REQUEST, THE OWNER'S REPRESENTATIVE WILL CONDUCT A FINAL COMPLETION INSPECTION. IF NECESSARY, THE OWNER'S REPRESENTATIVE WILL PRODUCE A FINAL PUNCH LIST FOR THE CONTRACTOR AND OWNER'S REPRESENTATIVE TO IDENTIFY ITEMS TO BE ADDRESSED PRIOR TO FINAL ACCEPTANCE.
- C. FINAL ACCEPTANCE WILL NOT BE ISSUED UNTIL ALL PUNCH LIST ITEMS HAVE BEEN COMPLETED AND ACCEPTED BY THE OWNER AND ALL SUBMITTALS HAVE BEEN MADE.
- D. WORK MAY BE INSPECTED FOR ACCEPTANCE IN PORTIONS AS PHASES OF INSTALLATION ARE COMPLETED AND AS AGREEABLE TO THE OWNER'S REPRESENTATIVE, PROVIDED EACH PORTION OF WORK OFFERED FOR INSPECTION IS SUBSTANTIALLY COMPLETE.

END OF SECTION

	DESIGN DEVELOPMENT SUBMITTAL	05-21-24	-
	90% CONSTRUCTION DOCUMENTS	07-02-24	-
	SITE DEVELOPMENT REVIEW	09-06-24	-
	SITE DEVELOPMENT REVIEW	12-20-24	-
	SITE DEVELOPMENT REVIEW &		
	BID ADDENDUM NO. 1	01-22-25	-
	NOT FOR CONSTRUCTION	-	-
No.	REVISIONS	DATE	BY


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SW25-000012 - SITE WORK -  
Tom Petty Park (LD24-000087)

02/28/25

**TOM PETTY PARK  
PICKLEBALL IMPROVEMENTS  
PREPARED FOR  
CITY OF GAINESVILLE  
WILD SPACES & PUBLIC PLACES  
GAINESVILLE, FLORIDA**

SHEET NUMBER  
**L3.00**

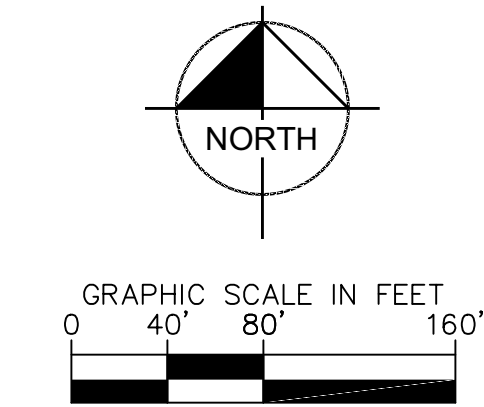

### GENERAL IRRIGATION NOTES

1. THERE IS AN EXISTING IRRIGATION SYSTEM ON SITE THAT SERVES THE EXISTING BASEBALL FIELDS. IT IS SERVED BY A 4" MAINLINE LOCATED BETWEEN THE NORTHERNMOST BASEBALL FIELDS. IS A TWO-WIRE SYSTEM, AND INCLUDES A 2" MAINLINE. AS-BUILT IRRIGATION PLANS WILL BE PROVIDED FOR REFERENCE AT THE PRECONSTRUCTION CONFERENCE. PROTECT EXISTING IRRIGATION DURING CONSTRUCTION.
2. THE POINT OF CONNECTION FOR THIS PROJECT'S IRRIGATION SYSTEM WILL BE THE EXISTING 2" MAINLINE OF THE EXISTING IRRIGATION SYSTEM, IN THE GENERAL LOCATION OF EXISTING VALVE NO.S 19-21 WEST OF THE MOST WESTERN BASEBALL FIELD.
3. PROPOSED TREES TO BE SERVED BY MICRO-SPRAYS, ONE PER TREE.
4. PROPOSED SHRUB, ORNAMENTAL GRASS, AND GROUNDCOVER AREA TO BE SERVED BY COPPER INFUSED DRIP-TUBING.
5. PROPOSED IRRIGATION IS A PERMANENT SYSTEM AND SERVES LESS THAN 50% OF THE TOTAL PERMEABLE AREA OF THE PROJECT AREA.
6. CONTRACTOR IS RESPONSIBLE FOR APPLYING, MANAGING, AND SUBMITTING FOR AN IRRIGATION PERMIT AT THE START OF CONSTRUCTION. REFERENCE ALACHUA COUNTY ENVIRONMENTAL PROTECTION DEPARTMENT REQUIREMENTS AND APPLY THROUGH THE ONLINE ALACHUA COUNTY IRRIGATION PROFESSIONAL PORTAL- SEE NOTES BELOW. THE IRRIGATION SYSTEM SHALL COMPLY WITH THE LANDSCAPE IRRIGATION DESIGN AND MAINTENANCE STANDARDS FOUND IN ALACHUA COUNTY LAND DEVELOPMENT CODE ARTICLE II OF PART II, TITLE 7, CHAPTER 79.61 OF THE ALACHUA COUNTY CODE, WHICH, AMONG ADDITIONAL DESIGN STANDARDS, REQUIRES THE FOLLOWING. FOR MORE INFORMATION, CONTACT THE ALACHUA COUNTY ENVIRONMENTAL PROTECTION DEPARTMENT AT 352-264-8800. IRRIGATION ZONES SHALL BE DIVIDED ACCORDING TO VEGETATED GROUPINGS AND PLANT WATER REQUIREMENTS.
  - SPRINKLER SPRAYHEADS AND ROTORS WILL NOT BE PLACED IN THE SAME ZONE.
  - A FUNCTIONING SOIL MOISTURE SENSOR AND A RAINFALL SHUT-OFF DEVICE/RAIN SENSOR WILL BE INCLUDED.
  - TURF WILL NOT BE IRRIGATED.
  - ALL HEADS WILL BE INSTALLED A MIN. OF 6" FROM PAVEMENT EDGES, 24" FROM STRUCTURES, AND SHALL PROVIDE HEAD-TO-HEAD COVERAGE WITHOUT OVERSPRAY ON ADJACENT PAVED SURFACES.



No.	REVISIONS	DATE	BY
	DESIGN DEVELOPMENT SUBMITTAL	05-21-24	-
	90% CONSTRUCTION DOCUMENTS	07-02-24	-
	SITE DEVELOPMENT REVIEW	09-06-24	-
	SITE DEVELOPMENT REVIEW	12-20-24	-
	SITE DEVELOPMENT REVIEW &		
	BID ADDENDUM NO. 1		
	NOT FOR CONSTRUCTION	01-22-25	-
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SW25-000012 - SITE WORK -  
Tom Petty Park (LD24-000087)

02/28/25

KHA PROJECT

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# IRRIGATION PLAN

TOM PETTY PARK  
PICKLEBALL IMPROVEMENTS  
PREPARED FOR  
CITY OF GAINESVILLE  
WILD SPACES & PUBLIC PLACES

GAINESVILLE  
FLORIDA

SHEET NUMBER  
**L3.01**



	DESIGN DEVELOPMENT SUBMITTAL	05-21-24	-
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	SITE DEVELOPMENT REVIEW	12-20-24	-
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	BID ADDENDUM NO. 1	01-22-25	-
	NOT FOR CONSTRUCTION	-	-
No.	REVISIONS	DATE	BY




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SW25-000012 - SITE WORK -  
Tom Petty Park (LD24-000087)

02/28/25




**TOM PETTY PARK  
PICKLEBALL IMPROVEMENTS  
PREPARED FOR  
CITY OF GAINESVILLE  
WILD SPACES & PUBLIC PLACES  
GAINESVILLE, FLORIDA**

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**L3.02**



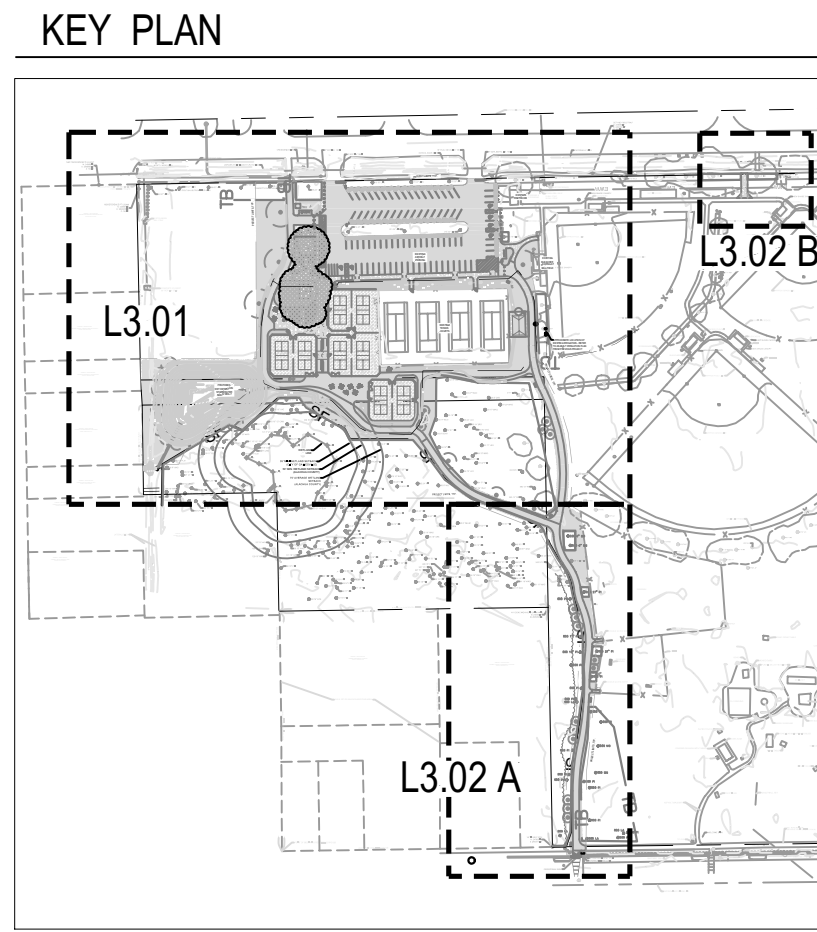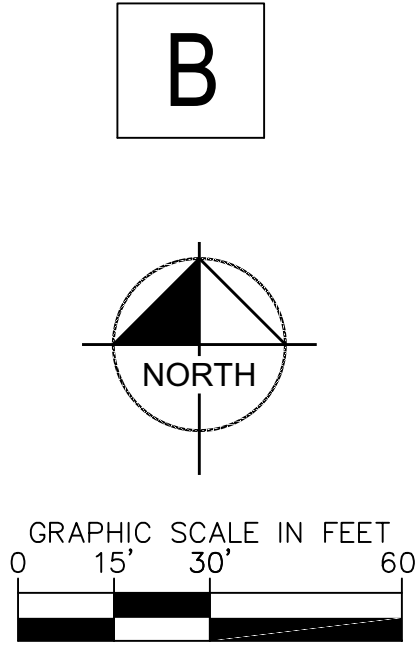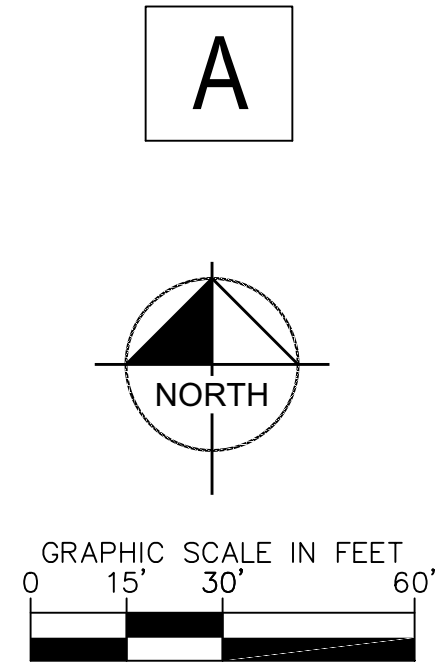


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SITE DEVELOPMENT REVIEW	12-20-24	-
SITE DEVELOPMENT REVIEW & BID ADDENDUM NO. 1	01-22-25	-
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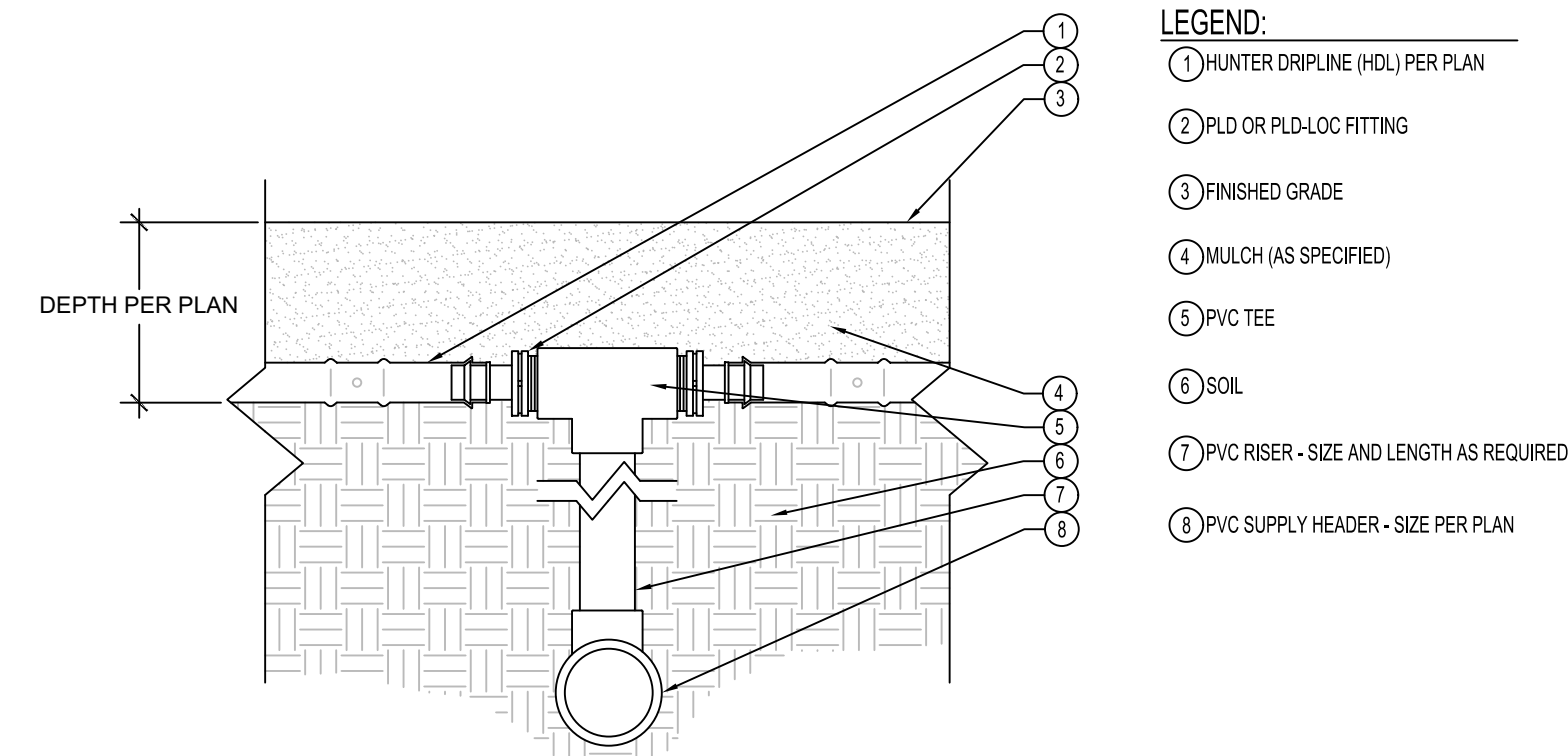

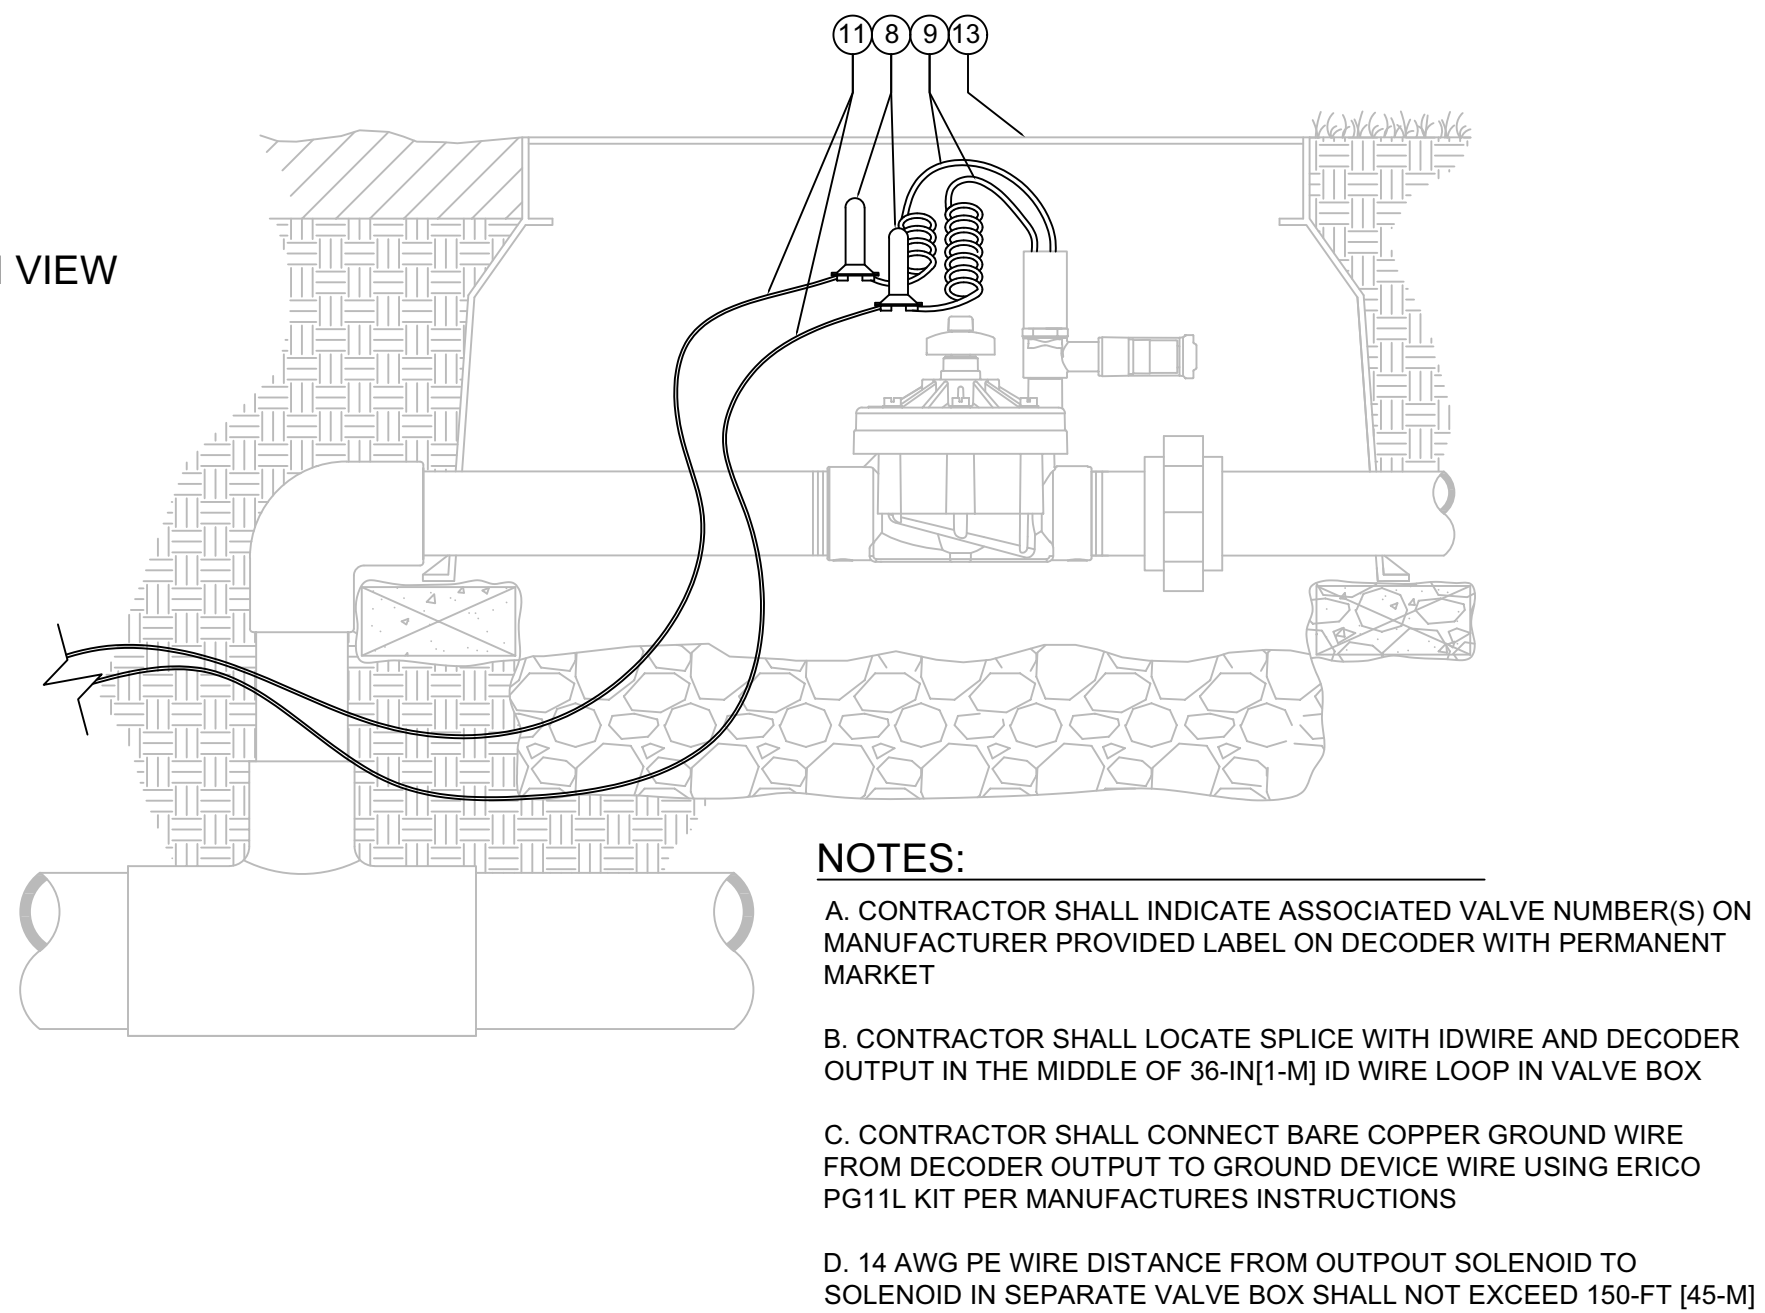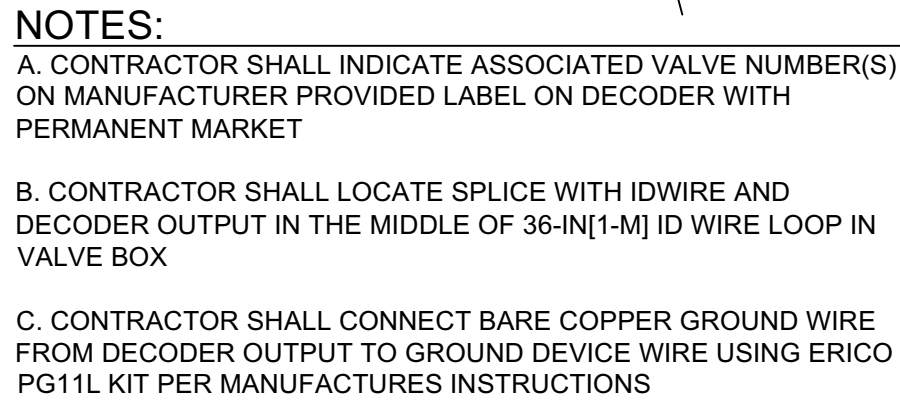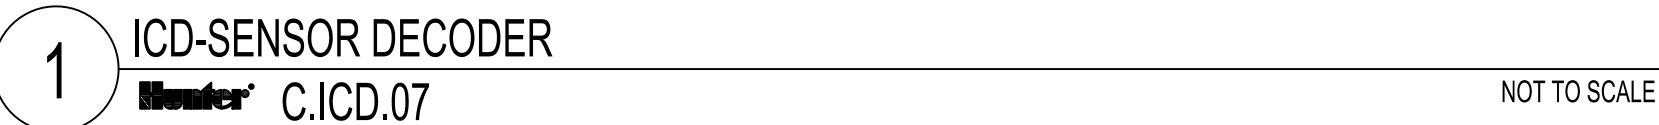
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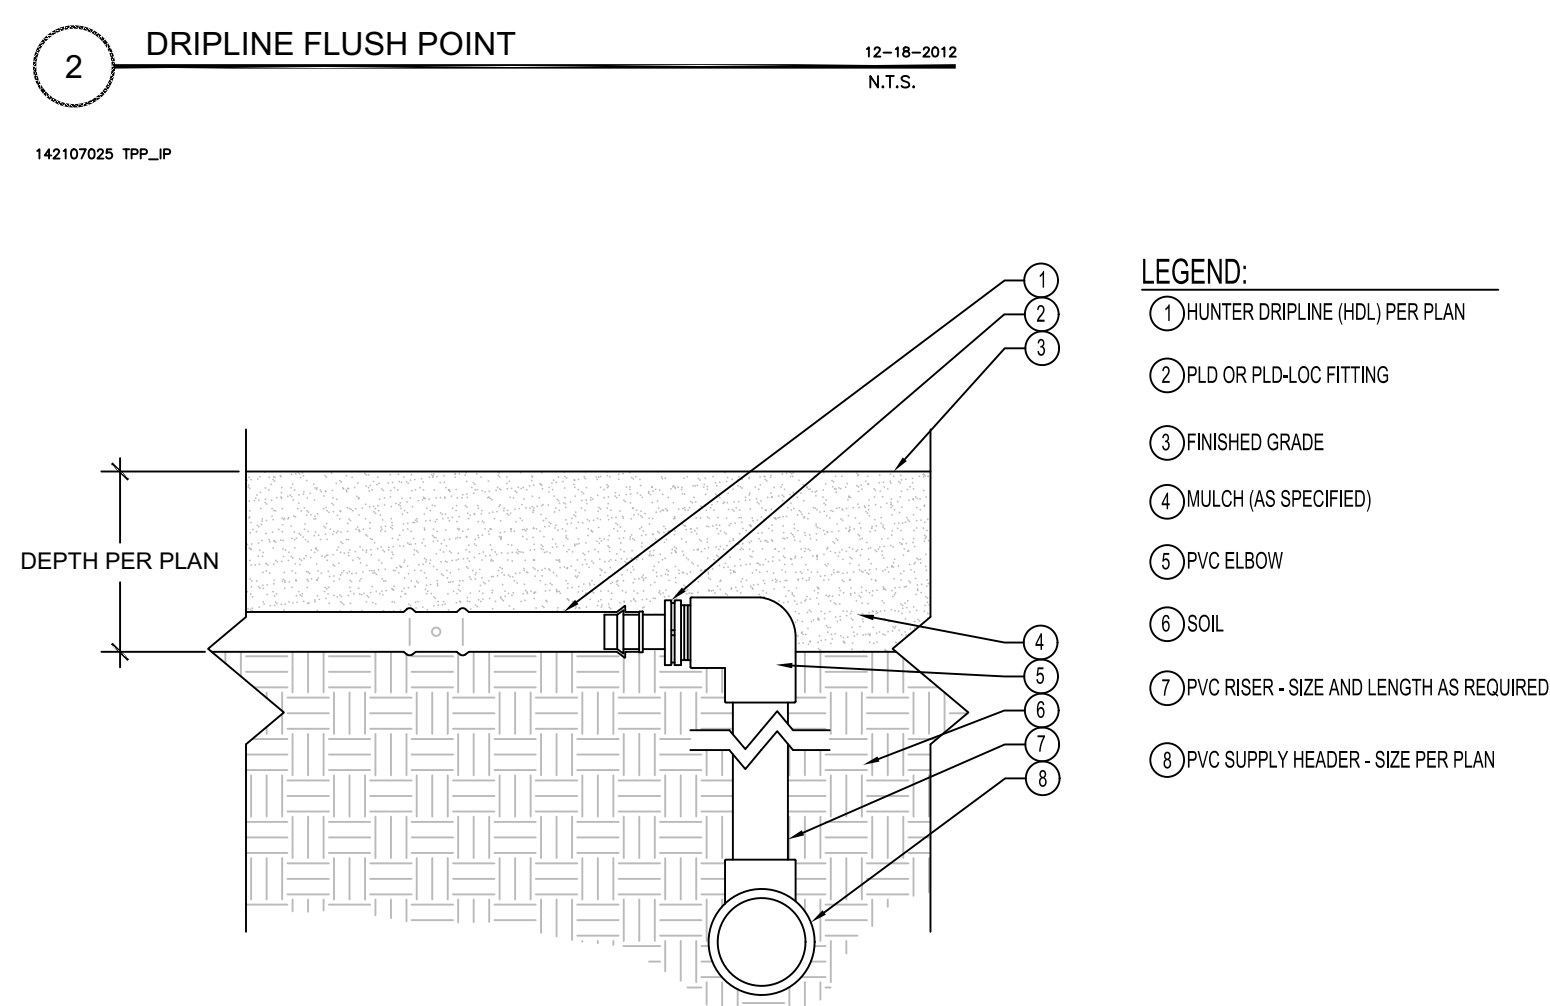
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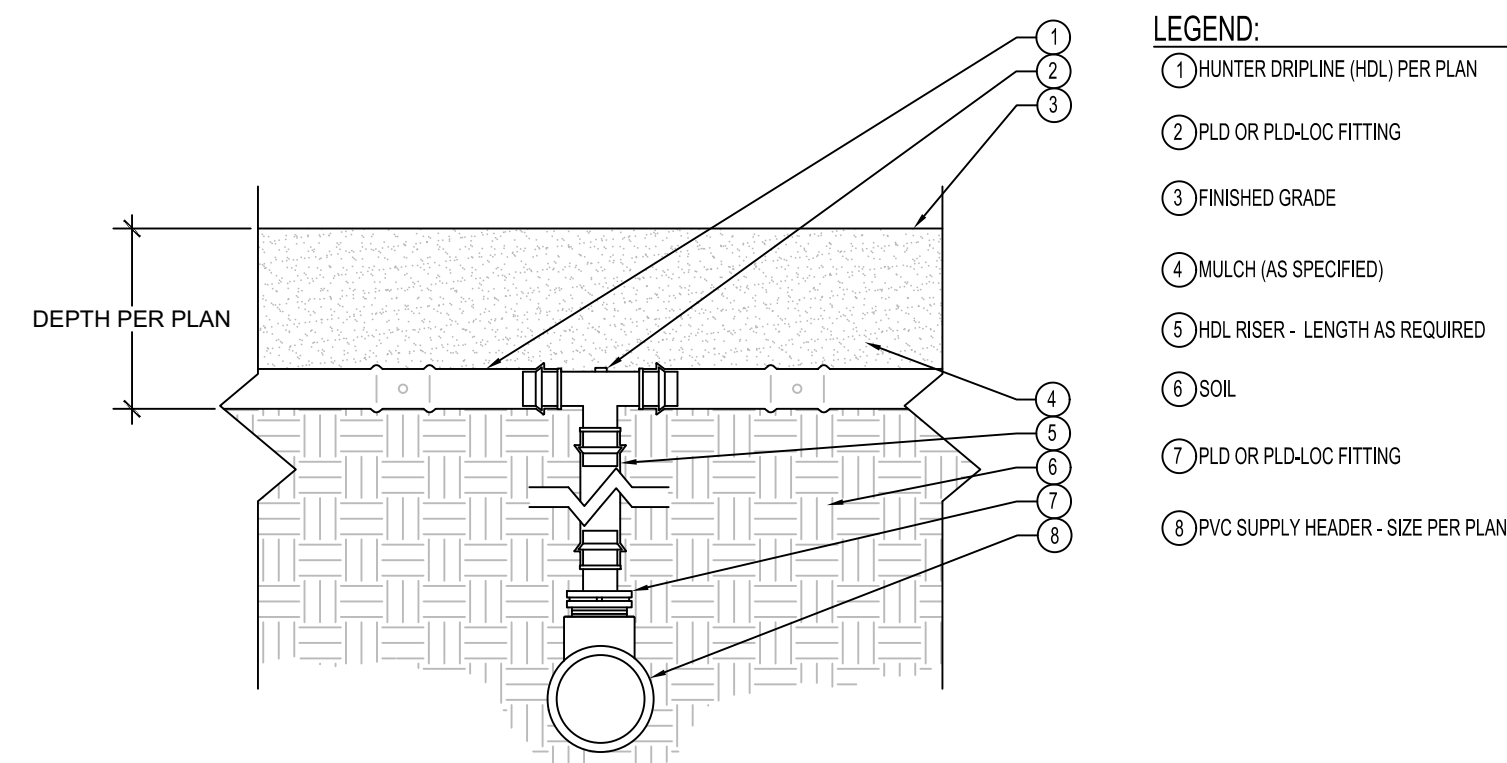
NOTE:  
1. ALLOW A MINIMUM OF 6-INCHES OF DRIPLINE TUBING IN VALVE BOX IN ORDER TO DIRECT FLUSHED WATER OUTSIDE VALVE BOX.




3 HUNTER DRIPLINE - CONNECTION WITH PVC RISER AND TEE

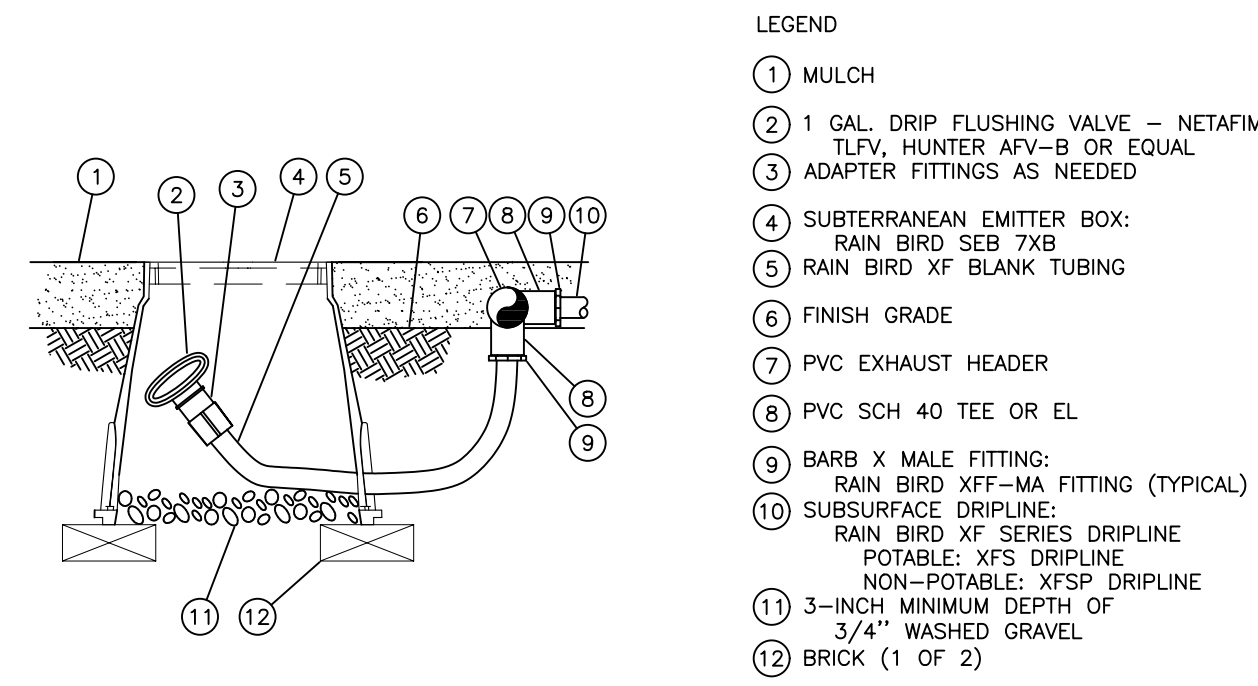


4 HUNTER DRIPLINE - CONNECTION WITH PVC RISER AND ELBOW



5 HUNTER DRIPLINE - CONNECTION WITH DRIPLINE AND TEE  
HM.HDL.06 NOT TO SCALE

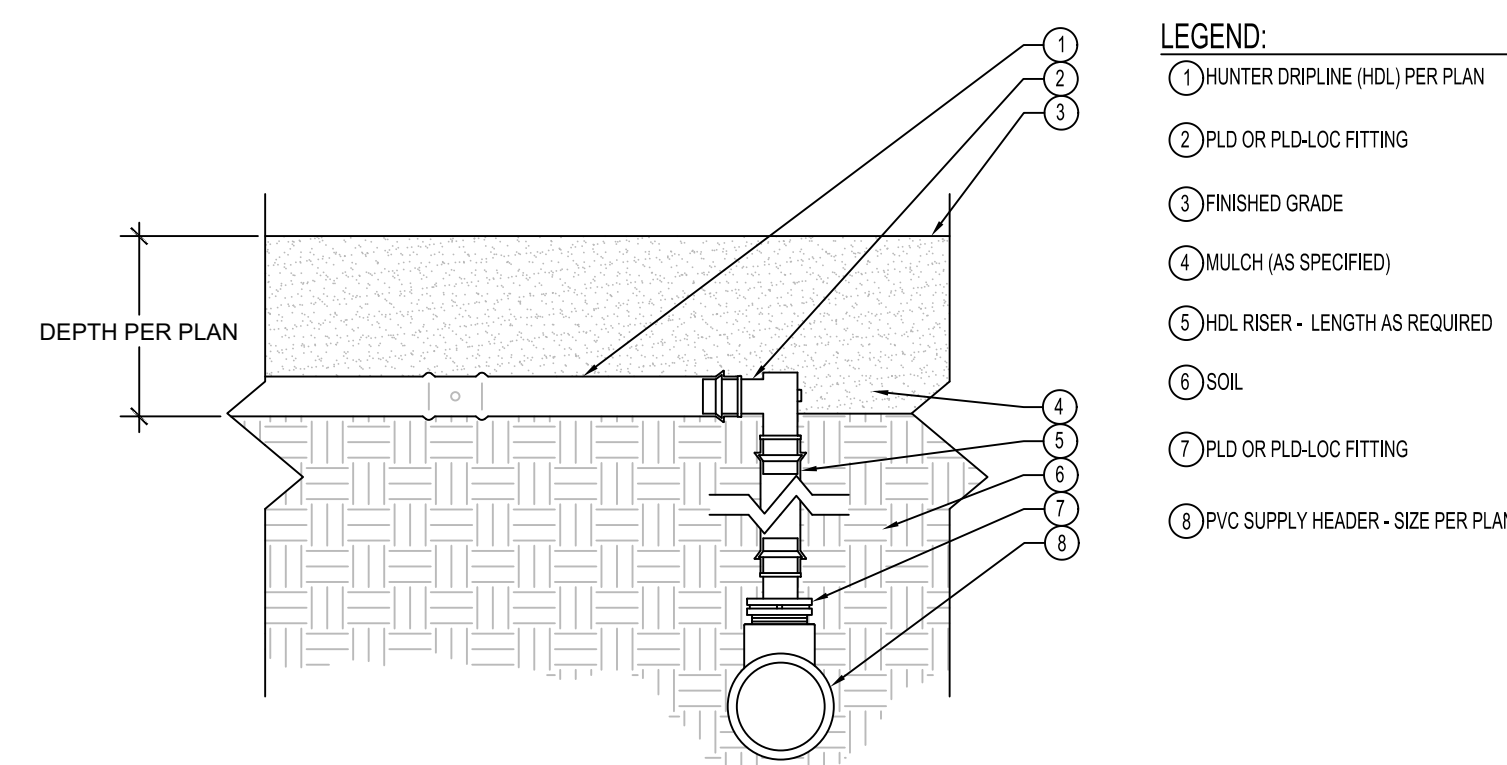

7 HUNTER DRIPLINE - CONNECTION WITH DRIPLINE AND ELBOW  
HM.HDL.04 NOT TO SCALE

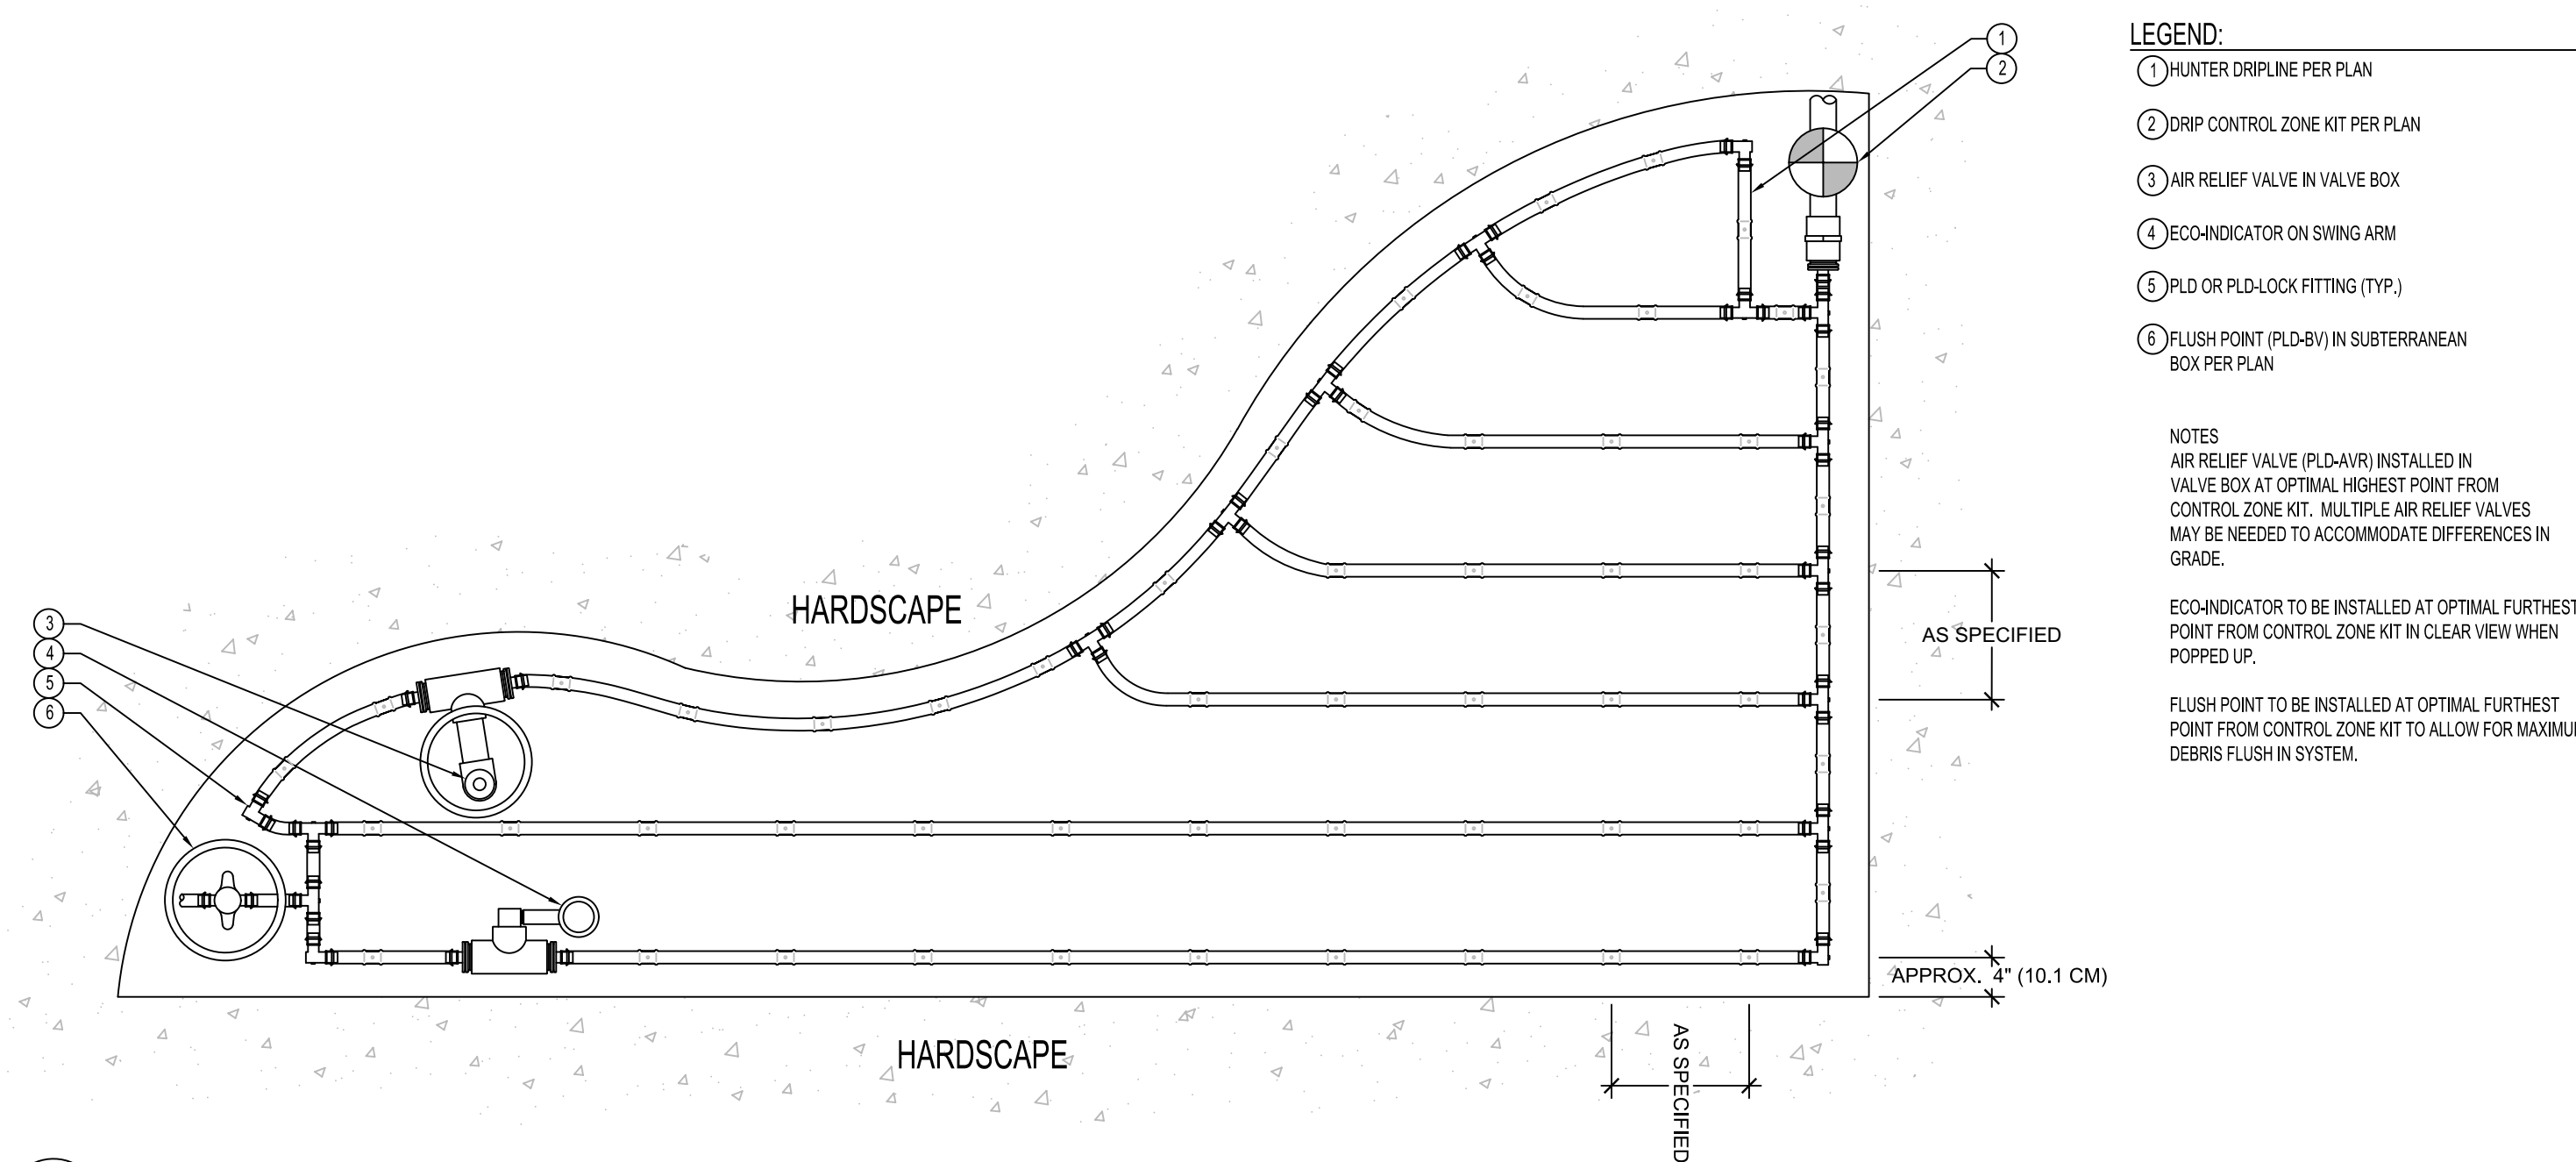


6 HUNTER DRIPLINE - IRREGULAR PLANTED AREA

No.	DATE	BY
DESIGN DEVELOPMENT SUBMITTAL	05-21-24	-
90% CONSTRUCTION DOCUMENTS	07-02-24	-
SITE DEVELOPMENT REVIEW	09-06-24	-
SITE DEVELOPMENT REVIEW	12-20-24	-
SITE DEVELOPMENT REVIEW & BID ADDENDUM NO. 1	01-22-25	-
NOT FOR CONSTRUCTION	-	-



DATE: 02/13/25  
LD24-000087 -  
Intermediate - Tom  
Petty Park Pickleball

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GAINEVILLE  
REVIEWED FOR  
CODE COMPLIANCE

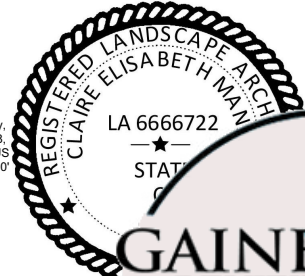SW25-000012 - SITE WORK -  
Tom Petty Park (LD24-000087)

02/28/25

## IRRIGATION DETAILS

**TOM PETTY PARK  
PICKLEBALL IMPROVEMENTS  
PREPARED FOR  
CITY OF GAINESVILLE  
WILD SPACES & PUBLIC PLACES  
GAINESVILLE, FLORIDA**

SHEET NUMBER  
**L3.06**

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PART 1 – GENERAL

DESCRIPTION

FURNISH ALL MATERIALS, LABOR, EQUIPMENT, TOOLS, AND TRANSPORTATION, UNLESS OTHERWISE SPECIFIED, NECESSARY TO PROVIDE AN AUTOMATIC IRRIGATION SYSTEM FOR LANDSCAPE PLANT MATERIALS AND TURF AND MULCH AREAS.

APPLICABLE STANDARDS

AMERICAN SOCIETY OF AGRICULTURAL ENGINEERS S376.1, "DESIGN, INSTALLATION AND PERFORMANCE OF UNDERGROUND, THERMOPLASTIC IRRIGATION PIPELINES."

ASTM D2774, "UNDERGROUND INSTALLATION OF THERMOPLASTIC PRESSURE PIPING."

ASTM D1785, POLY (VINYL CHLORIDE) (PVC) PLASTIC PIPE, SCHEDULES 40, 80, AND 120.

ASTM D2241 POLY (VINYL CHLORIDE) (PVC) PLASTIC PIPE (SDR–PR).

SUBSTITUTIONS

WHEREVER BRAND NAMES ARE USED IN THESE SPECIFICATIONS, USE ONLY THE BRAND SPECIFIED. MAKE NO SUBSTITUTIONS AS A PART OF THIS BID PACKAGE.

PART 2 – MATERIALS

PIPE

FURNISH ALL UNDERGROUND PIPING AS PVC EXCEPT FOR ANY FLEXIBLE POLYETHYLENE (POLY PIPE) PIPING THAT IS TO BE USED BETWEEN THE LATERALS AND SPRINKLER HEADS. ALL PVC PIPE SHALL BE CL 200 PIPE OR BETTER. INSTALL ALL PVC PIPE AS PURPLE TO DENOTE REUSE.

SIZE EACH SLEEVE AT LEAST TWICE (2X) THE SIZE OF THE PIPE BEING ROUTED THROUGH IT. INSTALL EACH CONTROL WIRE SLEEVE OF SUFFICIENT SIZE FOR THE REQUIRED NUMBER OF WIRES BEING ROUTED THROUGH IT UNDER THE AREA SPECIFIED. CONSULT WITH THE OWNER OR OWNER'S REPRESENTATIVE FOR THE LOCATION, DEPTH, NUMBER AND SIZE OF ANY AVAILABLE EXISTING SLEEVES.

INSTALL ANY ABOVE GROUND PIPE AS GALVANIZED PIPE.

PIPE FITTINGS

FOR MAIN LINE PVC PIPE FITTINGS, USE PVC SCH. 40 FITTINGS AND USE THREADED FITTINGS FOR CONNECTION TO VALVES.

FOR PVC ZONE PIPE, USE SCHEDULE 40, SOLVENT WELD FITTINGS, MANUFACTURED FROM PVC 12454–B COMPOUND AND TESTED IN ACCORDANCE WITH ASTM D2466, EXCEPT FOR THREADED FITTINGS. FOR THREADED APPLICATIONS, USE SCHEDULE 80 FITTINGS MANUFACTURED FROM PVC 12454– B COMPOUND AND TESTED IN ACCORDANCE WITH ASTM D2467.

CONNECT ALL "POLY PIPE" AND RISER ASSEMBLIES TO THE IRRIGATION PIPELINE WITH A SCHEDULE 80 TEE, AS DESCRIBED ABOVE.

DO NOT USE MALE ADAPTERS FOR ANY APPLICATIONS. INSTEAD, USE A "TOE" NIPPLE GLUED INTO A SCHEDULE 40 COUPLER.

SEE DETAILS FOR SPRINKLER TO PIPE CONNECTIONS. NO "FLEX PVC" IS ALLOWED.

SOLVENT CEMENT AND PRIMER

USE A MEDIUM OR HEAVY BODY GRAY SOLVENT CEMENT MANUFACTURED IN ACCORDANCE WITH ASTM D2564 AND PRIMER MANUFACTURED IN ACCORDANCE WITH ASTM F656.

VALVE BOXES

USE 12 X 18 VALVE BOXES FOR ALL APPLICATIONS. (PURPLE LIDS)

ELECTRIC VALVES

USE HUNTER ICV ELECTRIC VALVES WITH DECODER AND PRESSURE REGULATOR PER PLANS, LEGEND AND DETAILS FOR ALL APPLICATIONS. (PURPLE HANDLES) POINT OF CONNECTION

CONNECT TO THE 2" EXISTING MAIN LINE AS AT THE LOCATION NOTED ON THE PLANS AS THE POINT OF CONNECTION FOR THE WATER AND 2–WIRE COMMUNICATION WIRE.

TREE SPRINKLERS

INSTALL HUNTER PROS–04–PRS30–CV–F–R SPRINKLERS WITH APPROPRIATE NOZZLES AND SCREENS FOR TREE SPRINKLER APPLICATIONS.

SHRUBS AND GROUNDCOVER

INSTALL HUNTER HDP–COP–R TUBING WITH HUNTER DRIP FITTINGS FOR ALL PLANTING BED APPLICATIONS AS SHOWN ON THE PLANS. DO NOT USE OTHER TUBING THAT DOES NOT HAVE ROOT INTRUSION DETERRENT.

WIRE

USE U.L. U.F. WIRE APPROVED FOR DIRECT BURIAL UNDERGROUND FOR ALL 24 VAC APPLICATIONS.

USE HUNTER APPROVED TWISTED SHIELDED PAIR WIRE FOR ALL CONTROLLER TO DECODER COMMUNICATION WIRES.

USE RED #14 AWG WIRE FOR ALL DECODER TO VALVE POWER WIRES.

USE WHITE #14 AWG WIRE FOR ALL DECODER TO VALVE COMMON WIRES.

USE TWISTED SHIELDED 14 GAUGE OR LARGER WIRE PER HUNTER RECOMMENDATIONS FOR ALL 2– WIRE COMMUNICATIONS WIRE APPLICATIONS.

PART 3 – EXECUTION

A. GENERAL

INSTALL PVC PIPE IN ACCORDANCE WITH MANUFACTURER'S RECOMMENDATIONS. REVIEW CONSTRUCTION PLANS WITH THE OWNER OR OWNER'S REPRESENTATIVE BEFORE ANY WORK BEGINS. THE CONTRACTOR SHALL CONTACT THE LANDSCAPE ARCHITECT/OWNER PRIOR TO INSTALLATION IF THERE IS ANY DOUBT AS TO HEAD LINE OR ZONE PLACEMENT.

INSPECT THE CONSTRUCTION SITE BEFORE ANY WORK BEGINS AND FLAG LOCATIONS OF MAINLINE PIPE, SLEEVES, HEADS AND VALVES FOR REVIEW BY THE LANDSCAPE ARCHITECT/OWNER. FLAGS SHALL BE CLEARLY MARKED OR COLORED TO DESIGNATE THE TYPE OF EQUIPMENT TO BE INSTALLED AT THAT POINT. INSTALLATION SHALL NOT COMMENCE UNTIL THE STAKING/ FLAGGING HAS BEEN APPROVED.

PIPE TRENCH CONSTRUCTION

PROVIDE FOR A MINIMUM DEPTH OF COVER OF 18" FOR ALL MAIN LINE PIPE AND 12" OF COVER FOR ALL ZONE PIPE AS MEASURED FROM FINISHED GRADE.

PROVIDE THE MINIMUM DEPTH OF COVER, AS SPECIFIED ABOVE, OVER THE TOP OF THE PIPE BEFORE THE TRENCH IS WHEEL–LOADED.

INSTALLATION COORDINATION

COORDINATE THE INSTALLATION OF THE IRRIGATION SYSTEM WITH THE GENERAL CONTRACTOR AND LANDSCAPE CONTRACTOR TO PROVIDE FOR CORRECT APPLICATION OF WATER TO THE PLANT MATERIAL AND TO AVOID TREE PLANTING LOCATIONS.

BACK FILL

PROVIDE INITIAL BACK FILL MATERIAL THAT IS FINE–GRAINED MATERIAL FREE FROM COMPACTED EARTH GREATER THAN TWO INCHES IN DIAMETER, ROCKS, OR STONES.

TAMP THE BACK FILL IN LAYERS NOT TO EXCEED SIX INCHES. LIFT AND COMPACT FIRMLY AROUND THE PIPE AND UP TO AT LEAST SIX INCHES ABOVE THE TOP OF THE PIPE. SUFFICIENTLY MOISTEN THE BACK FILL TO PERMIT THOROUGH COMPACTION UNDER AND ON EACH SIDE OF THE PIPE TO PROVIDE SUPPORT FREE FROM VOIDS. AVOID DEFORMING, DISPLACING, OR DAMAGING PIPE DURING THIS PHASE OF THE OPERATION. ASSURE THAT WHEN FINISHED, THE SOIL COMPACTION EQUALS THE ORIGINAL CONDITION.

FITTING AND PIPE CONNECTIONS

SQUARE CUT, CLEAN AND PRIME ALL JOINTS BEFORE CEMENTING. FULLY ENGAGE ALL JOINTS WHILE CEMENTING.

PVC FITTINGS – MAKE ALL SOLVENT WELD JOINTS IN ACCORDANCE WITH ASTM D2855. PRIME ALL FITTINGS WITH PURPLE PRIMER BEFORE MAKING SOLVENT WELD CONNECTIONS. ALLOW SOLVENT WELDED JOINTS AT LEAST ONE (1) HOUR TO SET UP BEFORE MOVING OR HANDLING. DO NOT PERMIT WATER IN THE PIPE FOR AT LEAST TWENTY–FOUR HOURS AFTER MAKING A SOLVENT WELD ON THAT PIPE UNLESS RECOMMENDED OTHERWISE BY THE SOLVENT CEMENT MANUFACTURER. SEAL ALL THREADED PVC FITTINGS WITH LIQUID TEFLON EXCEPT SPRINKLER HEADS, ELECTRIC VALVE CONNECTIONS AND SWING JOINTS. INSTALL ALL OF THESE EXCEPTIONS USING ONE INCH TEFLON TAPE.

FLUSHING PIPELINES

FLUSH ALL PIPELINES BEFORE SPRINKLERS ARE INSTALLED. MAINTAIN A MINIMUM PIPE VELOCITY OF THREE FEET PER SECOND AND FLUSH FOR A MINIMUM TIME OF:

T = 2L/3 WHERE T = TIME IN SECONDS & L = PIPE LENGTH IN FEET FROM INLET POINT TO MOST DISTANT POINT IN PIPELINE.

INSTALLING ELECTRIC VALVE CONTROL WIRING

INSTALL WIRING IN THE SAME TRENCH AND ALONG THE SAME ROUTE AS, AND UNDERNEATH THE MAIN LINE EXCEPT IN LOCATIONS WHERE THE WIRE WILL PASS UNDER PAVING. AT THOSE LOCATIONS INSTALL THE WIRE INSIDE OF A PVC SLEEVE. INSTALL CONTROL WIRING THROUGH WALLS, FLOORS, AND SLABS IN PVC SLEEVES.

TAPE WIRING TOGETHER AT INTERVALS OF TEN FEET, USING 1/4 INCH FIBER REINFORCED TAPE.

MAKE AN EXPANSION LOOP OF A MINIMUM 12 INCHES DIAMETER AT EACH WIRE CONNECTION. PROVIDE EXPANSION COILS OF WIRE AT NO MORE THAN 100 FOOT INTERVALS AND AT EACH DIRECTION CHANGE IN THE WIRE ROUTING.

ATTACH PERMANENT MARKINGS AT EACH END OF EACH WIRE TO IDENTIFY IT BY VALVE NUMBER. (CHRISTIE I.D. TAGS OR EQUAL)

AUTOMATIC CONTROLLER INSTALLATION

LOCATION – VERIFY LOCATION WITH OWNER OR OWNER'S REPRESENTATIVE BEFORE INSTALLATION.

VERIFY THAT SUFFICIENT SLEEVING EXISTS TO ALLOW ROUTING OF THE VALVE WIRING FROM THE CONTROLLER TO EACH VALVE.

VALVE INSTALLATION

INSTALL ALL AUTOMATIC ZONE VALVES AND GATE VALVES IN VALVE BOXES. NUMBER EACH ZONE VALVE BOX ON THE UNDERSIDE AND TOPSIDE OF EACH VALVE BOX COVER WITH BLACK WATERPROOF MARKER FOR REFERENCE.

INSTALL ANY MAIN LINE ISOLATION VALVES IN VALVE BOXES.

INSTALLATION OF SPRINKLER HEADS.

INSTALLATION SCHEDULE – INSTALL SPRINKLER HEADS AFTER THE SPRINKLER BODY ASSEMBLIES HAVE BEEN CLEANLY FLUSHED.

ORIENTATION – INSTALL POP–UP UNITS IN A PLUMB POSITION AND FIELD ADJUST SPRINKLER HEADS TO OBTAIN COMPLETE COVERAGE OF IRRIGATED AREA WITH MINIMUM OVER SPRAY ONTO PAVED SURFACES. HEADS ARE TO BE LOCATED ON A MAXIMUM SPACING OF 55% OF THE SPRINKLER COVERAGE DISTANCE AND CLOSER WHERE INDICATED. ADJUST NOZZLE DISTANCE AS NEEDED TO COVER PLANT MATERIALS AND MINIMIZE OVER SPRAY ON STRUCTURES AND PAVEMENT. ALIGN POP–UP SPRAY HEADS IN A VERTICAL ORIENTATION AS SHOWN IN THE DETAILS. ADJUST AS NECESSARY TO PROVIDE THE BEST COVERAGE IN SLOPED AREAS.

TESTING

PRESSURE TEST THE SYSTEM MAIN LINE BEFORE APPRECIABLY BACKFILLING.

PRESSURE TEST THE SYSTEM MAIN LINE, IN THE PRESENCE OF THE OWNER OR OWNER'S REPRESENTATIVE, FOR A PERIOD OF NO LESS THAN FOUR HOURS, CONTINUOUSLY, AT A PRESSURE OF NO LESS THAN 100 PSI WITH NO LEAKS AND ASSURE THAT ANY TESTS OF THE SYSTEM MAIN LINE MEET THE APPLICABLE COUNTY PLUMBING CODES. IF LEAKAGE OCCURS, REMEDY THE LEAKAGE PROBLEM AND RETEST. REPEAT THIS PROCESS AS MANY TIMES AS NECESSARY UNTIL A SUCCESSFUL TEST IS PERFORMED.

INSPECTIONS

THE FOLLOWING INSPECTIONS ARE REQUIRED. NOTIFY OWNER OR OWNER'S REPRESENTATIVE IN ADVANCE THAT EACH ITEM IS READY FOR INSPECTION AS INDICATED BELOW:

INSPECTION OF FLAGGED UNDERGROUND MAINLINE PIPING, SLEEVES, SPRINKLER AND VALVE LOCATIONS PRIOR TO BEGINNING CONSTRUCTION –NOTIFY 48 HOURS IN ADVANCE.

SPRINKLER COVERAGE TEST – NOTIFY 48 HOURS IN ADVANCE.

FINAL INSPECTION – NOTIFY 48 HOURS IN ADVANCE.

TESTING

COVERAGE TESTS – CONDUCT SPRINKLER COVERAGE TESTS UNDER NORMAL OPERATING PRESSURE CONDITIONS BEFORE ANY GROUND COVER OR TURF IS PLANTED. CORRECT AND FIELD ADJUST SPRINKLER ORIENTATION TO PROVIDE UNIFORM PRECIPITATION OVER THE IRRIGATED AREA AND MINIMIZE OVER SPRAY ONTO PAVED SURFACES AND BUILDINGS.

WARRANTY

THE CONTRACTOR SHALL ISSUE TO THE OWNER OR OWNER'S REPRESENTATIVE A CERTIFICATE OF WARRANTY OF THE IRRIGATION SYSTEM FOR A PERIOD OF NOT LESS THAN ONE YEAR ON ALL SPRINKLERS, VALVES, THE CONTROLLER, AND HIS LABOR.

DRAWING OF RECORD

THE CONTRACTOR SHALL SUPPLY TO THE OWNER A DRAFTED, SCALED, REPRODUCIBLE PLAN SHOWING ALL CHANGES MADE TO THE EXISTING IRRIGATION SYSTEM AND ALL NEWLY INSTALLED COMPONENTS INCLUDING ALL SPRINKLERS, INCLUDING BODY TYPES AND NOZZLES, PIPE, INCLUDING SIZES AND THE ENDS OF SLEEVING LOCATIONS AS MEASURED FROM AT LEAST TWO FIXED OBJECTS, CONTROLLER, AND WIRE ROUTING. THIS PLAN MAY BE AN ADAPTATION OF THE IRRIGATION DESIGN WITH ANY CHANGES DRAFTED ON THIS PLAN. THE DRAWING SHALL ALSO PROVIDE A MINIMUM OF TWO (2) DIMENSIONS TAKEN FROM FIXED OBJECTS TO EACH AUTOMATIC VALVE AND MANUAL CONTROL VALVE.

ADDITIONAL SUBMITTALS

SUPPLY TO THE OWNER ALL INSTRUCTION SHEETS AND PARTS LISTS COVERING ALL OPERATING AND ELECTRICAL–RELATED EQUIPMENT, BOUND IN ONE FOLDER. FURNISH THE OWNER WITH ANY KEYS FOR LOCKABLE ITEMS ON THIS SYSTEM.

RAIN GAUGE

ASSURE THAT EACH CONTROLLER IS INTERFACED WITH A RAIN SWITCH WHICH WILL SHUT THE SYSTEM OFF IN CASE OF RAIN OR FREEZING WEATHER.

MISCELLANEOUS

ANY IRRIGATION ITEMS NORMALLY INSTALLED IN LANDSCAPE AREAS THAT ARE SHOWN OUTSIDE OF LANDSCAPE AREAS OR OUTSIDE OF THE PROPERTY LINES ARE SHOWN AS SUCH FOR GRAPHIC CLARITY ONLY. INSTALL THESE ITEMS INSIDE OF PROPERTY LINES AND IN LANDSCAPE AREAS. CONTACT THE OWNER OR LANDSCAPE ARCHITECT PRIOR TO INSTALLATION IF IN ANY DOUBT OF HEAD, LINE OR ZONE PLACEMENT.

ASSURE THAT THE SYSTEM PROVIDES 100% COVERAGE OF ALL LANDSCAPED AREAS. REPORT ANY DISCREPANCIES TO THE LANDSCAPE ARCHITECT BEFORE COMMENCING WITH THE INSTALLATION.

ALL APPLICABLE CODES SHALL TAKE PRECEDENCE OVER THESE PLANS. IT IS THE CONTRACTOR'S RESPONSIBILITY TO COMPLY WITH ALL APPLICABLE CODES.



THE LANDSCAPE ARCHITECT RESERVES THE RIGHT TO MAKE MINOR FIELD CHANGES.

FIELD ADJUST NOZZLE SELECTION LOCATIONS AND PLUMB OF SPRINKLERS AND SPACING OF DRIP TUBING TO PROVIDE PROPER COVERAGE.

DESIGN DEVELOPMENT SUBMITTAL	05–21–24	–
90% CONSTRUCTION DOCUMENTS	07–02–24	–
SITE DEVELOPMENT REVIEW	09–06–24	–
SITE DEVELOPMENT REVIEW &	12–20–24	–
BID ADDENDUM NO. 1	01–22–25	–
NOT FOR CONSTRUCTION	–	–
No.	DATE	BY



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IRRIGATION TECHNICAL SPECIFICATIONS

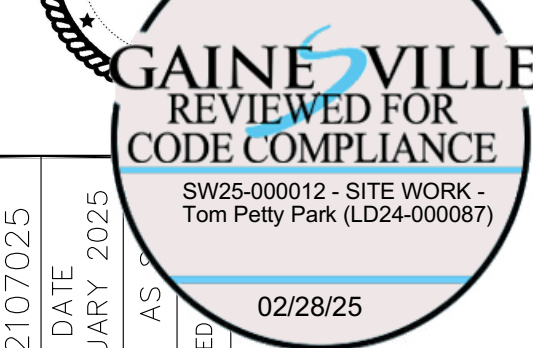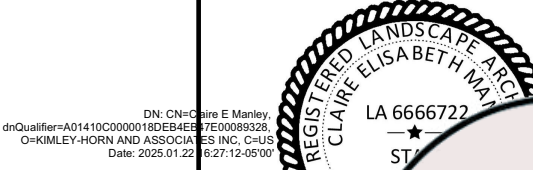
TOM PETTY PARK  
PICKLEBALL IMPROVEMENTS  
PREPARED FOR  
CITY OF GAINESVILLE  
WILD SPACES & PUBLIC PLACES  
FLORIDA  
GAINESVILLE

SHEET NUMBER  
**L3.08**

501 NE 16th AVENUE  
GAINESVILLE, FL 32601



— PROJECT LOCATION: TOM PETTY PARK

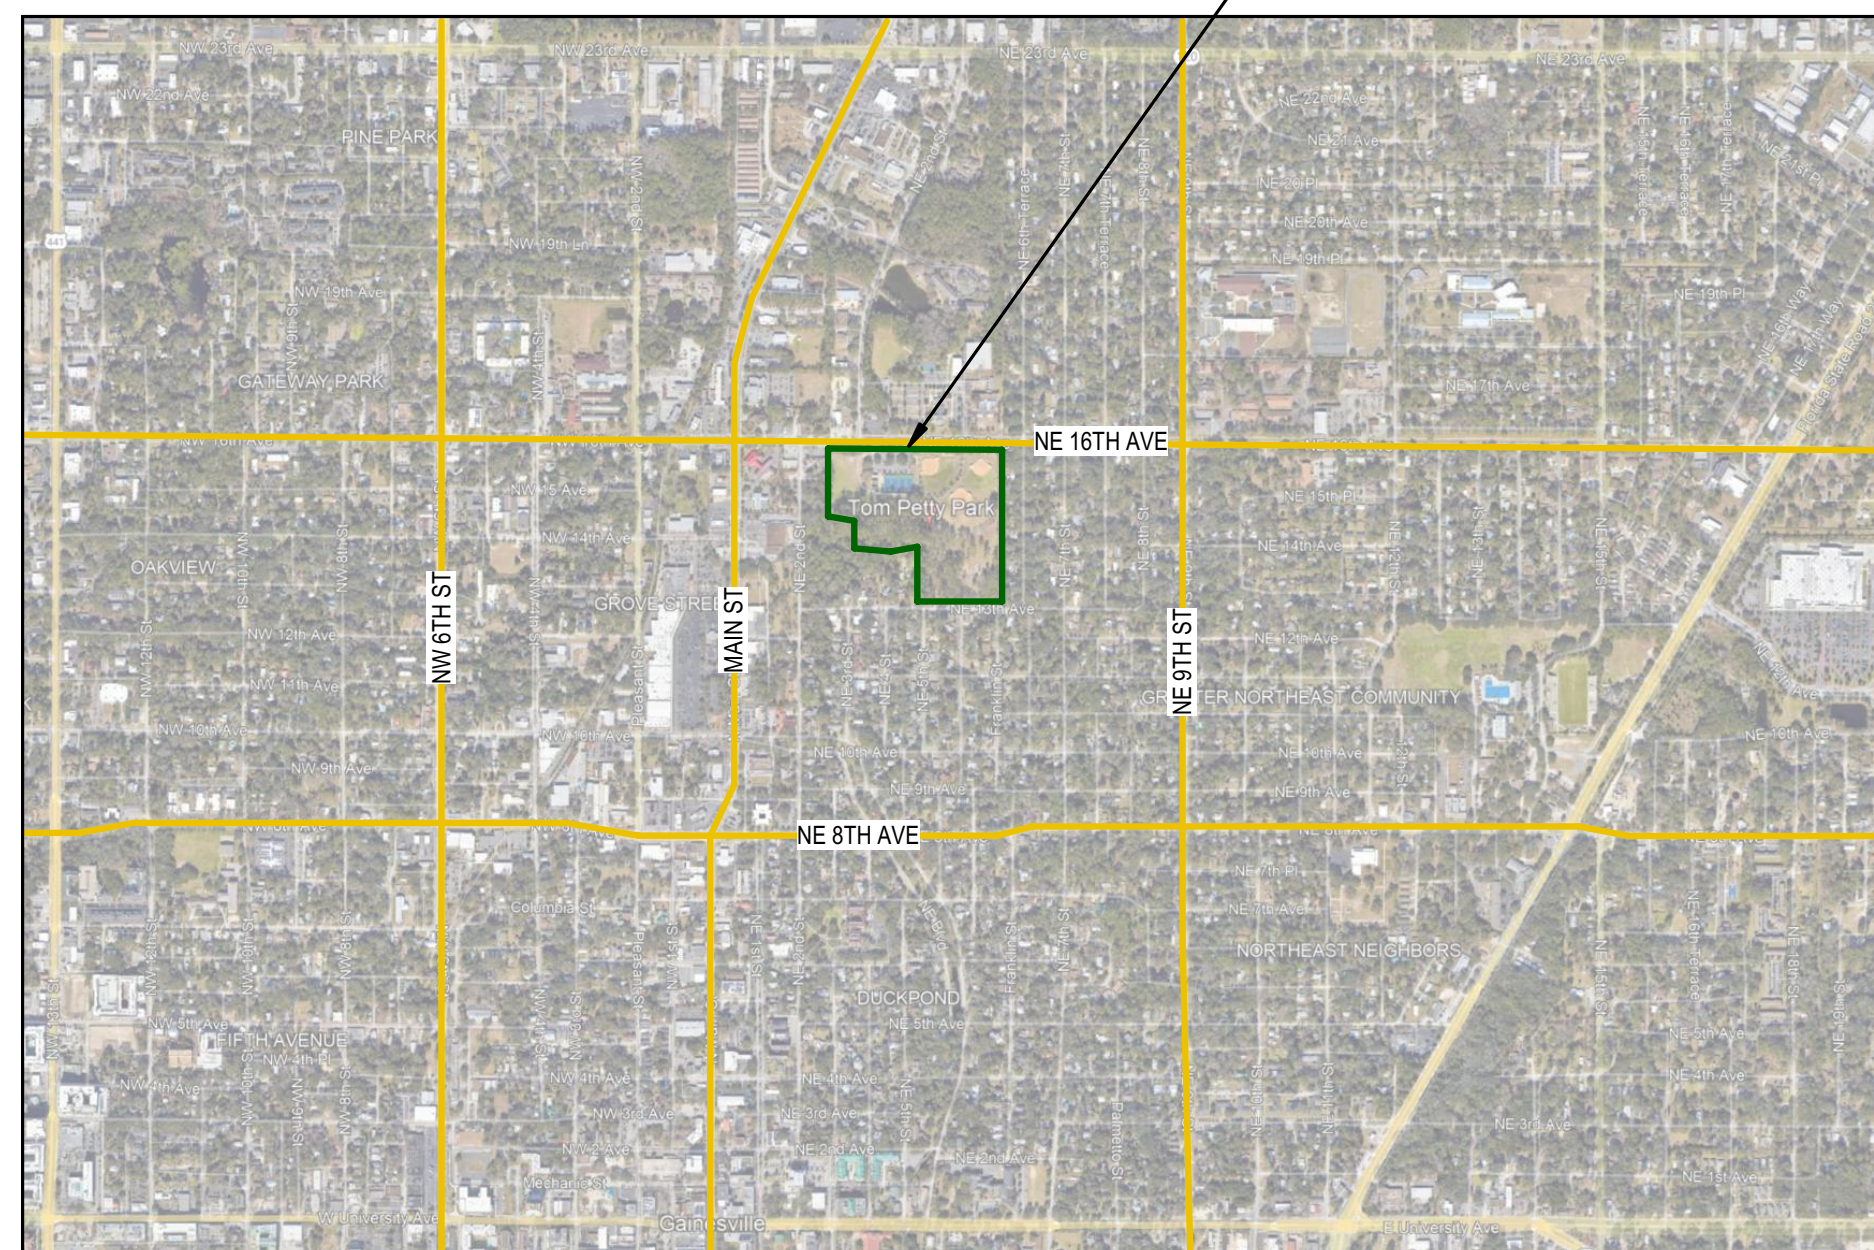


Sheet List	
G001	COVER
E001	ELECTRICAL LEGEND, CODES, & ABBREVIATIONS
E101	ELECTRICAL PHOTOMETRIC PLAN

Andrew McCaddin  
Div 26  
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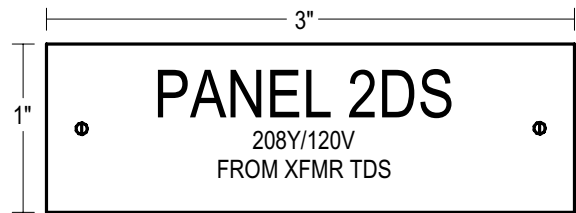
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### 1 BURIED CONDUIT DETAIL


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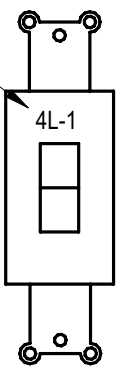
PROVIDE ENGRAVED PLASTIC TAG WITH 1/4" HIGH LETTERS.  
NORMAL POWER: BLACK LETTERS ON WHITE BACKGROUND.  
DIMENSIONS SHOWN ARE MINIMUM.

### 2 ELECTRICAL EQUIPMENT LABELING DETAIL

NOT TO SCALE

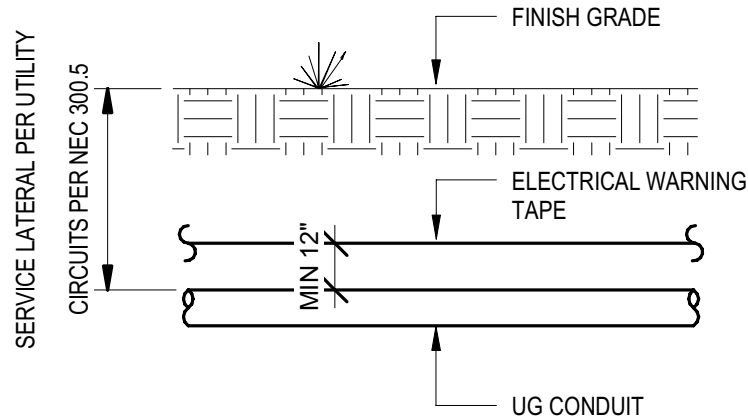

RECEPTACLE WITH COVERPLATE REMOVED

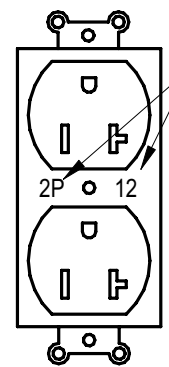

SWITCH WITH COVERPLATE REMOVED

### 3 ELECTRICAL WIRING DEVICE LABEL DETAIL

NOT TO SCALE

## LEGEND

### RECEPTACLE:

- ①② DUPLEX RECEPTACLE. 18" AFF UNO.
- ③ SPECIAL PURPOSE RECEPTACLE. 18" AFF UNO. COORDINATE WITH EQUIPMENT.

### RECEPTACLE SUBSCRIPTS:

- G GFCI-TYPE RECEPTACLE.
- GCB GFCI-TYPE POWER FROM BRANCH CIRCUIT BREAKER.
- WP WEATHER RESISTANT WIRING DEVICE. WP RECEPTACLES SHALL BE GFCI TYPE WITH IN-USE COVERS.
- 6-30R NEMA RECEPTACLE TYPE.

### POWER EQUIPMENT AND CONNECTIONS:

- DISTRIBUTION PANELBOARD.
- PANELBOARD.
- ELECTRICAL CONNECTION TO EQUIPMENT. SEE ELECTRICAL EQUIPMENT SCHEDULE.
- JUNCTION BOX.
- DIRECT BURY POWER POLE WITH TWO GFCI DUPLEX RECEPTACLES. BOD: PEDOC 5-54-C-HT-B-140.
- SAFETY SWITCH. MOUNT AS INDICATED. 60" TO TOP UNO.
- FUSED SAFETY SWITCH. MOUNT AS INDICATED. 60" TO TOP UNO.

### CONTROLS:

- \$ TOGGLE SWITCH. 46" AFF UNO.
- 120/277V ASTRONOMICAL TIME CLOCK. BOD: PARAGON SUNTRACKER II.

### ANNOTATIONS:

- ① ELECTRICAL SHEET NOTE.
- MECHANICAL EQUIPMENT TAG.

### GENERAL SUBSCRIPTS (APPLY TO ALL CATEGORIES):

- ELECTRICAL EQUIPMENT TAG.
- GCB FED FROM GFCI TYPE CIRCUIT BREAKER.
- 72" INDICATES HEIGHT OF FIXTURE, RECEPTACLE, BOX, CABINET, ETC. HEIGHT IS TO CENTERLINE UNLESS OTHERWISE INDICATED.
- MOCP WEATHERPROOF INSTALLATION, WITH APPROPRIATELY LISTED OR INDICATED PRODUCTS.
- ELECTRICAL HOME RUN TO PANELBOARD. UNDERLINED LABEL INDICATES PANELBOARD NAME AND CIRCUIT NUMBER. UNLESS INDICATED OTHERWISE, DEFAULT WIRING IS #12 & #12G. PROVIDE CONDUCTORS AS NEEDED FOR INDICATED SWITCHED LEGS, ZONES, ETC. SEE ELECTRICAL EQUIPMENT SCHEDULE FOR SPECIFIC CIRCUIT SIZING.

## ABBREVIATIONS

A	AMPS
AC	ALTERNATING CURRENT
AFCI	ARC FAULT CIRCUIT INTERRUPTER
AFB	ABOVE FINISHED FLOOR
AFG	ABOVE FINISHED GRADE
AIC	AMPS INTERRUPTING CAPACITY
Al	ALUMINUM
AWG	AMERICAN WIRE GAUGE
BJ	BONDING JUMPER
BOD	BASIS OF DESIGN
C	DEGREES CELSIUS
C	CONDUIT
CB	CIRCUIT BREAKER
CFCI	CONTRACTOR FURNISHED, CONTRACTOR INSTALLED
CFOI	CONTRACTOR FURNISHED, OWNER INSTALLED
CKT	CIRCUIT
Cu	COPPER
CU	CONDENSING UNIT
DC	DIRECT CURRENT
DIV	DIVISION
ECB	ENCLOSED CIRCUIT BREAKER
EGC	EQUIPMENT GROUNDING CONDUCTOR
EOR	ENGINEER OF RECORD
FSS	FUSED SAFETY SWITCH
G	GROUND
G	GFCI-TYPE (WHEN LABELING RECEPTACLES)
GCB	GFCI CIRCUIT BREAKER
GEC	GROUNDING ELECTRODE CONDUCTOR
GFCI	GROUND FAULT CIRCUIT INTERRUPTER
GFI	GROUND FAULT CIRCUIT INTERRUPTER
GND	GROUND
GRU	GAINESVILLE REGIONAL UTILITIES
LB(S)	POUND(S)
lm	LUMEN
LSI	LONG, SHORT, INSTANTANEOUS
LSIG	LONG, SHORT, INSTANTANEOUS, GROUND-FAULT
LTG	LIGHTING
LTS	LIGHTS
MCA	MINIMUM CIRCUIT AMPACITY
MCCB	MOLDED CASE CIRCUIT BREAKER
MBJ	MAIN BONDING JUMPER
MOCP	MAXIMUM OVERCURRENT PROTECTION
N1	NEMA 1
N3R	NEMA 3R
NEU	NEUTRAL
OCP	OVERCURRENT PROTECTION
OFCI	OWNER FURNISHED, CONTRACTOR INSTALLED
OFOI	OWNER FURNISHED, OWNER INSTALLED
OH	OVERHEAD
PBD	PANELBOARD
P&C	PLUG AND CORD
PQM	POWER QUALITY METER
SCCR	SHORT CIRCUIT CURRENT RATING
SCH	SCHEDULE
SBJ	SYSTEM BONDING JUMPER
SS	SAFETY SWITCH
SS	STAINLESS STEEL
SSBJ	SUPPLY SIDE BONDING JUMPER
SPD	SURGE PROTECTIVE DEVICE
SWBD	SWITCHBOARD
TBD	TO BE DETERMINED
TM	THERMAL MAGNETIC
TR	TAMPER RESISTANT
TS	TOGGLE SWITCH
TYP	TYPICAL
UG	UNDERGROUND
UNO	UNLESS NOTED OTHERWISE
USB	UNIVERSAL SERIAL BUS
V	VOLTS
VA	VOLT AMPS
W	WATTS
WP	WEATHER PROOF/WEATHER RESISTANT
WR	WEATHER PROOF/WEATHER RESISTANT
WRT	WITH RESPECT TO
WSR	WITHSTAND RATING

## CODES AND STANDARDS

ALL PROJECT WORK SHALL BE GOVERNED BY AND ADHERE TO THE FOLLOWING CODES AND STANDARDS.


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- FLORIDA BUILDING CODE - EIGHTH EDITION (2023) - ENERGY CONSERVATION
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- GRU ENERGY DELIVERY SERVICE GUIDE
- CITY OF GAINESVILLE LAND DEVELOPMENT CODE

DESIGN DEVELOPMENT SUBMITTAL	05-21-24	---	BY
90% CONSTRUCTION DOCUMENTS	07-02-24	---	
SITE DEVELOPMENT REVIEW	09-06-24	---	
RESUBMITTAL #1	12-20-24	---	
SITE DEVELOPMENT REVIEW &	---	---	
BID ADDENDUM NO. 1	01-22-25	---	
NOT FOR CONSTRUCTION	---	---	
NO.	DATE	REVISIONS	



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This form has been digitally signed and sealed by:  
Andrew McCarty  
Professional Engineer  
No. 83574  
State of Florida  
2025.01.22 10:12:00

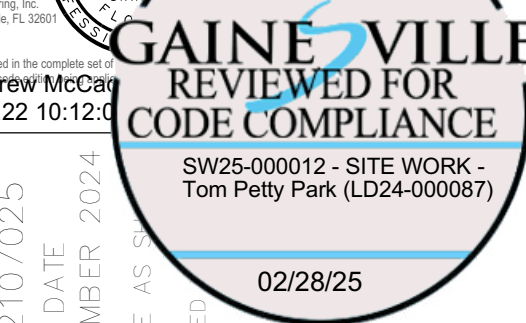

ELECTRICAL LEGEND, CODES, & ABBREVIATIONS

TOM PETTY PARK  
PICKLEBALL IMPROVEMENTS  
PREPARED FOR  
CITY OF GAINESVILLE  
WIL SPACES & PUBLIC PLACES  
FLORIDA  
GAINESVILLE

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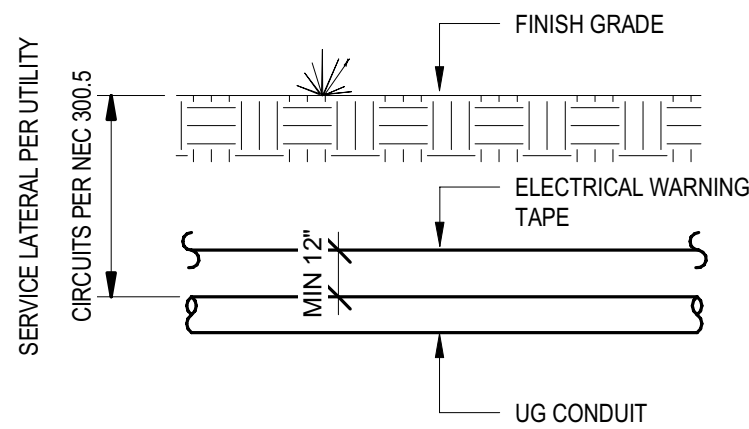
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FL License EB-31501, p.352,745,3991  
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SHEET NUMBER

**E001**





2 SIMILAR BOLLARD AT DEPOT PARK  
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


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## LEGEND

### POWER EQUIPMENT AND CONNECTIONS:

-  PANELBOARD.  
 IN GRADE HANDHOLE.


### CONTROLS:

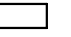-  TOGGLE SWITCH. 48" AFF UNO.  
 120/277V ASTRONOMICAL TIME CLOCK. BOD: PARAGON SUNTRACKER II.  
 120/277V 20A PHOTOCELL.
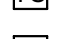
### ANNOTATIONS:

-  ELECTRICAL SHEET NOTE.

### GENERAL SUBSCRIPTS (APPLY TO ALL CATEGORIES):

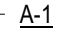- 2P1A** ELECTRICAL EQUIPMENT TAG.  
GCB FED FROM GFCI TYPE CIRCUIT BREAKER.  
72" INDICATES HEIGHT OF FIXTURE, RECEPTACLE, BOX, CABINET, ETC. HEIGHT IS TO CENTERLINE UNLESS OTHERWISE INDICATED.  
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- ELECTRONICS INDUSTRY ALLIANCE (EIA)
- GRU ENERGY DELIVERY SERVICE GUIDE
- CITY OF GAINESVILLE LAND DEVELOPMENT CODE

## GRU PLANNING AND INSPECTIONS

- WORK SHALL BE PLANNED AND COORDINATED WITH GRU PRIOR TO COMMENCEMENT. BEFORE BACKFILL AND CONCRETE POURING, INSTALLATION SHALL BE INSPECTED AND APPROVED BY GRU. GRU INSPECTION MAY INCLUDE, BUT IS NOT LIMITED TO, DEPTH OF COVER AND LOCATION OF CONDUITS, RISERS, PULLBOX INSTALLATION, CONCRETE BASE FRAMING, ETC.

## LOCATES AND UG WORK

- PRIOR TO ANY WORK PROVIDE LOCATES ALONG TRENCHING AND DIRECTIONAL BORING PATHS.
- PROVIDE MANUAL DIGGING WHERE MECHANICAL DIGGING POSES RISK OF DAMAGE TO EXISTING UG UTILITIES.

## NARRATIVE

- 5' BOLLARD LUMINAIRES TO BE INSTALLED ALONG PAVED NORTH-SOUTH PATHWAY IN TOM PETTY PARK, FROM NE 13TH AVE TO PARKING LOT OFF OF NE 16TH AVE.
- LUMINAIRES TO BE POWERED FROM PANELBOARD IN RESTROOM BUILDING AND CONTROLLED BY PHOTOCELL AND TIMECLOCK AT RESTROOM BUILDING.
- FOOT-CANDLE CALCULATIONS SHOWN ALONG PATHWAY AND FOR SOUTHERN PROPERTY LINES ALONG ROAD AND RESIDENCE.
- ALL FIXTURES ARE FULL CUTOFF LESS THAN 1800 LUMEN, PER COG 30-6.12.c.8., FIXTURES ARE EXEMPT.

## ABBREVIATIONS

A	AMPS
AC	ALTERNATING CURRENT
AFCI	ARC FAULT CIRCUIT INTERRUPTER
AFF	ABOVE FINISHED FLOOR
AFG	ABOVE FINISHED GRADE
AIC	AMPS INTERRUPTING CAPACITY
AI	ALUMINUM
AWG	AMERICAN WIRE GAUGE
BJ	BONDING JUMPER
BOD	BASIS OF DESIGN
C	DEGREES CELSIUS
C	CONDUIT
CB	CIRCUIT BREAKER
CFCI	CONTRACTOR FURNISHED, CONTRACTOR INSTALLED
CFOI	CONTRACTOR FURNISHED, OWNER INSTALLED
CKT	CIRCUIT
Cu	COPPER
CU	CONDENSING UNIT
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ECB	ENCLOSED CIRCUIT BREAKER
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EOR	ENGINEER OF RECORD
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GFI	GROUND FAULT CIRCUIT INTERRUPTER
GND	GROUND
GRU	GAINESVILLE REGIONAL UTILITIES
LB(S)	POUND(S)
Im	LUMEN
LSI	LONG, SHORT, INSTANTANEOUS
LSIG	LONG, SHORT, INSTANTANEOUS, GROUND-FAULT
LTG	LIGHTING
LTS	LIGHTS
MCA	MINIMUM CIRCUIT AMPACITY
MCCB	MOLDED CASE CIRCUIT BREAKER
MBJ	MAIN BONDING JUMPER
MOCP	MAXIMUM OVERCURRENT PROTECTION
N1	NEMA 1
N3R	NEMA 3R
NEU	NEUTRAL
OCP	OVERCURRENT PROTECTION
OFCI	OWNER FURNISHED, CONTRACTOR INSTALLED
OFOI	OWNER FURNISHED, OWNER INSTALLED
OH	OVERHEAD
PBD	PANELBOARD
P&C	PLUG AND CORD
PCM	POWER QUALITY METER
SCCR	SHORT CIRCUIT CURRENT RATING
SCH	SCHEDULE
SBJ	SYSTEM BONDING JUMPER
SS	SAFETY SWITCH
SS	STAINLESS STEEL
SSBJ	SUPPLY SIDE BONDING JUMPER
SPD	SURGE PROTECTIVE DEVICE
SWBD	SWITCHBOARD
TBD	TO BE DETERMINED
TM	THERMAL MAGNETIC
TR	TAMPER RESISTANT
TS	TOGGLE SWITCH
TYP	TYPICAL
UG	UNDERGROUND
UNO	UNLESS NOTED OTHERWISE
USB	UNIVERSAL SERIAL BUS
V	VOLTS
VA	VOLT AMPS
W	WATTS
WP	WEATHER PROOF/WEATHER RESISTANT
WR	WEATHER PROOF/WEATHER RESISTANT
WRT	WITH RESPECT TO
WSR	WITHSTAND RATING

MG

GAINESVILLE

APPROVED

engineering

DATE: 02/28/25

Sebring, FL 32601

LD24-000087

Intermittent Engineering LLC

1000 E. 10th Ave

Petty Park Pickleball

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Michael Gullledge Engineering, Inc.  
208 385 4th Ave. SE  
352 745-5889 (E88 31851)

STATE OF FLORIDA  
No. 83318  
Professional Engineer  
Andrew P. McCaddin  
2024.12.18 16:05:24-0500  
Andrew P. McCaddin  
PE - 83318

PROJECT NAME:  
CITY OF GAINESVILLE  
TOM PETTY PARK TRAIL LIGHTING

02/28/25

OWNER:  
CITY OF GAINESVILLE  
501 NE 16th AVENUE  
GAINESVILLE, FL 32601

OWNER'S PROJECT NUMBER:

MG PROJECT  
NUMBER: 24057

REVISIONS:  
REV DESC DATE

ISSUE:  
100% CONSTRUCTION  
DOCUMENTS

ISSUE DATE:  
DECEMBER 18, 2024


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APM

SHEET TITLE:  
ELECTRICAL  
LEGEND, CODES, &  
ABBREVIATIONS  
SHEET NUMBER:

E001


NO SIGNIFICANT CONFLICTS WITH LANDSCAPING ARE ANTICIPATED. NO SIGNIFICANT GRADE CHANGES ARE ANTICIPATED.

PBL PureForm bollard 04/24 page 1 of 4

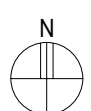
$$1'' = 30'-0''$$

NOTES:

1. SUBMIT ALTERNATES TO A/E FOR CONSIDERATION A MINIMUM OF 10 BUSINESS DAYS PRIOR TO BID. SUBMIT FIXTURE "CUT SHEET", INDICATING ALL INTENDED RATINGS AND OPTIONS.
2. A/E WILL REVIEW ALTERNATES TO DETERMINE IF THEY ARE FUNCTIONALLY, AESTHETICALLY, AND STRUCTURALLY EQUAL. A/E RESERVE THE RIGHT TO REJECT ANY FIXTURES WHICH ARE NOT DEEMED EQUAL TO THE BASIS OF DESIGN.
3. ALTERNATES REJECTED BY A/E SHALL NOT RESULT IN ADDITIONAL CHARGES TO THE OWNER.

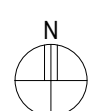
$$1'' = 30'-0''$$

TRAIL	1.27 ft	5.70 ft	0.26 ft	4.9	21.8	30-6.12.E.3.c. MINIMUM 0.2FC ON PEDESTRIAN WALKWAYS.
ROAD	0.09 ft	1.81 ft	0.00 ft	15028.2	306988.3	30-6.12.D.2.b.IV. MAXIMUM 5.0FC AT ROADWAY PROPERTY LINE.

PROJECT NAME:

OWNER:  
CITY OF GAINESVILLE  
501 NE 16th AVENUE  
GAINESVILLE, FL 32601

OWNER'S PROJECT NUMBER

MG PROJECT		REVISIONS
NUMBER: 24057		
V	DESC	DATE

ISSUE  
100% CONSTRUCTION  
DOCUMENTS

ISSUE DATE  
DECEMBER 18, 2024

CHECKED BY  
APM

SHEET TITLE  
ELECTRICAL  
PHOTOMETRIC PLANS

SHEET NUMBER

# E101

DESIGN DEVELOPMENT SUBMITTAL	05-21-24	BY
90% CONSTRUCTION DOCUMENTS	07-02-24	
SITE DEVELOPMENT REVIEW	09-06-24	
RESUBMITTAL #1	12-20-24	
SITE DEVELOPMENT REVIEW &		
BID ADDENDUM NO. 1	01-22-25	
NOT FOR CONSTRUCTION		
NO.	DATE	REVISIONS

SHEET NOTES

- 480Y/277V 3 PHASE PAD MOUNT UTILITY TRANSFORMER. PROVIDE PAD, CONDUITS, ETC PER GRU EDSG. COORDINATE ALL WORK WITH GRU.
- PROVIDE 480Y/277V 400A NEMA 3R MCB PANELBOARD. MOUNT ON CONCRETE POST AND STRUT RACK NEXT TO NEW TRANSFORMER.
- PROVIDE 75kVA NEMA 3R 480Y/277V PRIMARY 208Y/120V SECONDARY.
- PROVIDE 208Y/120V 3 PHASE 4 WIRE 225A NEMA 3R MCB PANELBOARD. MOUNT ON UNISTRUT RACK.
- PROVIDE MILBANK U5200-XL-75 125A SINGLE SIDED POWER PEDESTAL. PROVIDE 3# 3, 1#6G IN 1-1/2" C FROM 2DS.
- EXISTING GRU PRIMARY METER, EXISTING PANELBOARD, AND EXISTING SITE TRANSFORMER TO REMAIN.
- INSTALL POWER PEDESTAL NEAR SEATING AREA.
- SELF-CONTAINED METER WITH MANUAL LEVEL BYPASS PER GRU EDSG.
- PROVIDE TWO TIME CLOCKS FOR CONTROL OF ELECTRICAL POWER PEDESTALS. COORDINATE ON/OFF TIMES WITH OWNER. BOD INTERMATIC ET2845CR. RESTROOM BUILDING IS BEING REPLACED UNDER SEPARATE PROJECT. COORDINATE DURING CONSTRUCTION FOR INSTALLATION ON NEW BUILDING.
- N3R FSS 200/200/3.
- COORDINATE WITH SPORTS LIGHTING SCOPES AND ENSURE CONDUITS ARE PRESENT PRIOR TO CONCRETE/HARDSCAPE PREPARATION.
- CONNECT TO A NEW 1P 20A CIRCUIT BREAKER IN EXISTING RESTROOM PANEL ROUTE THROUGH NEW TIME CLOCK AT RESTROOM BUILDING. PROVIDE NEW TIME CLOCK AT RESTROOM BUILDING. BOD INTERMATIC ET2845CR.


SITE AND COURT LIGHTING NOTE

LIGHT FIXTURES, POLES, AND THEIR ASSOCIATED CIRCUITS ARE PART OF A SEPARATE DESIGN. SEE LIGHTING DRAWINGS (PROVIDED BY OTHERS) FOR FIXTURE LOCATIONS, SPECIFICATIONS, CONTROLS, AND CIRCUIT REQUIREMENTS. SERVICE, FEEDERS, AND EQUIPMENT HAVE BEEN SIZED TO ACCOMMODATE THESE LOADS. COORDINATE EXACT SCOPE PRIOR TO BIDDING/PRICING.

SPORTS LIGHTING CIRCUIT SIZING

SEE CIVIL PLANS FOR SPORTS LIGHTING CIRCUIT ROUTES. THE FOLLOWING ARE BASED ON TOTAL WIRE LENGTH FROM THE PANELBOARD TO THE FARTHEST POLE CABINET. THIS INCLUDES RISERS, FOR FEEDS TRAVELING FROM POLE TO POLE. THE WORST CASE (LONGEST) RUN SHALL BE CALCULATED. THESE ARE FOR MAX THREE 540W FIXTURES PER PHASE, AND 480V THREE PHASE.

UP TO 600': 4#10 CU & #10 CU GROUND IN 1-1/2" CONDUIT.  
UP TO 900': 4#8 CU & #8 CU GROUND IN 1-1/2" CONDUIT.  
UP TO 1500': 4#6 CU & #6 CU GROUND IN 1-1/2" CONDUIT.

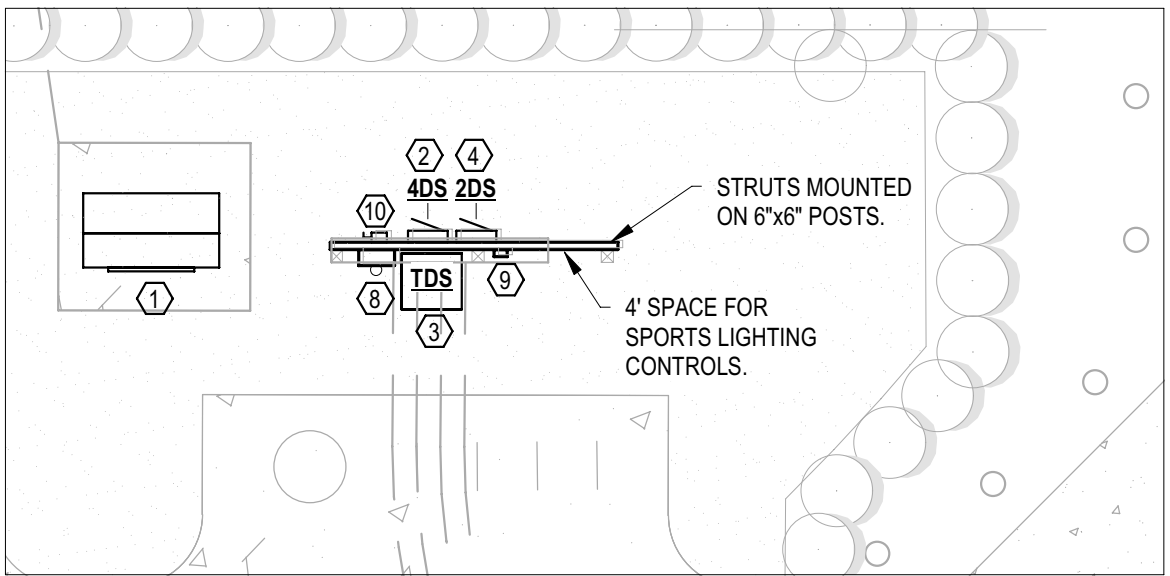

ENLARGED SERVICE AREA

1/8" = 1'-0"

MG  
mitchell • gullledge  
engineering

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www.mitchellgullledge.com MG#24005

Kimley»Horn  
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GAINEVILLE REVIEWED FOR CODE COMPLIANCE  
SW25-000012 - SITE WORK  
Tom Petty Park (LD24-000087)  
02/28/25

ELECTRICAL SITE PLAN

TOM PETTY PARK  
PICKLEBALL IMPROVEMENTS  
PREPARED FOR  
CITY OF GAINESVILLE  
WIL SPACES & PUBLIC PLACES  
FLORIDA  
GAINESVILLE

SHEET NUMBER  
E101

DEFINED ROOT PLATE AREA

OBSERVED PRIMARY ROOT ZONE

TO GRU POLE 480V ACROSS STREET ON CORNER OF NE 16TH AVE & NE 2ND STREET.

30" RCP INV: 179.9'

30" RCP INV: 180.1'

PROJECT LIMITS, TYP.

\*LIVO

008 34" LIVO

009 24" LIVO

PROVIDE 2-20" GROUND RODS. SEE SINGLE LINE DIAGRAM.

2  
E101

PROJECT LIMITS, TYP.

010 18" LIVO

011 37" LIVO

012 20" LIVO

014 28" LIVO

013 30" LIVO

015 33" LIVO

017 13" MAP

016 13" LIVO

EXISTING ASPHALT PARKING

EXISTING TENNIS COURTS

019 29" LIVO

020 43" LIVO

2DS-4 VIA TC

2DS-6 VIA TC

040 10" PIN

041 24" PIN


032 19" OAK

030 27" WAO

031 15" LAO

028 8" OAK

027 29" WAO


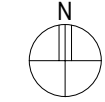


ELECTRICAL NORTH SITE PLAN

1" = 20'-0"



SINGLE LINE DIAGRAM LEGEND

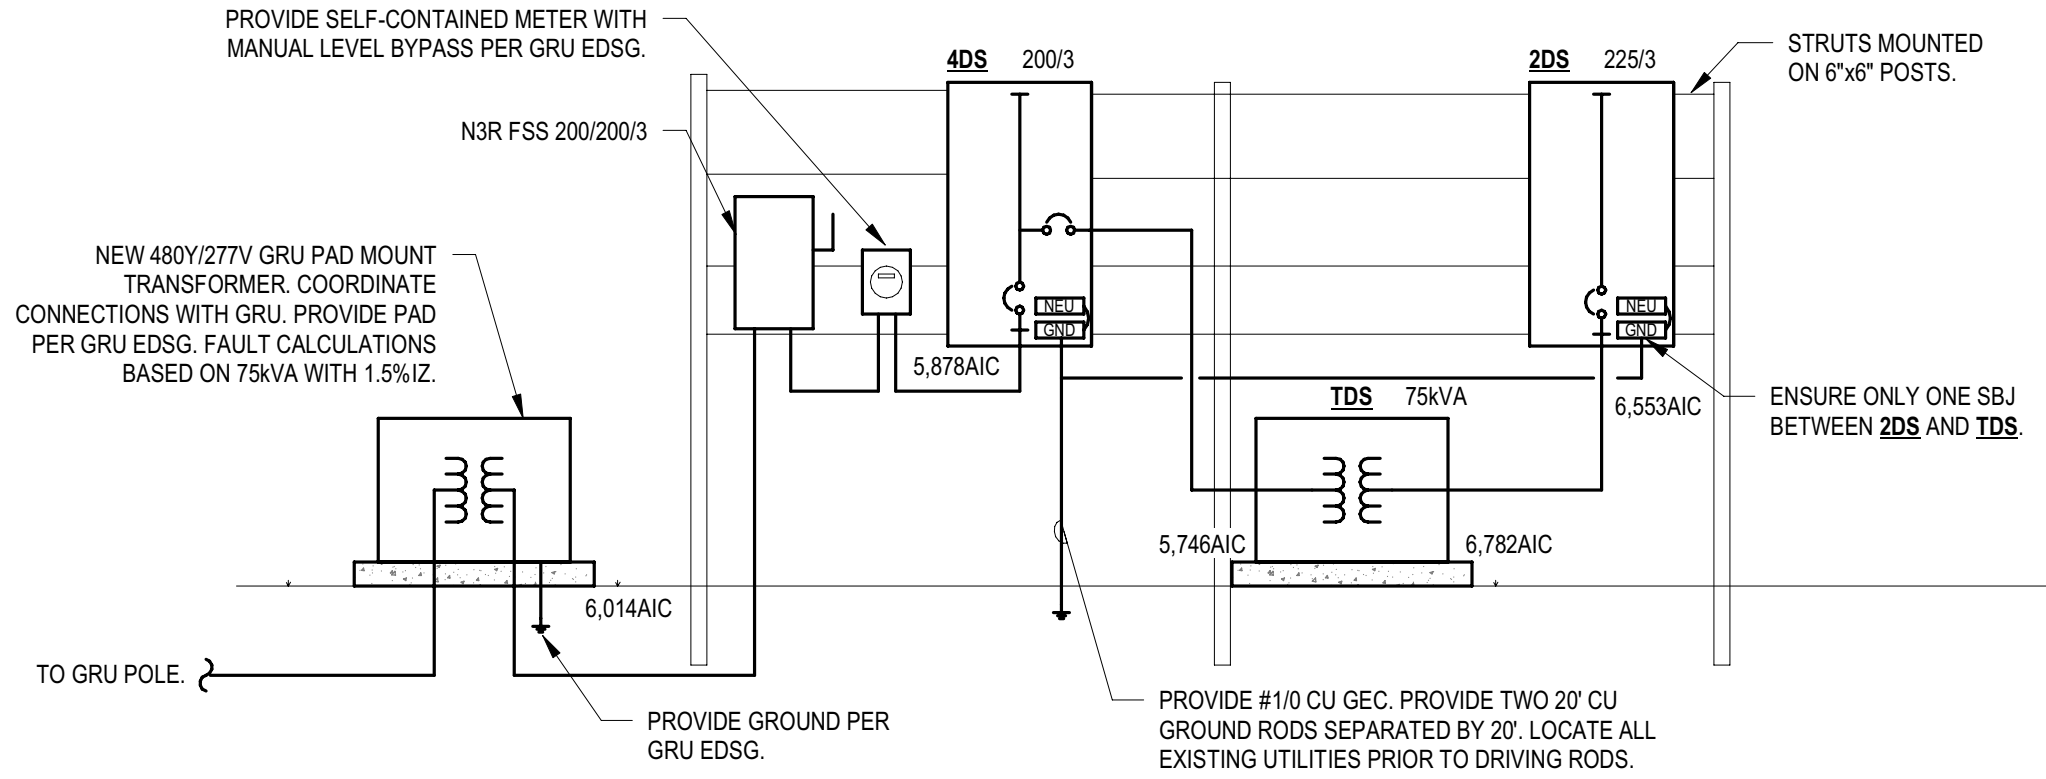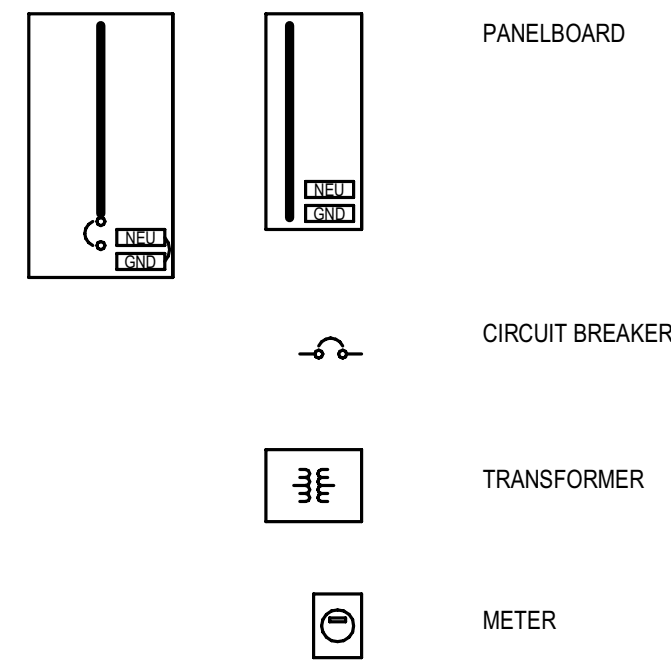

ELECTRICAL SINGLE LINE DIAGRAM

Branch Panel: 4DS

Location: 480/277 Wye  
Supply From: MCB Rating: 200 A  
Mounting: SURFACE Phases: 3  
Enclosure: NEMA 3R Wires: 4  
Basis of Design: SQUARE D NF A.I.C. Rating: 10,000  
Service Rated: YES SPD: 50kA  
Pole Spaces: 42 PQM: NO  
Feeder Phase Conductor: 3 #3/0  
Feeder Neutral Conductor: 3 #3/0  
Feeder Ground Conductor: 1 #6  
Feeder Conduit: 2"  
Number of Parallel Runs: 1

Notes:  
PROVIDE MANUFACTURER'S INTEGRATED SPD.

CKT	Circuit Description	Trip	Poles	A	B	C	A	B	C	Poles	Trip	Circuit Description	CKT
1				16400 VA			1468 VA					SPARE (1)	2
3	2DS VIA TDS	125 A	3		9060 VA			1468 VA		3	30 A		4
5						8920 VA			1468 VA				6
7	SPACE ONLY	--	1	--			1468 VA						8
9	SPACE ONLY	--	1	--			1468 VA			3	30 A		10
11	SPACE ONLY	--	1	--			1468 VA						12
13	SPACE ONLY	--	1	--			1468 VA						14
15	SPACE ONLY	--	1	--			1468 VA			3	30 A		16
17	SPACE ONLY	--	1	--			1468 VA						18
19	SPACE ONLY	--	1	--			1468 VA						20
21	SPACE ONLY	--	1	--			1468 VA			3	30 A		22
23	SPACE ONLY	--	1	--			1468 VA						24
25	SPACE ONLY	--	1	--						1	--	SPACE ONLY	26
27	SPACE ONLY	--	1	--						1	--	SPACE ONLY	28
29	SPACE ONLY	--	1	--						1	--	SPACE ONLY	30
31	SPACE ONLY	--	1	--						1	--	SPACE ONLY	32
33	SPACE ONLY	--	1	--						1	--	SPACE ONLY	34
35	SPACE ONLY	--	1	--						1	--	SPACE ONLY	36
37	SPACE ONLY	--	1	--			0 VA						38
39	SPACE ONLY	--	1	--				0 VA					40
41	SPACE ONLY	--	1	--					0 VA	3	60 A	SPD	42
Total Load:				22272 VA			14932 VA						
Total Amps:				80 A			54 A						

Load Classification	Connected Load	Demand Factor	Estimated Demand	Panel Totals
Lighting	500 VA	125.00%	625 VA	
Receptacle	1080 VA	100.00%	1080 VA	Total Conn. Load: 51996 VA
Spare	17616 VA	100.00%	17616 VA	Total Est. Demand: 50481 VA
FOOD TRUCK	32800 VA	95.00%	31160 VA	Total Conn. Current: 63 A
				Total Est. Demand Current: 61 A

Branch Panel: 2DS

Location: 120/208 Wye  
Supply From: TDS MCB Rating: 225 A  
Mounting: SURFACE Phases: 3  
Enclosure: NEMA 3R Wires: 4  
Basis of Design: SQUARE D NQ A.I.C. Rating: 10,000  
Service Rated: NO SPD: 50kA  
Pole Spaces: 42 PQM: NO  
Feeder Phase Conductor: 3 #4/0  
Feeder Neutral Conductor: 1 #4/0  
Feeder Ground Conductor: 1 #4  
Feeder Conduit: 2-1/2" C  
Number of Parallel Runs: 1

Notes:

CKT	Circuit Description	Trip	Poles	A	B	C	A	B	C	Poles	Trip	Circuit Description	CKT
1				8200 VA			0 VA			1	20 A	SPARE	2
3	FOOD TRUCK PEDESTAL 1	100 A	2		8200 VA			360 VA		1	20 A	POWER POLE RECEPTACLE	4
5						8200 VA			180 VA	1	20 A	POWER POLE RECEPTACLE	6
7	FOOD TRUCK PEDESTAL 2	100 A	2				0 VA			1	20 A	SPARE	8
9	LIGHTING VENDOR CONTROL PANEL	20 A	1		500 VA		0 VA		0 VA	1	20 A	SPARE	10
11	POWER POLE RECEPTACLE	20 A	1			540 VA		0 VA	0 VA	1	20 A	SPARE	12
13	SPARE	20 A	1	0 VA			0 VA		0 VA	1	20 A	SPARE	14
15	SPARE	20 A	1		0 VA		0 VA		0 VA	1	20 A	SPARE	16
17	SPARE	20 A	1		0 VA		0 VA		0 VA	1	20 A	SPARE	18
19	SPARE	20 A	1	0 VA		0 VA	0 VA		0 VA	1	20 A	SPARE	20
21	SPARE	20 A	1		0 VA		0 VA		0 VA	1	20 A	SPARE	22
23	SPARE	20 A	1		0 VA	0 VA		0 VA	0 VA	1	20 A	SPARE	24
25	SPARE	20 A	1	0 VA			0 VA			1	20 A	SPARE	26
27	SPARE	20 A	1		0 VA		0 VA		0 VA	1	20 A	SPARE	28
29	SPARE	20 A	1		0 VA	0 VA		0 VA	0 VA	1	20 A	SPARE	30
31	SPARE	20 A	1	0 VA			0 VA			1	20 A	SPARE	32
33	SPARE	20 A	1		0 VA			--	--	1	--	SPACE ONLY	34
35	SPARE	20 A	1		0 VA	0 VA			--	1	--	SPACE ONLY	36
37	SPARE	20 A	1	0 VA			0 VA						38
39	SPARE	20 A	1		0 VA		0 VA		0 VA	3	60 A	SPD	40
41	SPARE	20 A	1			0 VA			0 VA				42
Total Load:				16400 VA			9060 VA						
Total Amps:				137 A			76 A						

Load Classification	Connected Load	Demand Factor	Estimated Demand	Panel Totals
Lighting	500 VA	125.00%	625 VA	
Receptacle	1080 VA	100.00%	1080 VA	Total Conn. Load: 34380 VA
FOOD TRUCK	32800 VA	95.00%	31160 VA	Total Est. Demand: 32865 VA
				Total Conn. Current: 95 A
				Total Est. Demand Current: 91 A

SHEET NOTES

- ① LOAD INCLUDED FOR SPORTS LIGHTING PER PRELIMINARY SPORTS LIGHTING DESIGN. FINAL BREAKER REQUIREMENTS FOR SPORTS LIGHTING WILL BE SPECIFIED BY THE RELEVANT SPORTS LIGHTING DESIGNS. THESE BREAKERS SHALL BE SPARE IF NOT USED BY SPORTS LIGHTING. COORDINATE AND PROVIDE AN ACCURATE PANEL DIRECTORY.

TRANSFORMER SCHEDULE

XFMR NAME	SUPPLY FROM	PRIMARY VOLTAGE	SECONDARY VOLTAGE	BASIS OF DESIGN	ENCLOSURE	kVA RATING	DESIGN %IZ	SECONDARY FAULT	OCF (A)	# OF RUNS	PHASE	PRIMARY NEUTRAL	GROUND	CONDUIT	°C RATING	OCF (A)	# OF RUNS	PHASE	SECONDARY NEUTRAL	SSBJ	CONDUIT	°C RATING	NOTES
TDS	4DS	480 DELTA	208 WYE	SQUARE D	NEMA 3R	75 kVA	3%	6.94 kA	125	1	3#1 Cu	N/A	1#6 Cu	1-1/2"	75	125	1	3#4/0 Cu	1#4/0 Cu	1#4 Cu	2-1/2"	75	

PANELBOARD INFORMATION SCHEDULE

PANEL NAME	BASIS OF DESIGN	MAINS RATING	MCB	VOLTAGE	POLE SPACE S	AIC RATING	SERVICE RATED?	ENCLOSURE	MOUNTING	NEUTRAL RATING	FEEDER AMPS	# OF RUNS	PHASE	NEUTRAL	CIRCUIT GROUND	MATERIAL	CONDUIT	°C RATING	PQM	SPD
2DS	SQUARE D NQ	225 A	225 A	208Y120V	42	10,000	NO	NEMA 3R	SURFACE	100.00%	225 A	1	3 #4/0	1 #4/0	1 #4	Cu	2-1/2" C	75°C	NO	50kA
4DS	SQUARE D NF	200 A	200 A	480V/277Y	42	10,000	YES	NEMA 3R	SURFACE	100.00%	200 A	1	3 #3/0	3 #3/0	1 #6	Cu	2"	75°C	NO	50kA




ELECTRICAL SINGLE LINE DIAGRAM & SCHEDULES

TOM PETTY PARK PICKLEBALL IMPROVEMENTS PREPARED FOR CITY OF GAINESVILLE WIL SPACES & PUBLIC PLACES

SHEET NUMBER E201





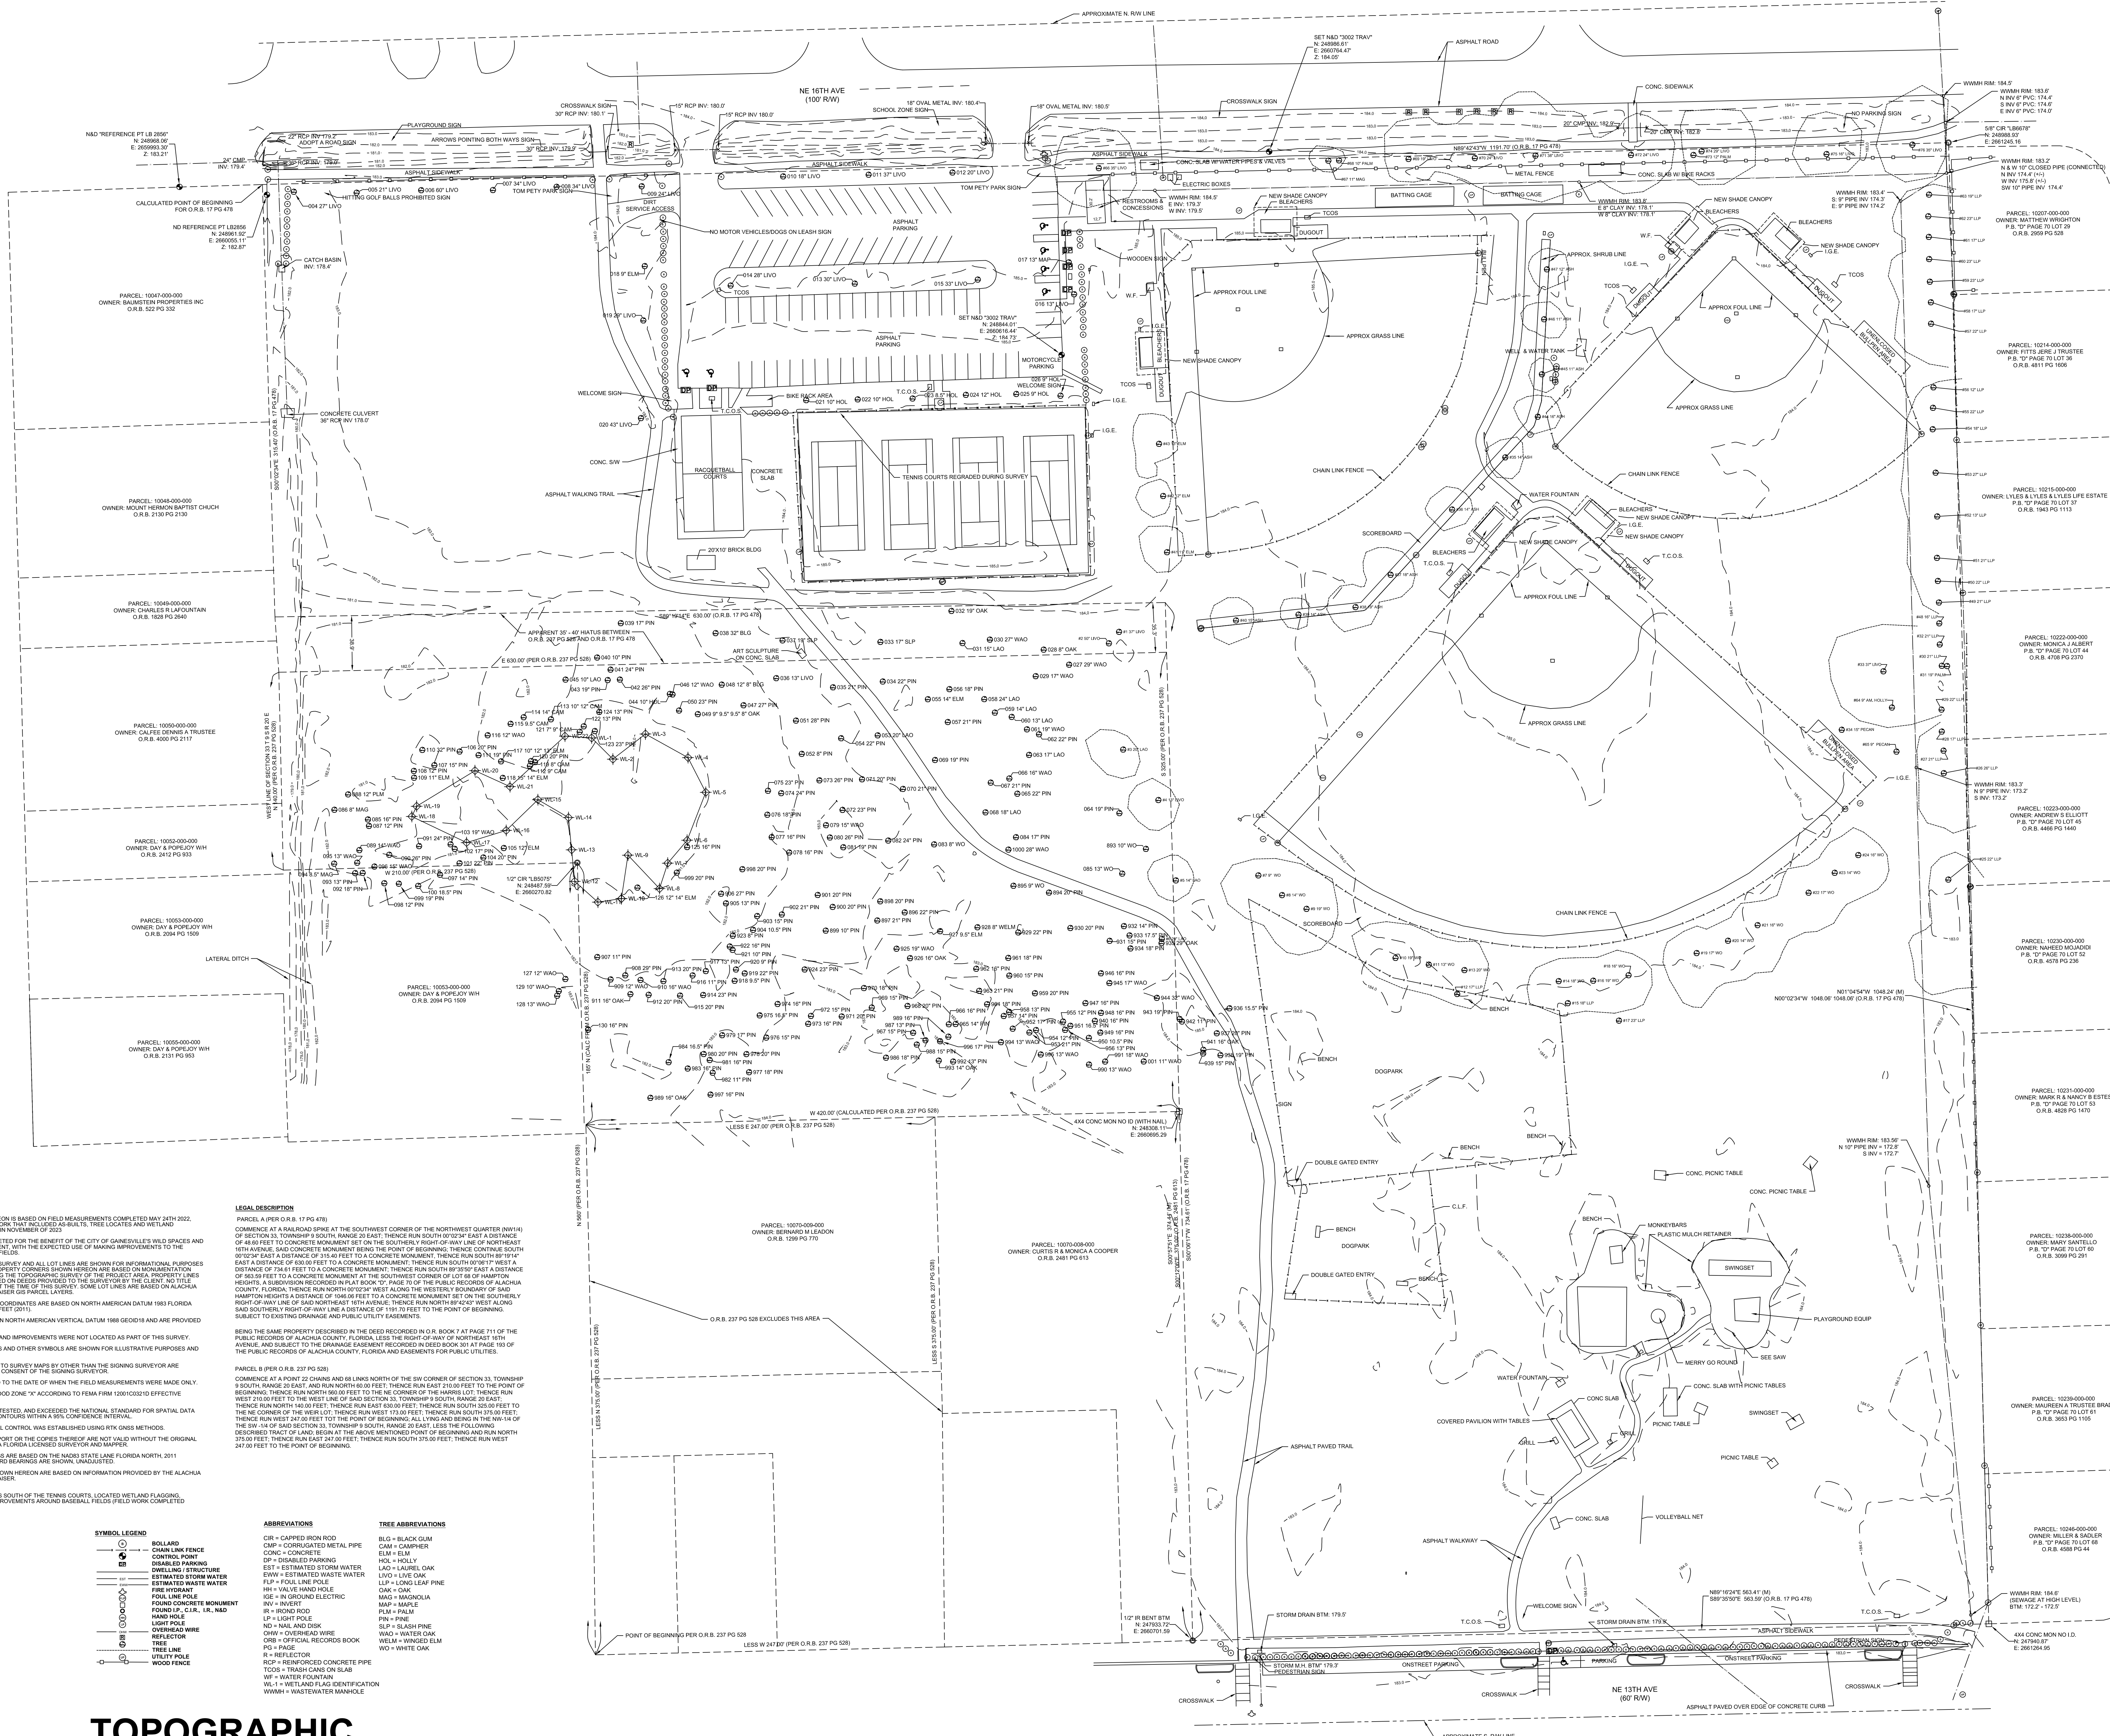

- SURVEYOR'S NOTES**
1. THE SURVEY SHOWN HEREON IS BASED ON FIELD MEASUREMENTS COMPLETED MAY 24TH 2022, WITH ADDITIONAL FIELD WORK THAT INCLUDED ADJUSTMENTS, TREE LOCATES AND WETLAND DELINEATION OCCURRING IN NOVEMBER OF 2023.
  2. THIS SURVEY WAS COMPLETED FOR THE BENEFIT OF THE CITY OF GAINESVILLE'S WILD SPACES AND PUBLIC PLACES DEPARTMENT, WITH THE EXPECTED USE OF MARKING IMPROVEMENTS TO THE BASEBALL AND SOFTBALL FIELDS.
  3. THIS IS NOT A BOUNDARY SURVEY AND ALL LOT LINES ARE SHOWN FOR INFORMATIONAL PURPOSES ONLY. ANY PRELIMINARY PROPERTY CORNERS SHOWN HEREON ARE SHOWN FOR INFORMATIONAL PURPOSES ONLY. NO FIELD MEASUREMENTS OR DATA WERE PROVIDED TO THE SURVEYOR BY THE CLIENT. NO TITLE SEARCH HAS BEEN CONDUCTED BY THE SURVEYOR. SOME LOT LINES ARE BASED ON ALACHUA COUNTY PROPERTY MAPS AND OTHER PUBLIC RECORDS. SOME LOT LINES ARE BASED ON ALACHUA COUNTY PROPERTY MAPS AND OTHER PUBLIC RECORDS.
  4. NORTHING AND EASTING COORDINATES ARE BASED ON NORTH AMERICAN DATUM 1983 (NAD 83) FLORIDA STATE PLANE NORTH U.S. FEET (2011).
  5. ELEVATIONS ARE BASED ON NORTH AMERICAN VERTICAL DATUM 1988 (GEOID 1988) AND ARE PROVIDED IN U.S. FEET.
  6. UNDERGROUND UTILITIES AND IMPROVEMENTS WERE NOT LOCATED AS PART OF THIS SURVEY.
  7. FENCES, OVERHEAD WIRES AND OTHER SYMBOLS ARE SHOWN FOR ILLUSTRATIVE PURPOSES AND ARE NOT TO SCALE.
  8. ADDITIONS OR DELETIONS TO SURVEY MAPS BY OTHER THAN THE SIGNING SURVEYOR ARE PROHIBITED WITHOUT THE CONSENT OF THE SIGNING SURVEYOR.
  9. THIS SURVEY IS CERTIFIED TO THE DATE OF WHEN THE FIELD MEASUREMENTS WERE MADE ONLY.
  10. PROPERTY RESIDES IN FLOOD ZONE "X" ACCORDING TO FEMA FIRM 12011C022D EFFECTIVE 06/30/2006.
  11. TOPOGRAPHIC DATA WAS TESTED AND EXCEEDED THE NATIONAL STANDARD FOR SPATIAL DATA ACCURACY FOR 1:50,000 SCALE WITHIN A 95% CONFIDENCE INTERVAL.
  12. HORIZONTAL AND VERTICAL CONTROL WAS ESTABLISHED USING RTK GNSS METHODS.
  13. THE SURVEY MAP AND REPORT OR THE COPIES THEREOF ARE NOT VALID WITHOUT THE ORIGINAL SIGNATURE AND SEAL OF A FLORIDA LICENSED SURVEYOR AND MAPPER.
  14. FIELD MEASURED BEARINGS ARE BASED ON THE NAD83 STATE PLANE FLORIDA NORTH, 2011 ADJUSTMENT. DEED RECORD BEARINGS ARE SHOWN UNADJUSTED.
  15. RIGHT-OF-WAY WIDTHS SHOWN HEREON ARE BASED ON INFORMATION PROVIDED BY THE ALACHUA COUNTY PROPERTY APPRAISER.
  16. REVISION HISTORY:  
16.1 22-07-21 ADDED TREES SOUTH OF THE TENNIS COURTS, LOCATED WETLAND FLAGGING, LOCATED RECENT IMPROVEMENTS TO THE BASEBALL, FIELD, FIELD PROPERTY COMPLETED 11/30/23 - B. MURPHY

**LEGAL DESCRIPTION**

PARCEL A (PER O.R.B. 17 PG 478)  
COMMENCE AT A RAILROAD SPIKE AT THE SOUTHWEST CORNER OF THE NORTHWEST QUARTER (NW1/4) OF SECTION 36, TOWNSHIP 30 SOUTH, RANGE 20 EAST, AND RUN NORTH 60.00° EAST A DISTANCE OF 48.00 FEET TO CONCRETE MONUMENT SET ON THE SOUTHERLY RIGHT-OF-WAY LINE OF NORTHEAST 16TH AVENUE, SAID CONCRETE MONUMENT BEING THE POINT OF BEGINNING, THENCE CONTINUE SOUTH 07°24' EAST A DISTANCE OF 315.00 FEET TO A CONCRETE MONUMENT, THENCE RUN SOUTH 89°19'14" EAST A DISTANCE OF 630.00 FEET TO A CONCRETE MONUMENT, THENCE RUN SOUTH 07°24' WEST A DISTANCE OF 734.61 FEET TO A CONCRETE MONUMENT, THENCE RUN SOUTH 89°35'50" EAST A DISTANCE OF 630.00 FEET TO A CONCRETE MONUMENT AT THE SOUTHWEST CORNER OF LOT 66 OF HAMPTON HEIGHTS, A SUBDIVISION RECORDED IN PLAT BOOK 107, PAGE 70 OF THE PUBLIC RECORDS OF ALACHUA COUNTY, FLORIDA, THENCE RUN NORTH 07°24' WEST ALONG THE WESTERLY BOUNDARY OF SAID HAMPTON HEIGHTS A DISTANCE OF 1546.00 FEET TO A CONCRETE MONUMENT SET ON THE SOUTHERLY RIGHT-OF-WAY LINE OF SAID NORTHEAST 16TH AVENUE, THENCE RUN NORTH 89°24' WEST ALONG SAID SOUTHERLY RIGHT-OF-WAY LINE A DISTANCE OF 1191.70 FEET TO THE POINT OF BEGINNING, SUBJECT TO EXISTING DRAINAGE AND PUBLIC UTILITY EASEMENTS.

BEING THE SAME PROPERTY DESCRIBED IN THE DEED RECORDED IN O.R. BOOK 7 AT PAGE 711 OF THE PUBLIC RECORDS OF ALACHUA COUNTY, FLORIDA, LESS THE RIGHT-OF-WAY OF NORTHEAST 16TH AVENUE, AND SUBJECT TO THE DRAINAGE EASEMENT RECORDED IN DEED BOOK 301 AT PAGE 18 OF THE PUBLIC RECORDS OF ALACHUA COUNTY, FLORIDA AND EASEMENTS FOR PUBLIC UTILITIES.

PARCEL B (PER O.R.B. 237 PG 528)  
COMMENCE AT A POINT 25 CHAINS AND 66 LINKS NORTH OF THE SW CORNER OF SECTION 33, TOWNSHIP 30 SOUTH, RANGE 20 EAST, AND RUN NORTH 60.00° EAST TO THE POINT OF BEGINNING, THENCE RUN NORTH 60.00° EAST TO THE CORNER OF THE RAILROAD LOT, THENCE RUN WEST 710.00 FEET TO THE WEST LINE OF SAID SECTION 33, TOWNSHIP 30 SOUTH, RANGE 20 EAST, THENCE RUN NORTH 18.50° WEST, THENCE RUN EAST 560.00 FEET, THENCE RUN SOUTH 525.00 FEET TO THE NE CORNER OF THE WET LOT, THENCE RUN WEST 173.00 FEET, THENCE RUN SOUTH 375.00 FEET, THENCE RUN WEST 184.00 FEET TO THE POINT OF BEGINNING, ALL WAD BEING 100 FEET, LESS THE FOLLOWING DESCRIBED TRACT OF LAND, BEGIN AT THE ABOVE MENTIONED POINT OF BEGINNING AND RUN NORTH 37.00° EAST, THENCE RUN EAST 347.00 FEET, THENCE RUN SOUTH 375.00 FEET, THENCE RUN WEST 347.00 FEET TO THE POINT OF BEGINNING.

**ABBREVIATIONS**

CR = CORRUGATED METAL PIPE  
CONC = CONCRETE  
DIP = DISABLED PARKING  
EST = ESTIMATED STORM WATER  
EWA = ESTIMATED WASTE WATER  
FLP = FOUL LINE POLE  
IN = IN-GROUND ELECTRIC  
IN- = INVERT  
IR = IRON ROD  
LP = LIGHT POLE  
ND = NAIL AND DISK  
OHW = OVERHEAD WIRE  
OR = OFFICIAL RECORDS BOOK  
PG = PAGE  
R = REFLECTOR  
RCP = REINFORCED CONCRETE PIPE  
TODS = TRASH CANS ON SLAB  
WF = WATER FOUNTAIN  
WL = WETLAND FLAG IDENTIFICATION  
WWMH = WASTEWATER MANHOLE

**TREE ABBREVIATIONS**

BLO = BLACK GLIM  
CAM = CAMERO  
ELM = ELM  
HOL = HOLLY  
LAO = LAUREL OAK  
LIV = LIVE OAK  
LIP = LONG LEAF PINE  
OAK = OAK  
MAG = MAGNOLIA  
MAP = MAPLE  
PALM = PALM  
PIN = PINE  
SLP = SLASH PINE  
WAD = WATER OAK  
WELM = WINGED ELM  
WOC = WHITE OAK

# TOPOGRAPHIC SURVEY

OF TOM PETTY PARK  
(FORMERLY NORTHEAST PARK)  
LOCATED IN GAINESVILLE, FL  
SECTION 33 TOWNSHIP 30 SOUTH RANGE 20 EAST  
ALACHUA COUNTY, FLORIDA



THE MAP OF THE PROPERTY DESCRIBED HEREON WAS MADE UNDER MY SUPERVISION AND THE MAP OF SURVEY FURTHER MEETS THE STANDARDS OF PRACTICE SET FORTH BY THE STATE OF FLORIDA BOARD OF PROFESSIONAL SURVEYORS IN CHAPTER 5-17.1, FLORIDA ADMINISTRATIVE CODE, PURSUANT TO SECTION 473.07, FLORIDA STATUTES, AND THE MAP OF SURVEY SHOWN HEREON IS A TRUE AND ACCURATE REPRESENTATION THEREOF TO THE BEST OF MY KNOWLEDGE, BEING SUBJECT TO NOTES AND NOTATIONS SHOWN HEREON.

Florida Business License No. LB8313  
Brian E. Murphy  
Professional Surveyor & Mapper No. 7033

CERTIFIED TO:

DATE: 02/13/25  
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Sheet: 1 of 1